

4A and 4B Canberra Road Toorak

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4a & 4b Canberra Rd, Toorak TOWN PLANNING APPLICATION

TP00	Cover Sheet
TP01	Aerial Photo & Streetscape
TP02	Site Analysis
TP03	Features & Levels Survey
TP04	Existing Conditions and Demolition
TP05	Design Response
TP08	Garden Area
TP10	Basement Plan
TP11	Ground Floor Plan
TP12	Level 1 Plan
TP13	Level 2 Plan
TP14	Roof Plan
TP16	Elevations - Sheet 1
TP17	Elevations - Sheet 2
TP18	Sections - Sheet 1
TP19	Sections - Sheet 2
TP20	Elevations & Sections - Ramp & Privacy Screens
TP30	Shadow Diagrams - 9am (22 Sept)
TP31	Shadow Diagrams - 12noon (22 Sept)
TP32	Shadow Diagrams - 1pm (22 Sept)
TP33	Shadow Diagrams - 2pm (22 Sept)
TP34	Shadow Diagrams - 3pm (22 Sept)

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^{Project} 4a & 4b Canberra Rd, Toorak


Drawing Status Town Planning Project No. C1802 Drawing Cover Sheet _{Date} Mar 2019

Scale at A1

Drawing No.


Revision F

D.

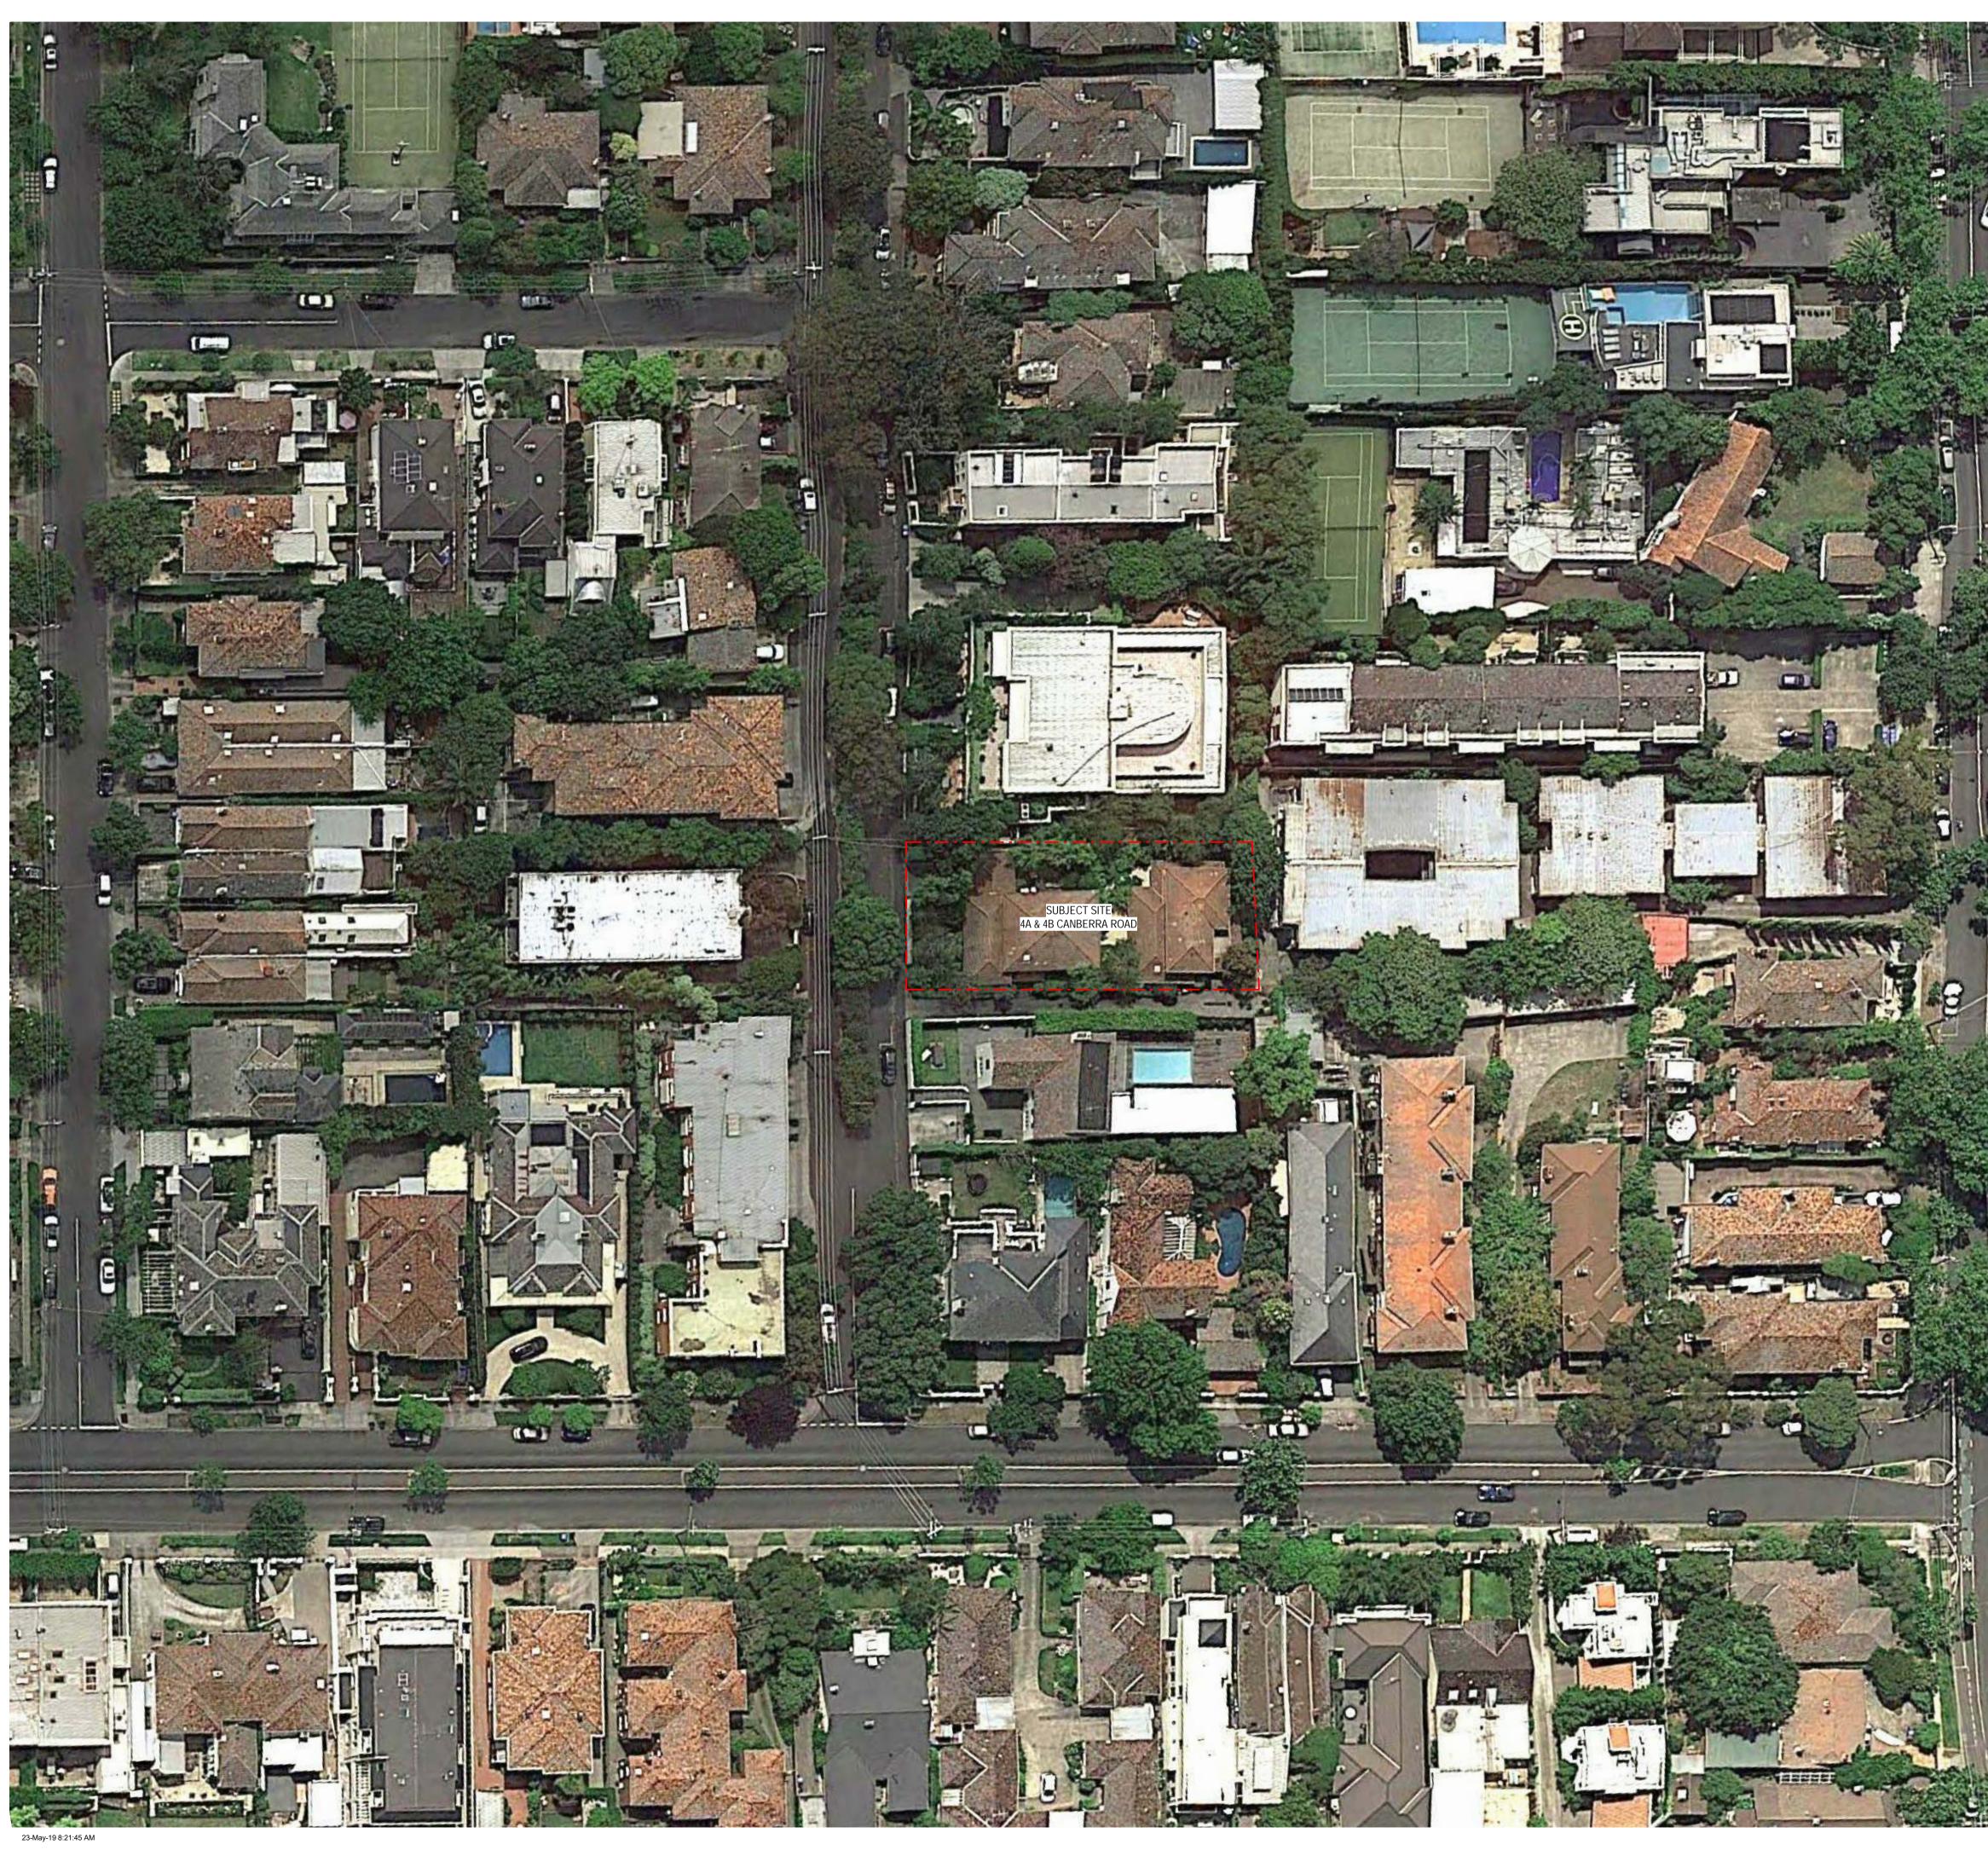

Project 4a & 4b Canberra Rd, Toorak Project No. C1802 Drawing Aerial Photo & Streetscape ^{Date} 05/16/14 Drawing Status
Town Planning Disclaimer
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THE SITE IS LOCATED WITHIN CLOSE PROXIMITY TO THE FOLLOWING COMMUNITY ASSETS.

PARKS/GARDENS/RESERVES:

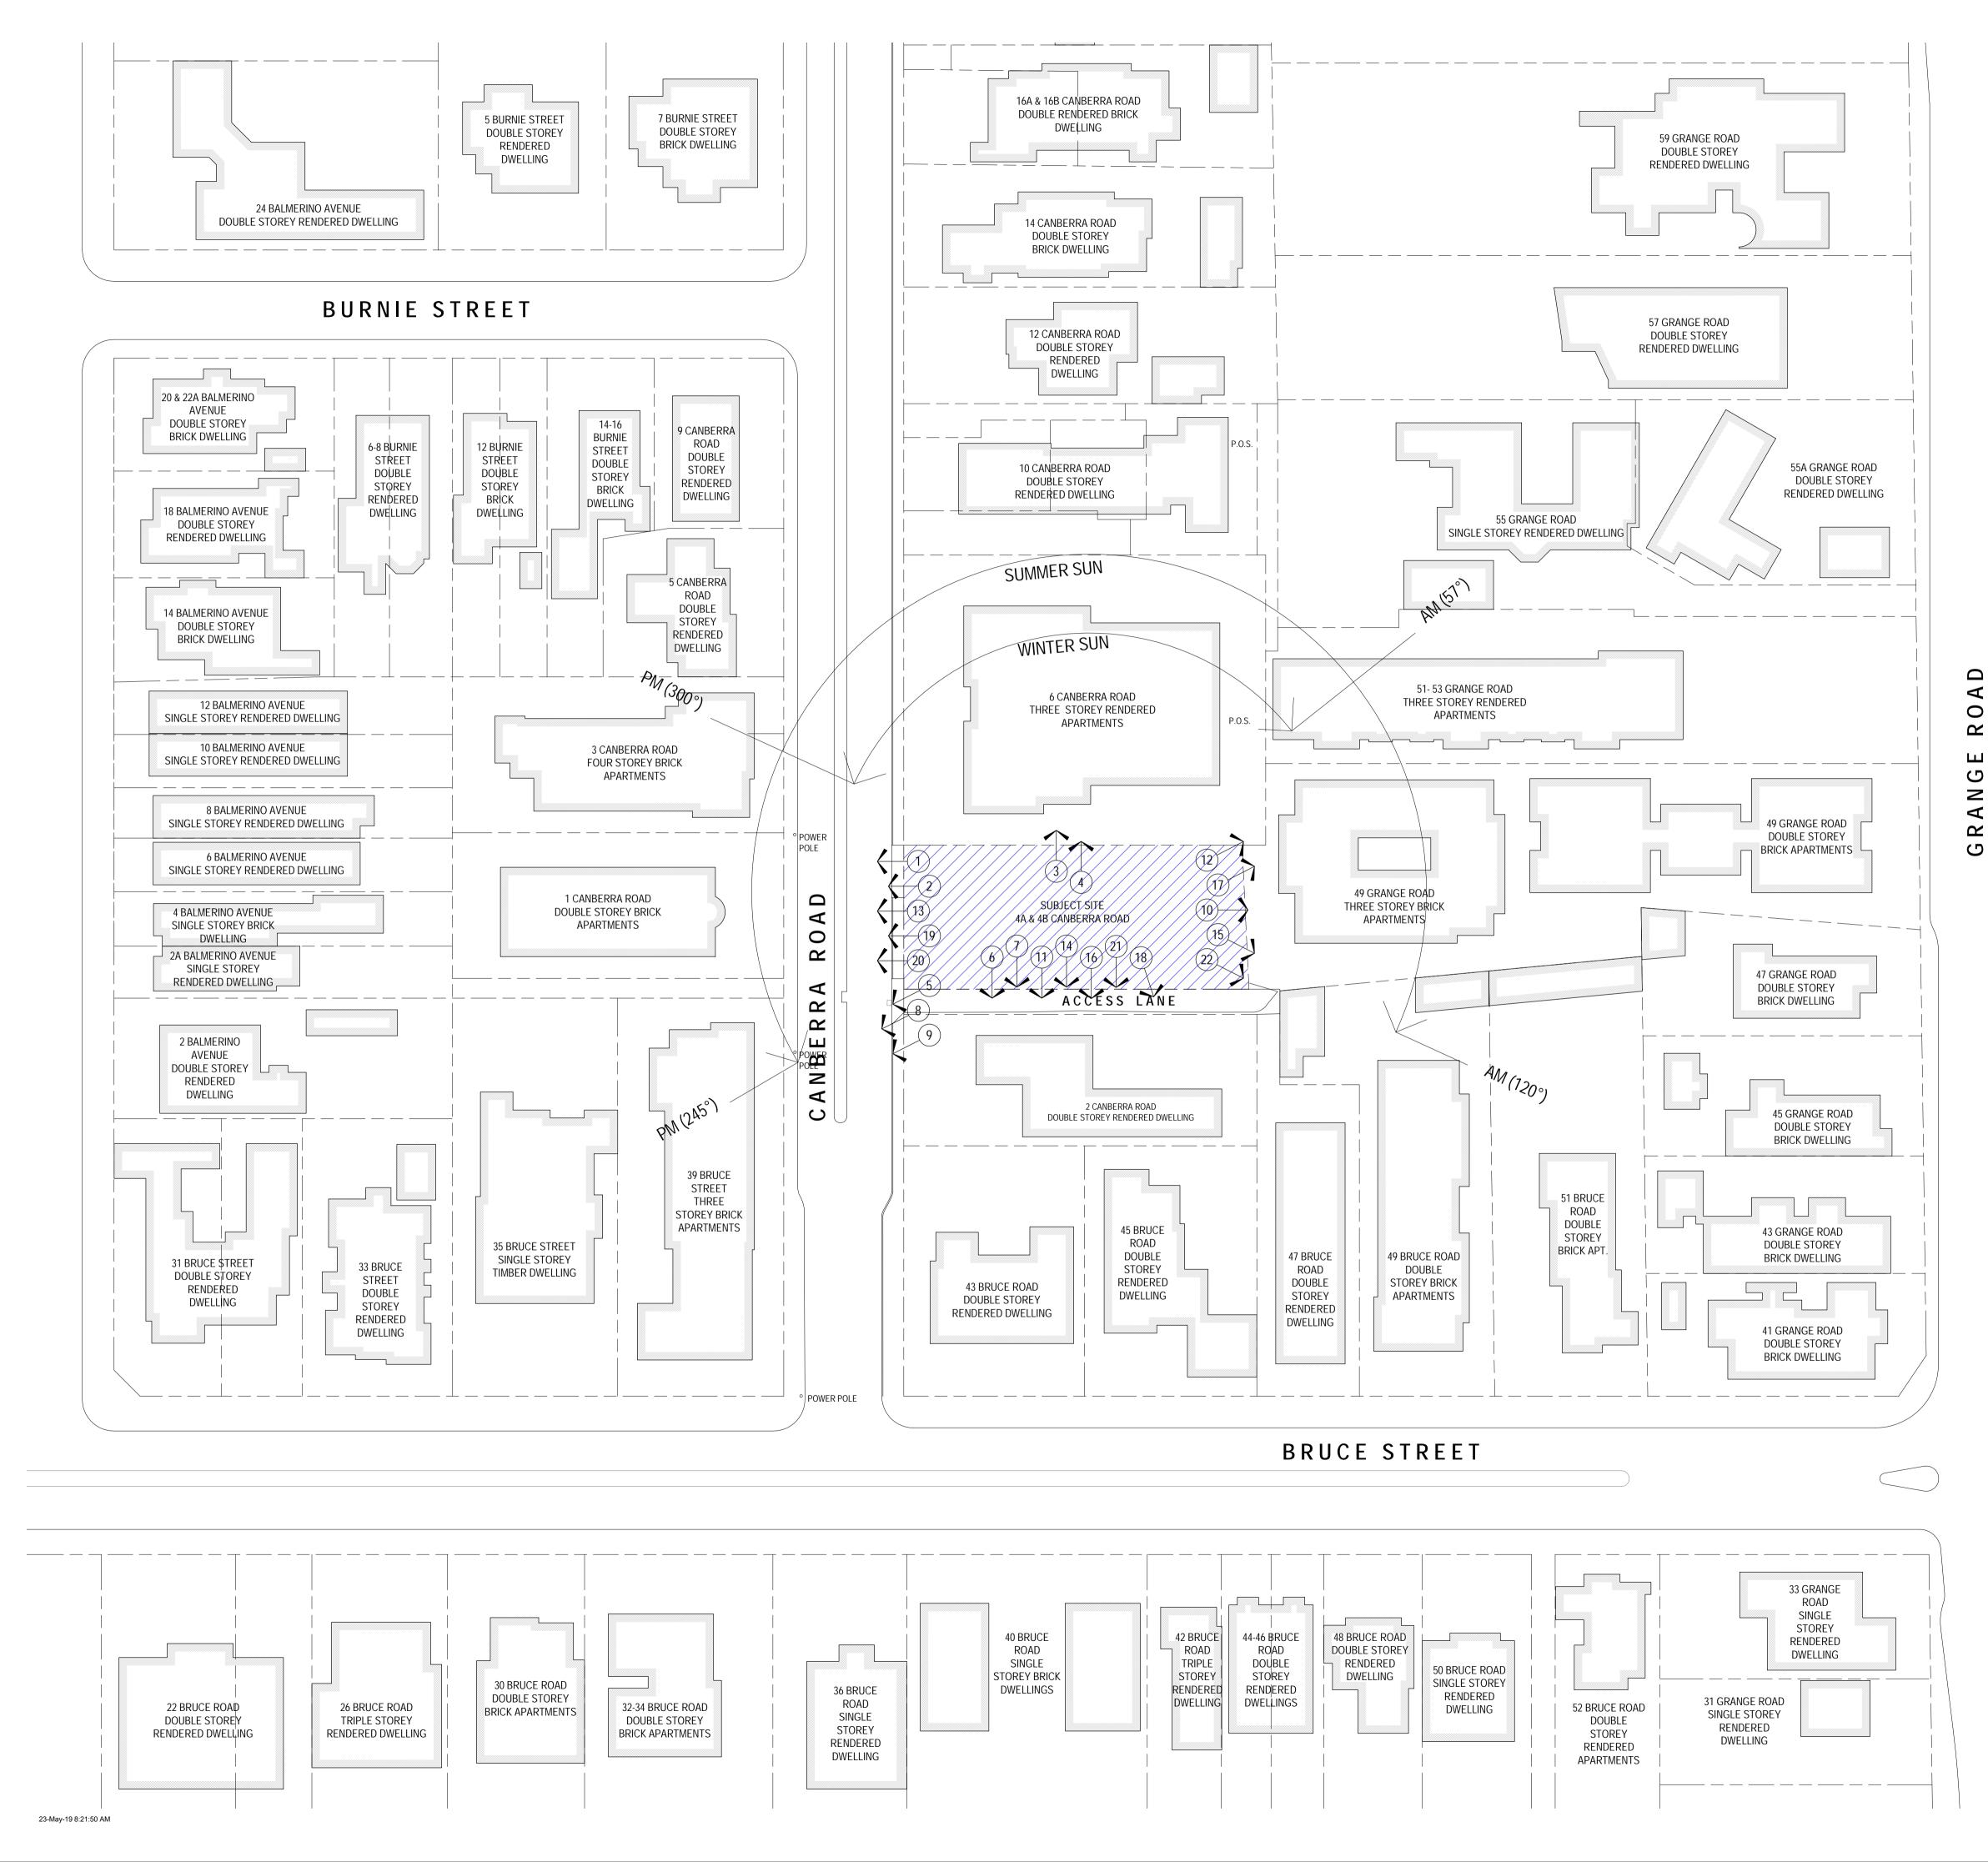- COMO HOUSE, 0.5KM WEST
- COMO PARK & COMO PARK NORTH, 0.5KM WEST
- LOY'S PADDOCK RESERVE, 0.6KM NORTH
- BURNLEY GOLF CLUB, 1.3KM NORTH ROCKLEY GARDENS, 1.3KM SOUTH WEST

SHOPPING & RETAIL PRECINCT:

- TOORAK RD RETAIL STRIP, 0.7KM SOUTH
- WOOLWORTHS SUPERMARKET, 0.7KM SOUTH
- VOGUE SHPPING CENTRE, 1.7KM EAST CHAPEL ST, 1.7KM EAST 9

EDUCATION:

- 10. ST CATHERINE'S SCHOOL, 0.9KM EAST
- 11. TOORAK PRIMARY SCHOOL, 0.9KM SOUTH
- 12. ST KEVIN'S SCHOOL 1.2KM EAST 13. MELBOURNE HIGH SCHOOL, 1.3KM WEST

PUBLIC TRANSPORT:

- BRUCE ST BUS STOP, 0.1KM SOUTH 14.
- GRANGE RD BUS STOP, 0.4KM SOUTH-EAST 15.
- TOORAK RD TRAM STOP, 0.8KM SOUTH 16.
- HEYINGTON TRAIN STATION, 1.5KM EAST 17. HAWKSBURN TRAIN STATION, 1.5KM SOUTH 18.

COMMUNITY:

- 19. ROYAL SOUTH YARRA TENNIS CLUB, 0.5KM WEST
- SOUTH YARRA CRICKET CLUB, 0.5KM WES 20.
- GEELONG GRAMMAR EARLY LEARNING CENTRE, 0.7KM 21. SOUTH
- 22. ST JOHN'S ANGLICAN KINDERGARTEN, 1.0KM SOUTH-EAST

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Project No. Project 4a & 4b Canberra Rd, Toorak C1802 Drawing Date 09/04/15 Site Analysis Drawing Status Town Planning Disclaimer 1. Do not scale drawings. Written dimensions govern. 2. All dimensions are in millimeters unless otherwise noted. 3. All dimensions are to be verified on site prior to proceeding with the work. 4. Conrad Architects are to be notified in writing of any discrepancies.

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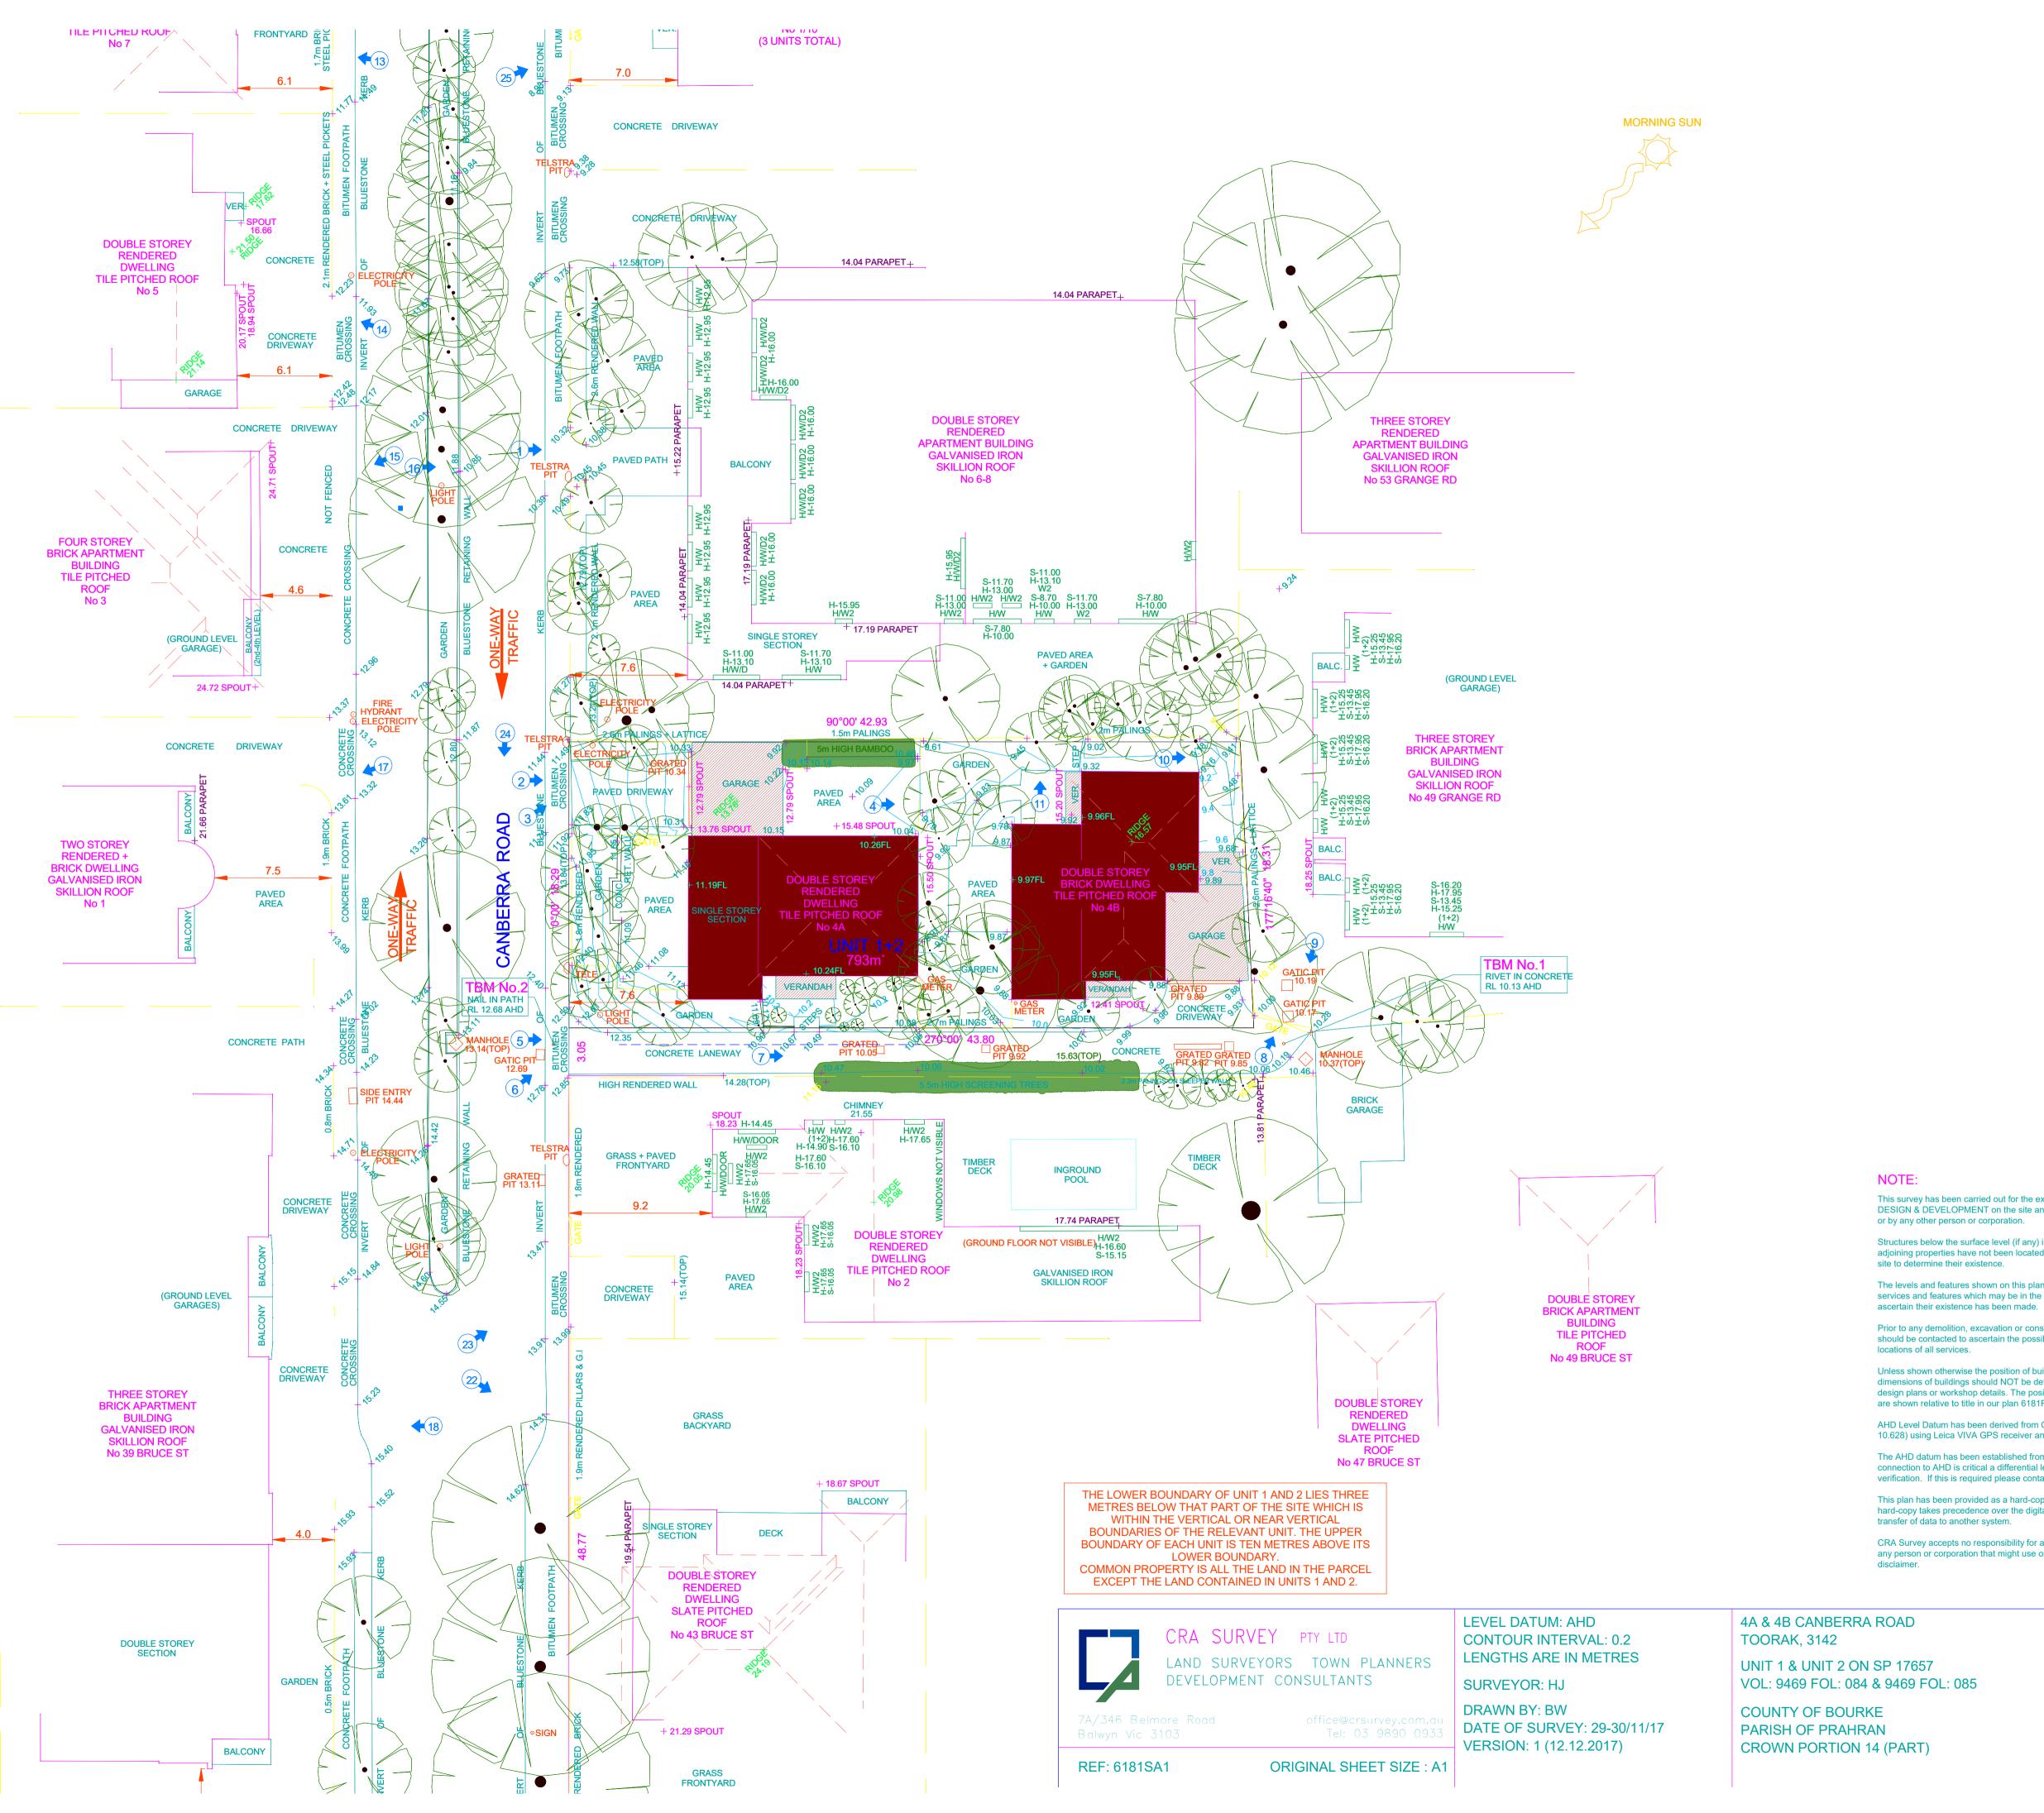
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2 G Ζ A 2



PLAN OF SITE ANALYSIS SURVEY

CRA Survey accepts no responsibility for any loss or damage howsoever suffered to any person or corporation that might use or rely on this plan in contravention of this

This plan has been provided as a hard-copy plan and also in digital format. The hard-copy takes precedence over the digital data as no guarantee can be given to

The AHD datum has been established from GPS observations only. If a precise connection to AHD is critical a differential levelling method should be used for verification. If this is required please contact the office of CRA Survey.

AHD Level Datum has been derived from GPS observations at PRAHRAN PM 133 (RL 10.628) using Leica VIVA GPS receiver and GPSnet observations.

Unless shown otherwise the position of buildings is to plotting accuracy and the dimensions of buildings should NOT be determined from computer data for any final design plans or workshop details. The position of the boundary structures and fences are shown relative to title in our plan 6181RE1.

Prior to any demolition, excavation or construction on the site the relevant authority should be contacted to ascertain the possible locations of further services and detailed

The levels and features shown on this plan have been located by this survey. Any other services and features which may be in the area have not been shown and no attempt to

Structures below the surface level (if any) including footings projecting into the site from adjoining properties have not been located by this survey. We have not excavated the

This survey has been carried out for the exclusive use of OSANRAE for the purpose of DESIGN & DEVELOPMENT on the site and should not be used for any other purpose


S-16.10 SILL HEIGHT

(1)


PHOTO NUMBER AND DIRECTION

15.20 SPOUT GUTTER LEVEL 15.20 16.57 RIDGE RIDGE LEVEL 16.57 9.96 FL FLOOR LEVEL 9.96 H/W HABITABLE WINDOW W WINDOW H-17.60 HEAD HEIGHT

LEGEND

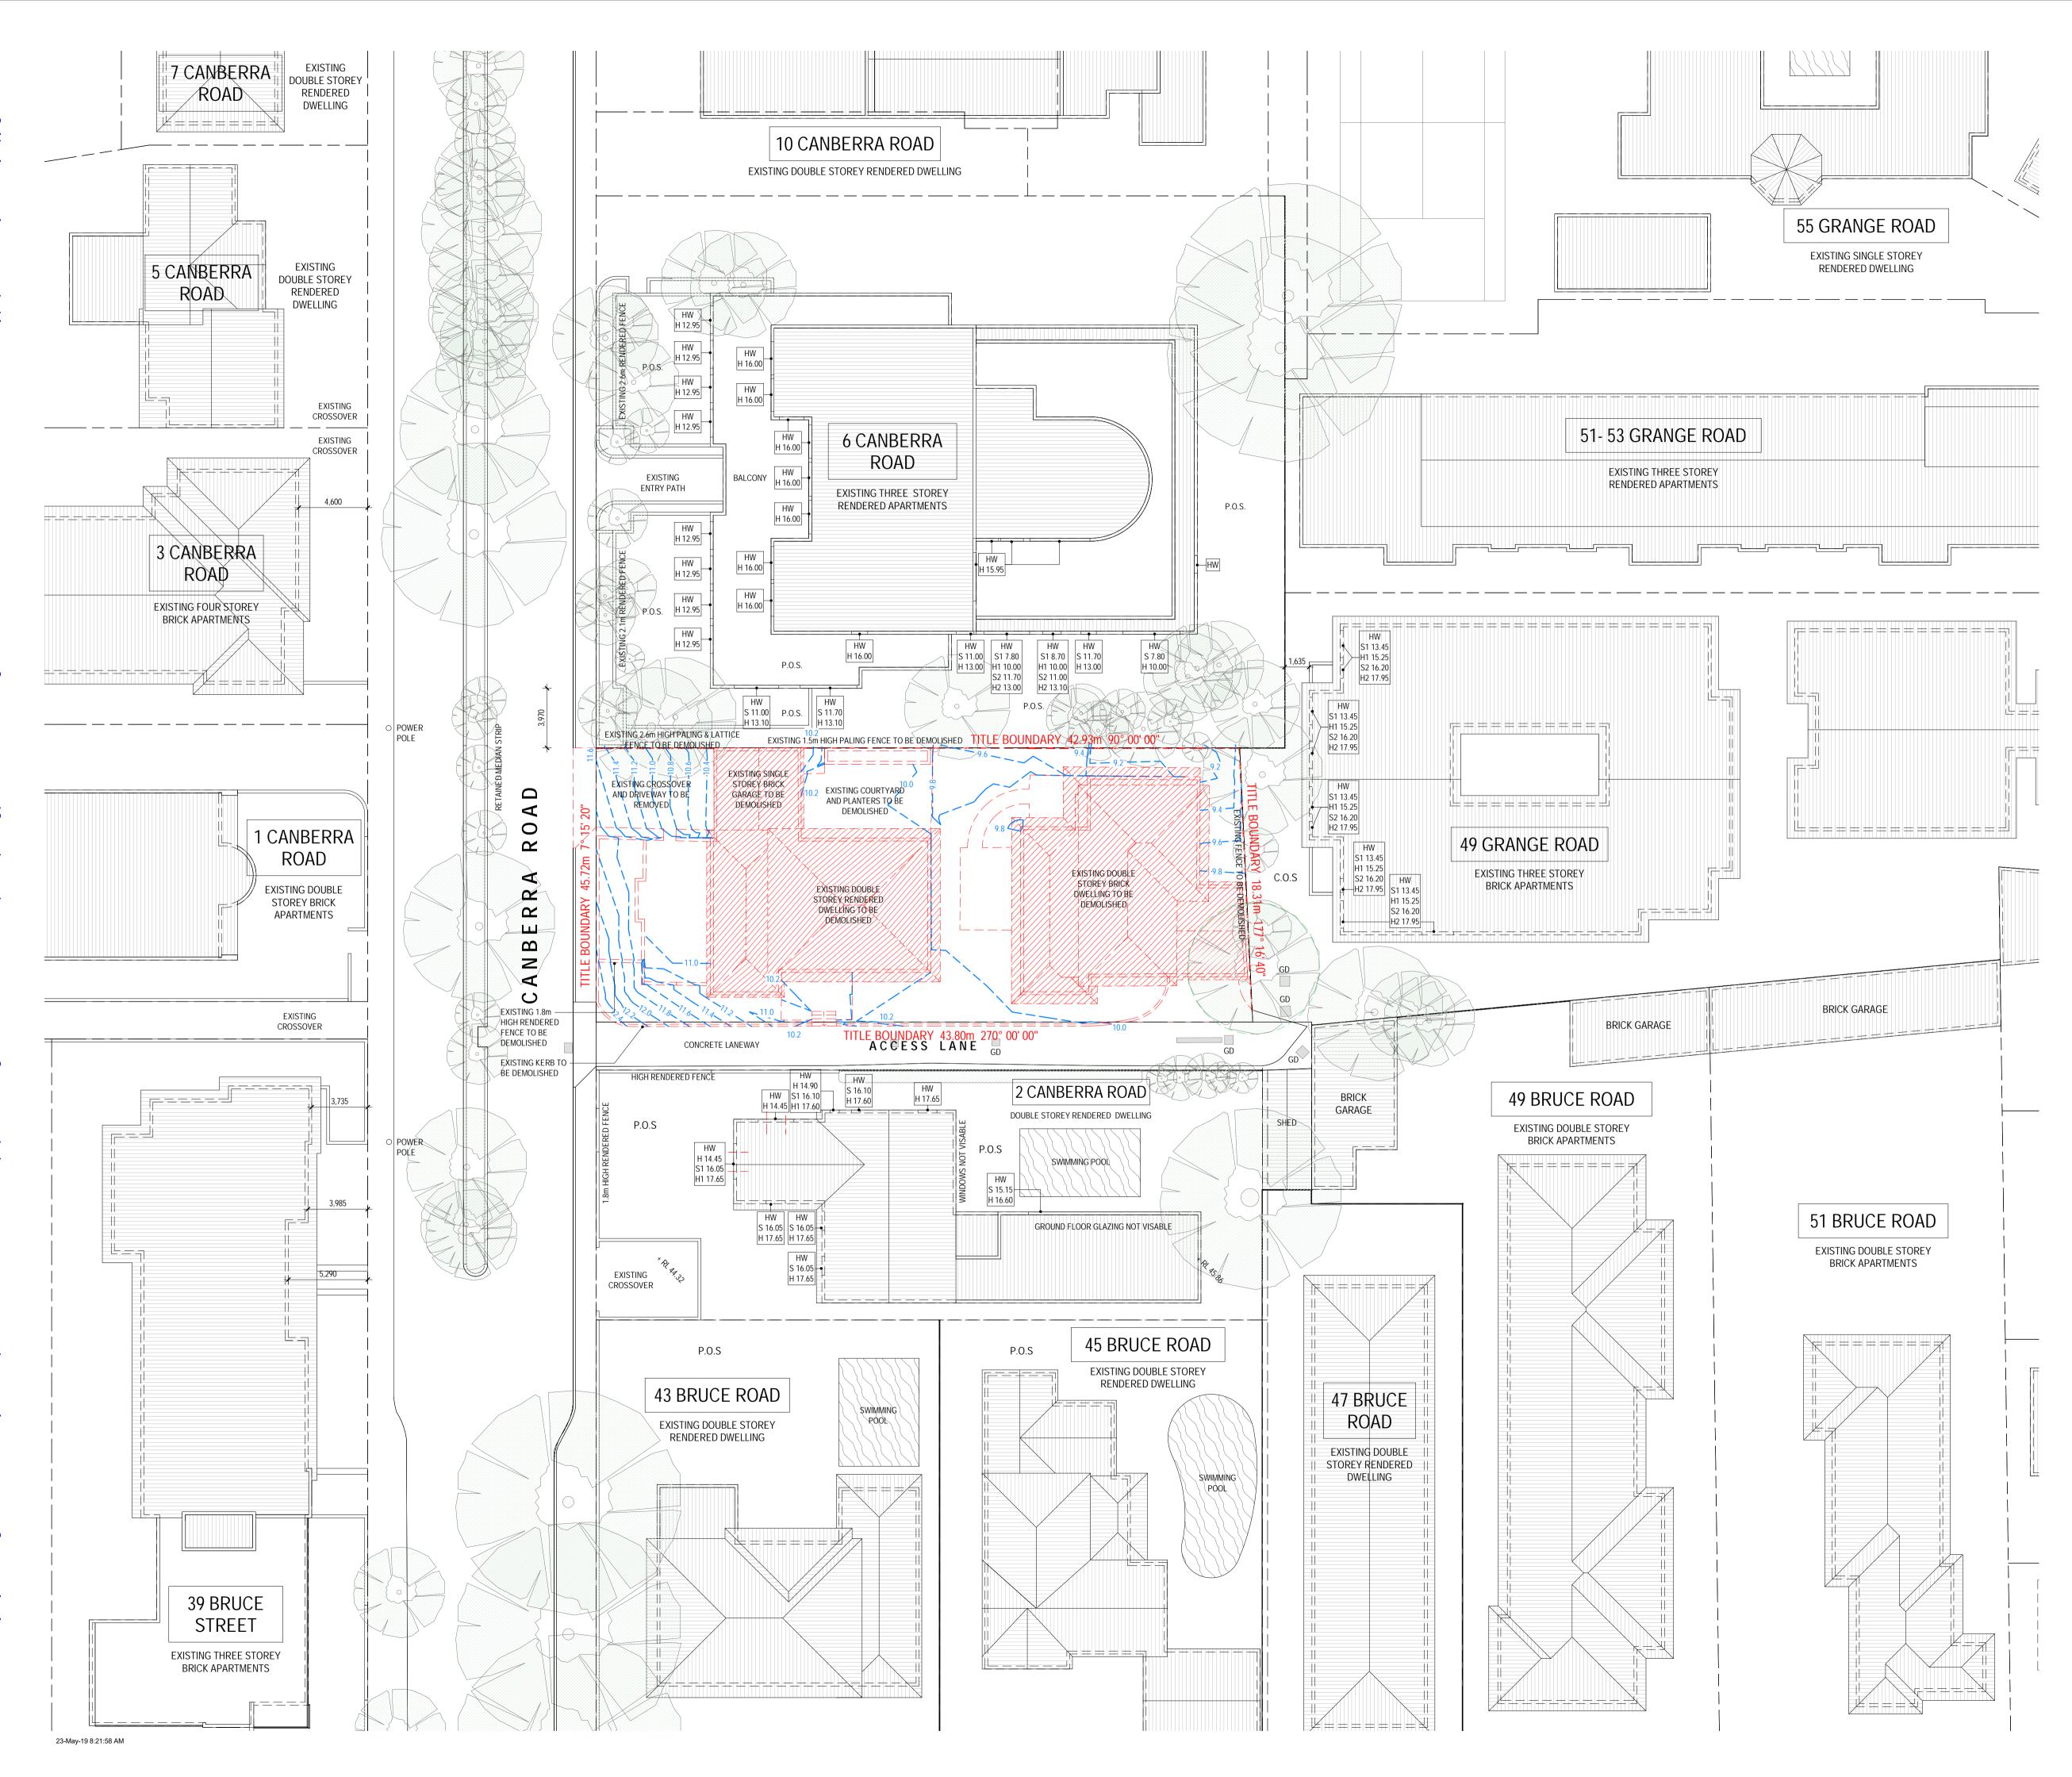

EXISTING TREES TO BE RETAINED

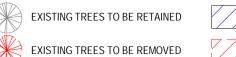

EXISTING EASEMENT TO BE RETAINED

EXISTING BUILDINGS TO BE DEMOLISHED

ABBREVIATIONS

H HEAD HEIGHT OF WINDOW HW1 HABITABLE WINDOW AT LEVEL 1

S SILL HEIGHT OF WINDOW HWG HABITABLE WINDOW AT GROUND LEVEL WG NON-HABITABLE WINDOW AT GROUND LEVEL W1 NON-HABITABLE WINDOW AT LEVEL 1

NOTES

1. LANDSCAPING IS INDICATIVE ONLY - REFER TO LANDSCAPE DRAWINGS 2. LEVELS ARE PRELIMINARY AND SUBJECT TO FURTHER DESIGN DEVELOPMENT


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	_{oject} a & 4b Canberra Rd, Toorak	Project No. C1802
	^{awing} xisting Conditions and Demolition	^{Date} 08/29/13
	awing Status own Planning	
Di	sclaimer	
Di :	sclaimer Do not scale drawings. Written dimensions govern.	
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1. 2.	Do not scale drawings. Written dimensions govern. All dimensions are in millimeters unless otherwise noted.	
1. 2. 3.	Do not scale drawings. Written dimensions govern. All dimensions are in millimeters unless otherwise noted. All dimensions are to be verified on site prior to proceeding	oancies.



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Drawing Status Town Planning

4A & 4B CANBERRA ROAD, TOORAK DEVELOPMENT SUMMARY

	Area m ²	%
Total Site Area	793	
EXISTING Site Coverage (Ground) Permeable Area	348 245	43.9 30.9
PROPOSED Site Coverage - Ground Site Coverage - Basement (incl piles) Permeable Area	438 539.9 163	55.2 68.1 20.5
Site Coverage - Basement including full extent of ramp	548.3	69.1
Apartment Mix:	2 Bed 3 Bed	2 3
	Total:	5
Carpark Mix:	Residential Visitor	10 1
	Total:	11
Bicycle Parking:	Residential Visitor	1
	Total:	2
Storage Spaces:	Total:	5

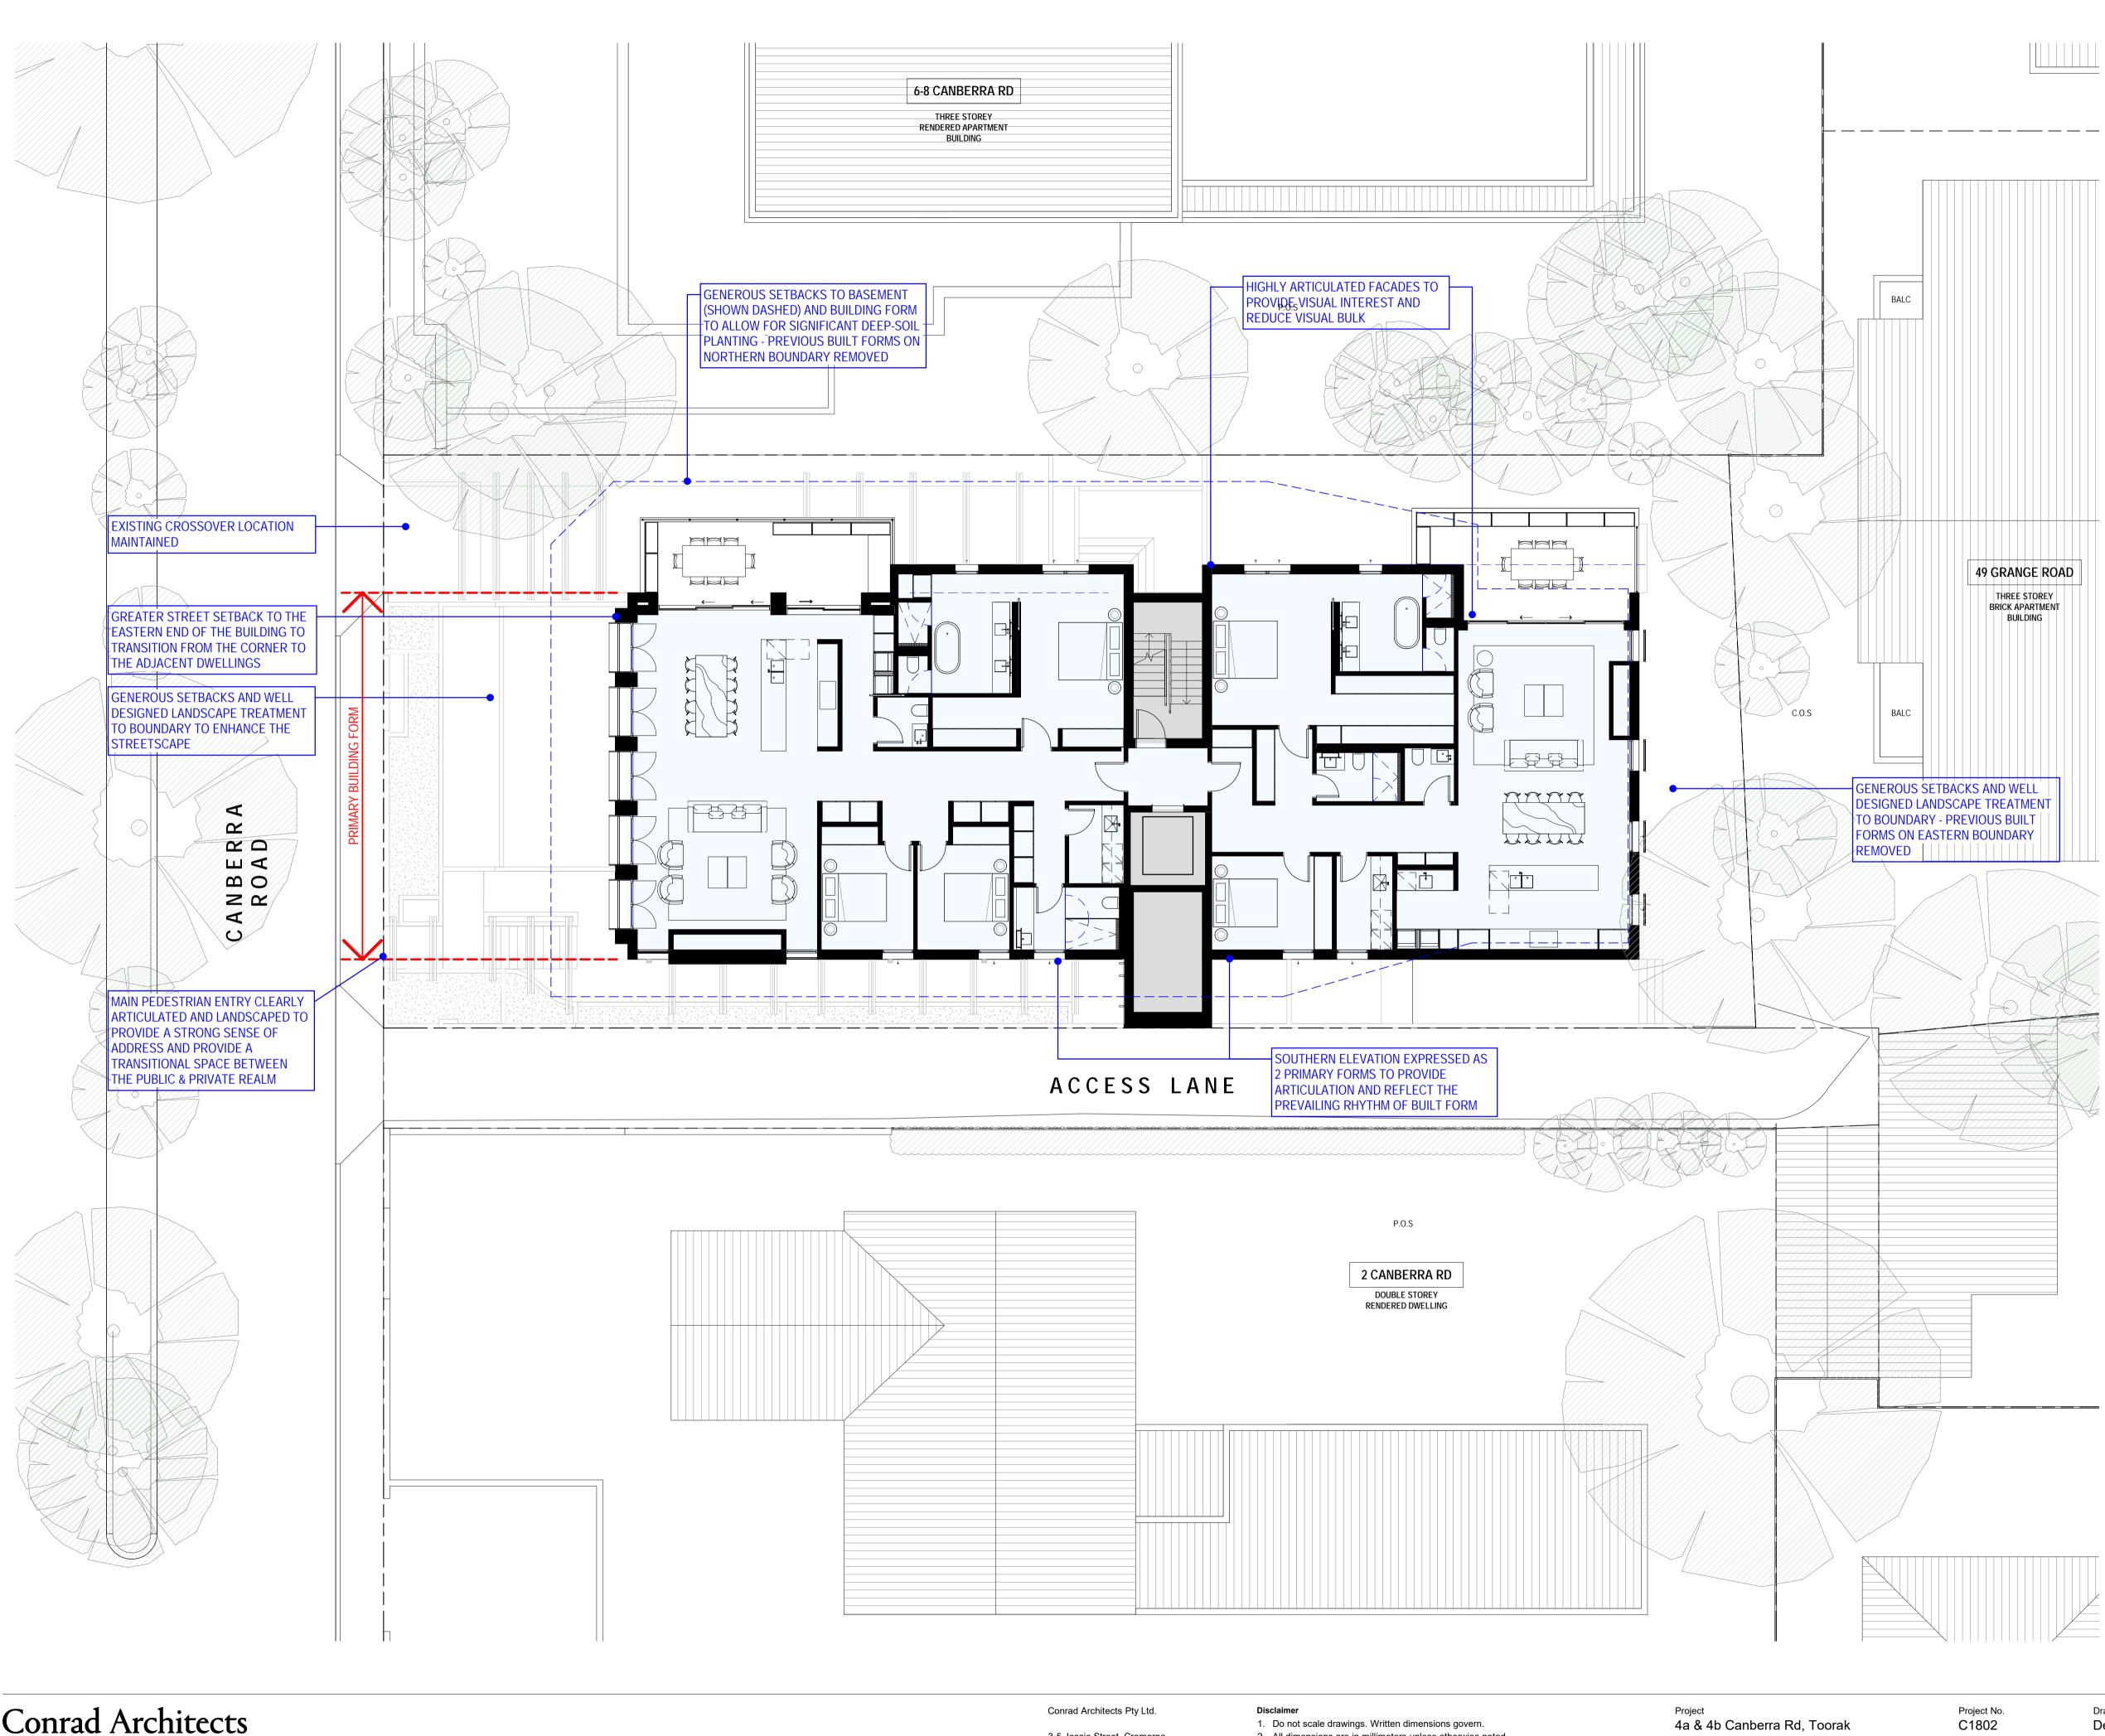Ground Floor Area Schedule

APARTMENT	TYPE	AREA	POS
G.01	3 BED	173.6 m ²	103.0 m ²
G.02	2 BED	136.8 m ²	146.9 m ²
TOTAL		310.5 m ²	249.9 m ²

First Floor Area Schedule

APARTMENT	TYPE	AREA	BALCONY
1.01	3 BED	176.3 m ²	20.7 m ²
1.02	2 BED	149.4 m ²	21.3 m ²
TOTAL		325.7 m ²	42.0 m ²

Second Floor Area Schedule

APARTMENT	TYPE	AREA	BALCONY
2.01	3 BED	187.1 m ²	126.2 m ²
TOTAL		187.1 m ²	126.2 m ²

NOTE: • ALL AREAS ARE CALCULATED TO INCLUDE INTERNAL FLOOR AREA

ONLY. AREAS ARE SUBJECT TO CHANGE DUE TO DESIGN DEVELOPMENT AND

CONSULTANT REVIEW. FIGURES MAY BE SUBJECT TO ROUNDING DIFFERENCES. REFER TO


TOTALS FOR GROSS AMOUNT REFER TO TP08 FOR GARDEN AREA DETAILS

Project No. C1802

^{Drawing} Design Response

_{Date} Mar 2019


Drawing No. TP05

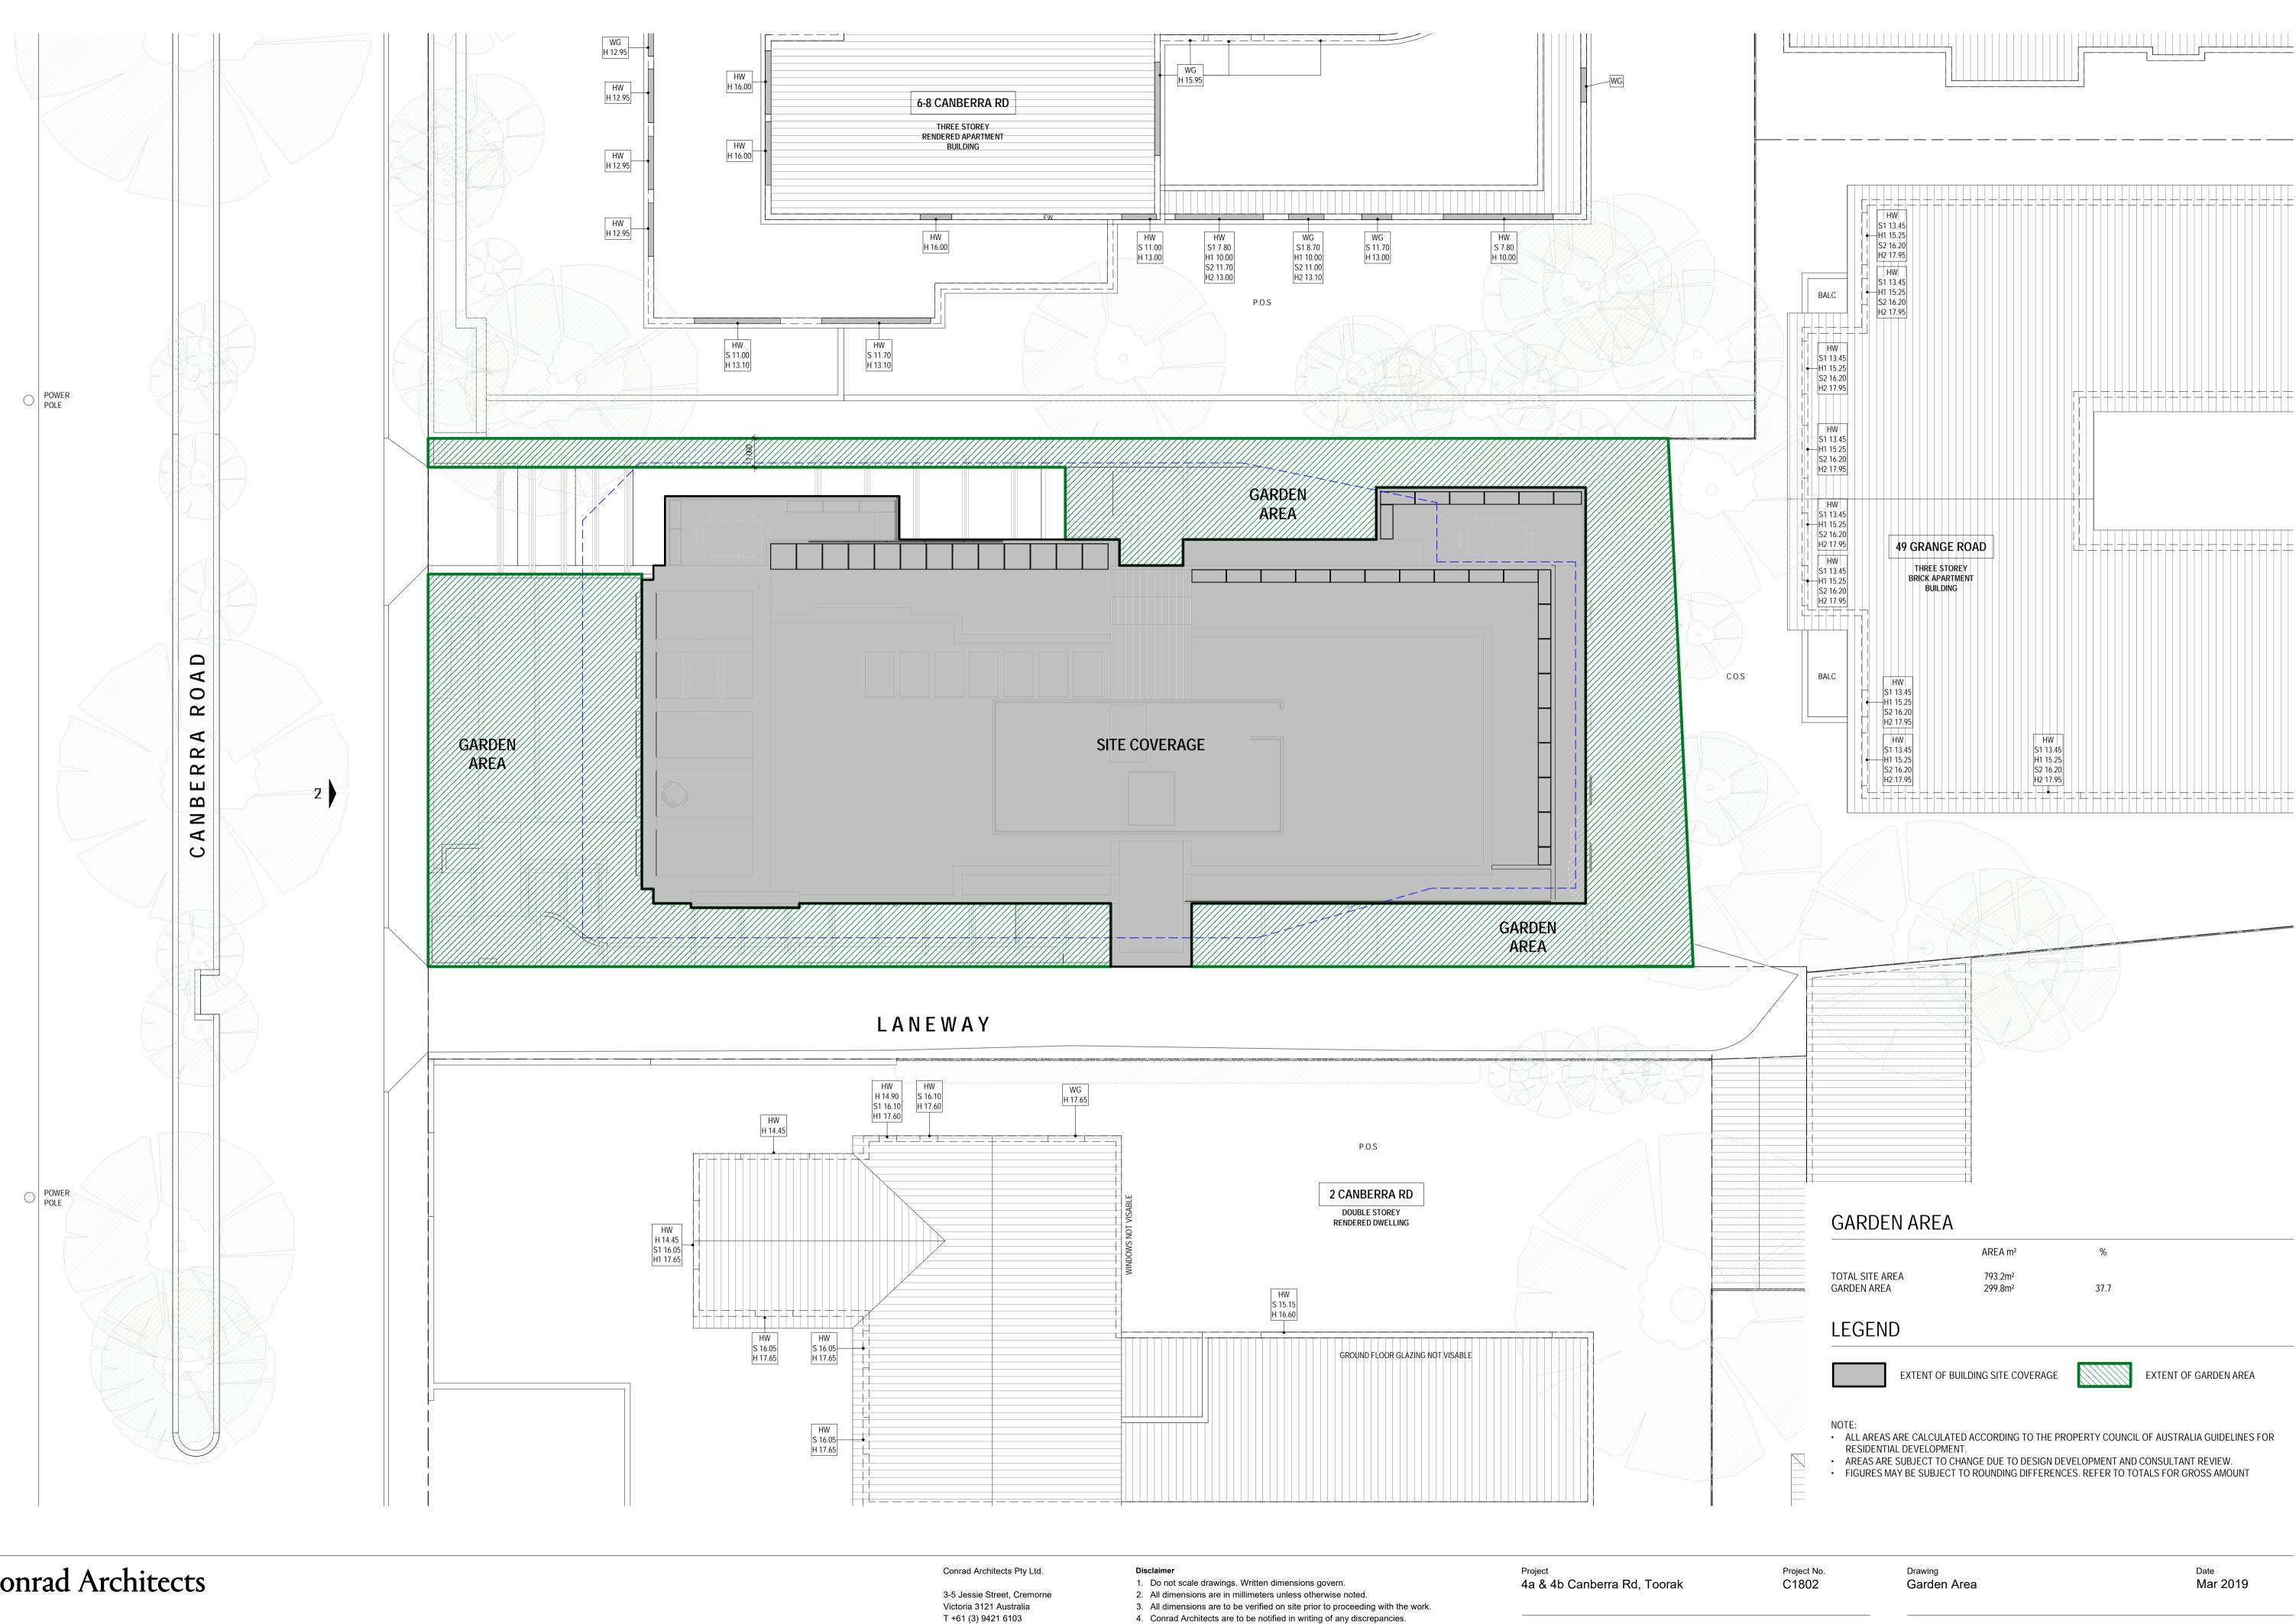

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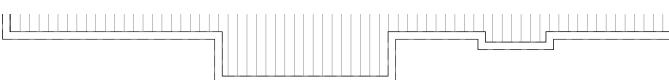
Drawing No. TP08




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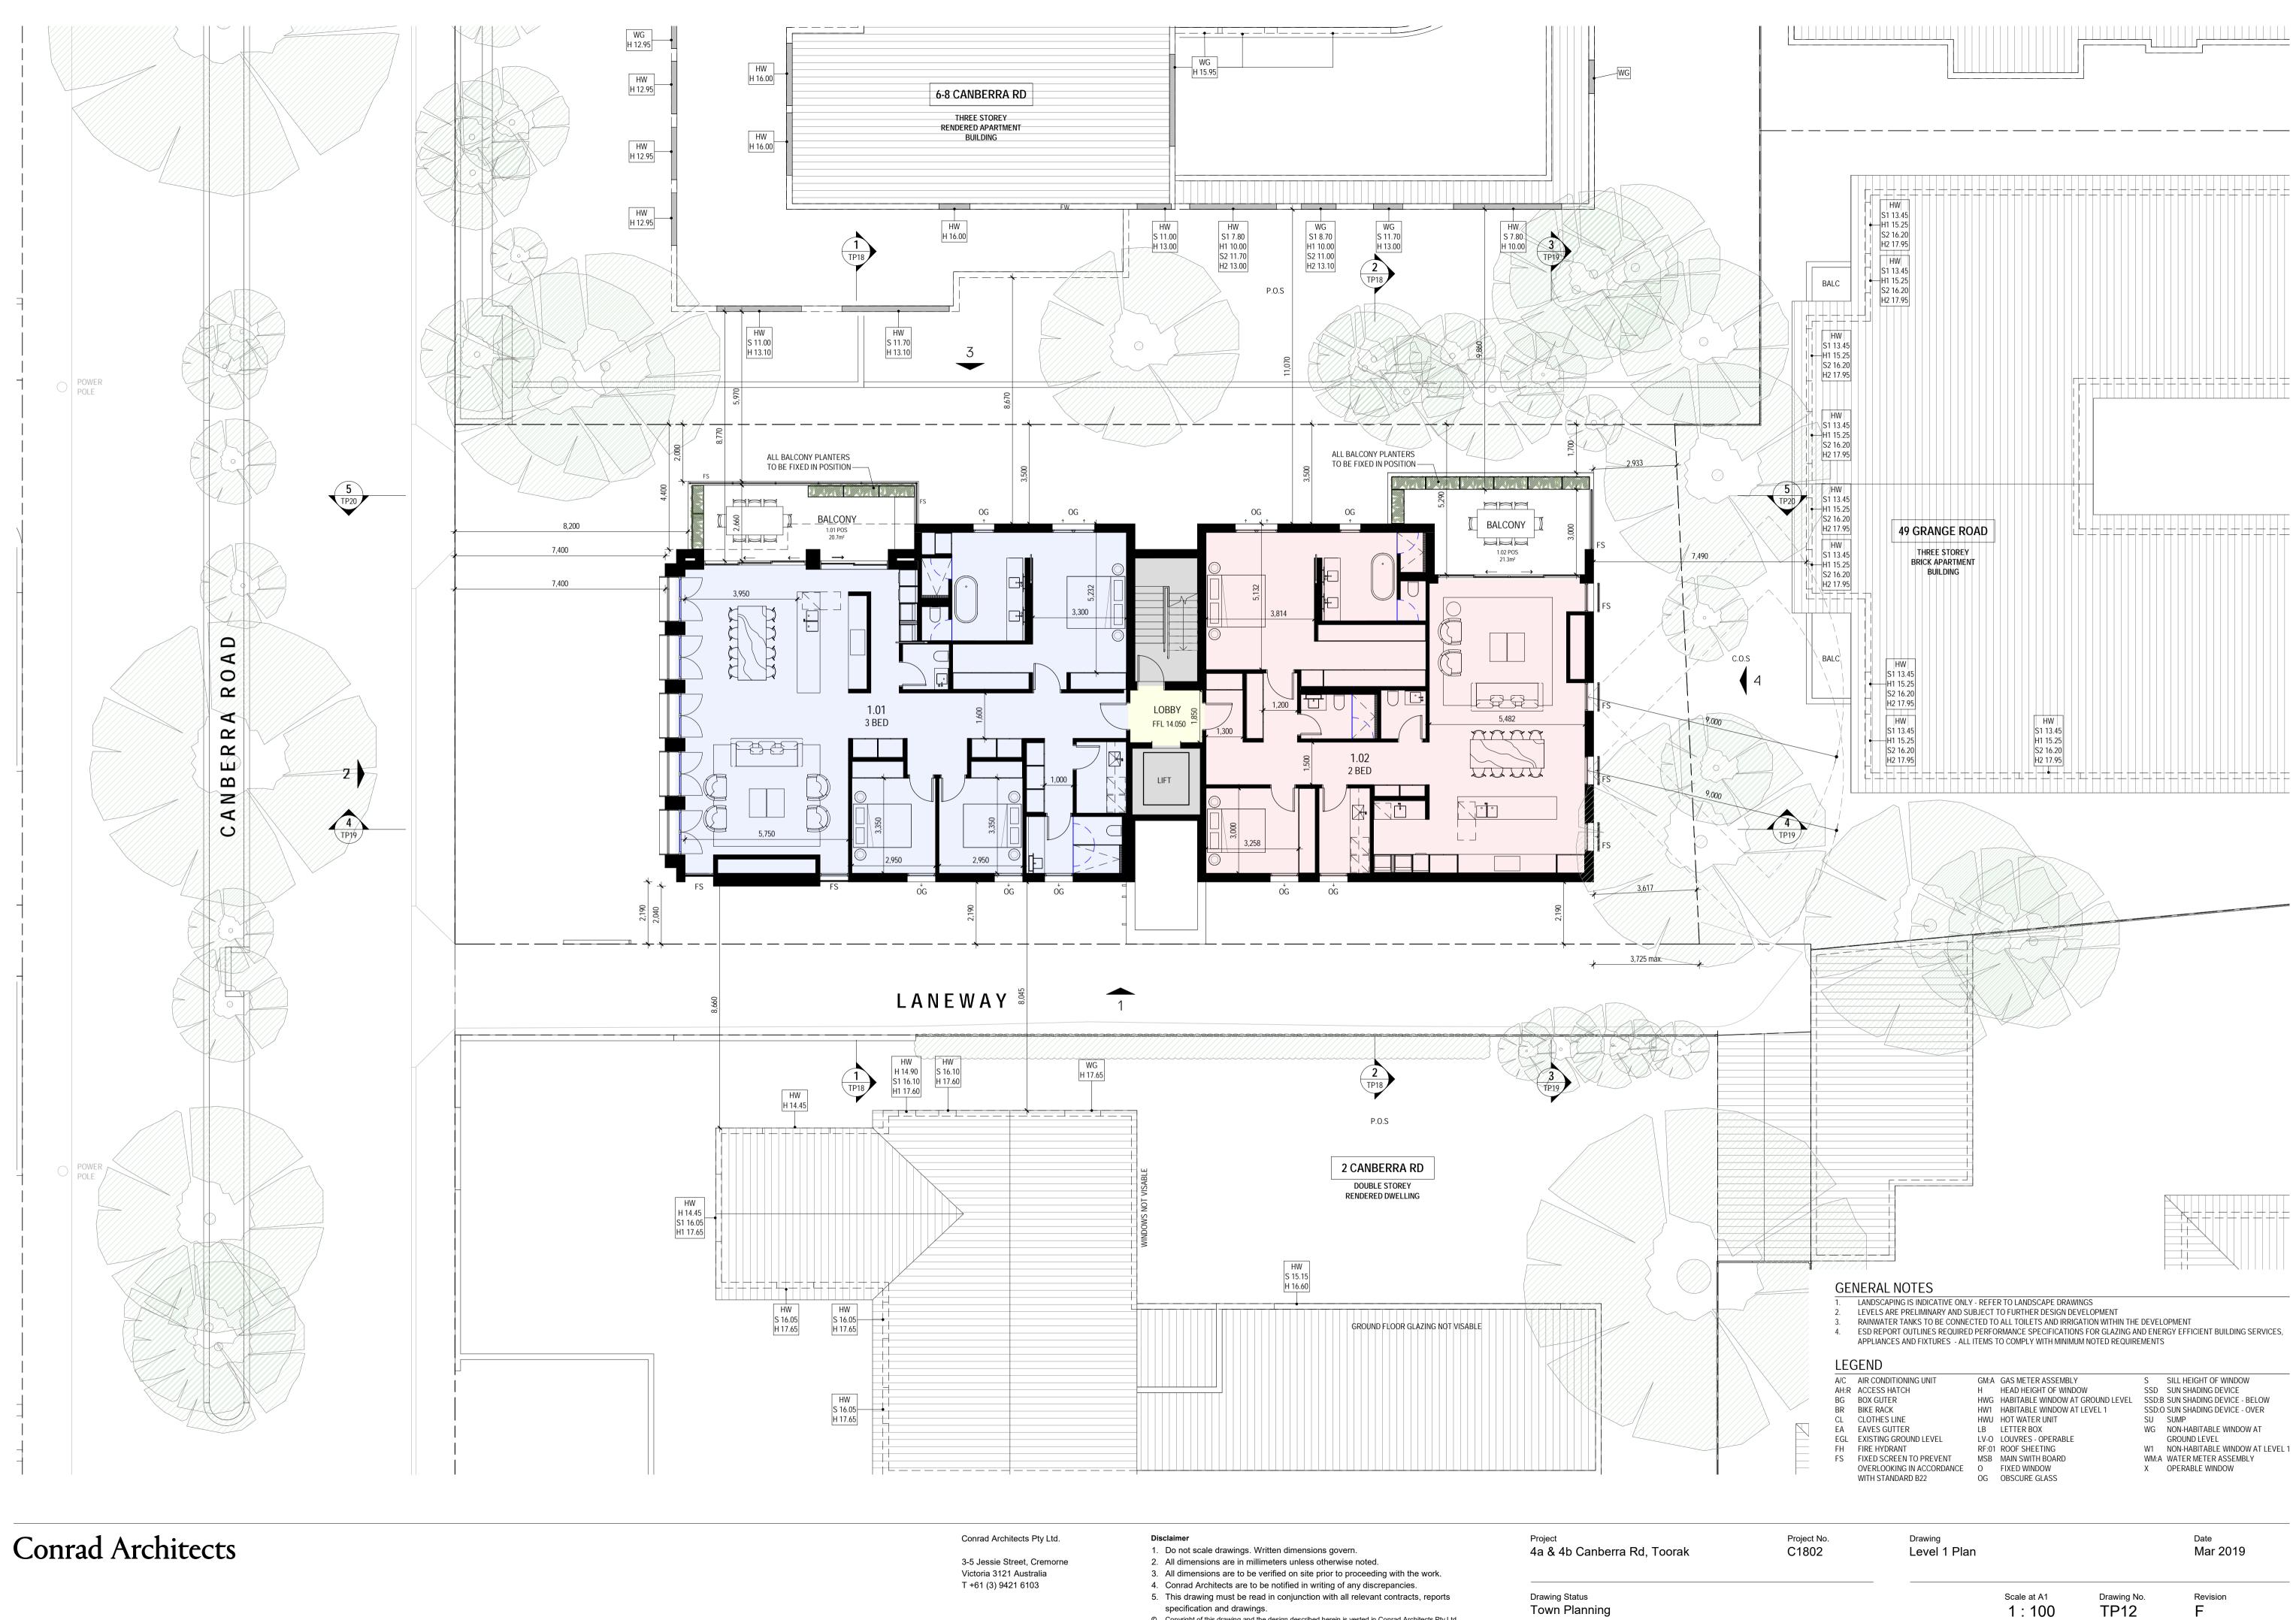


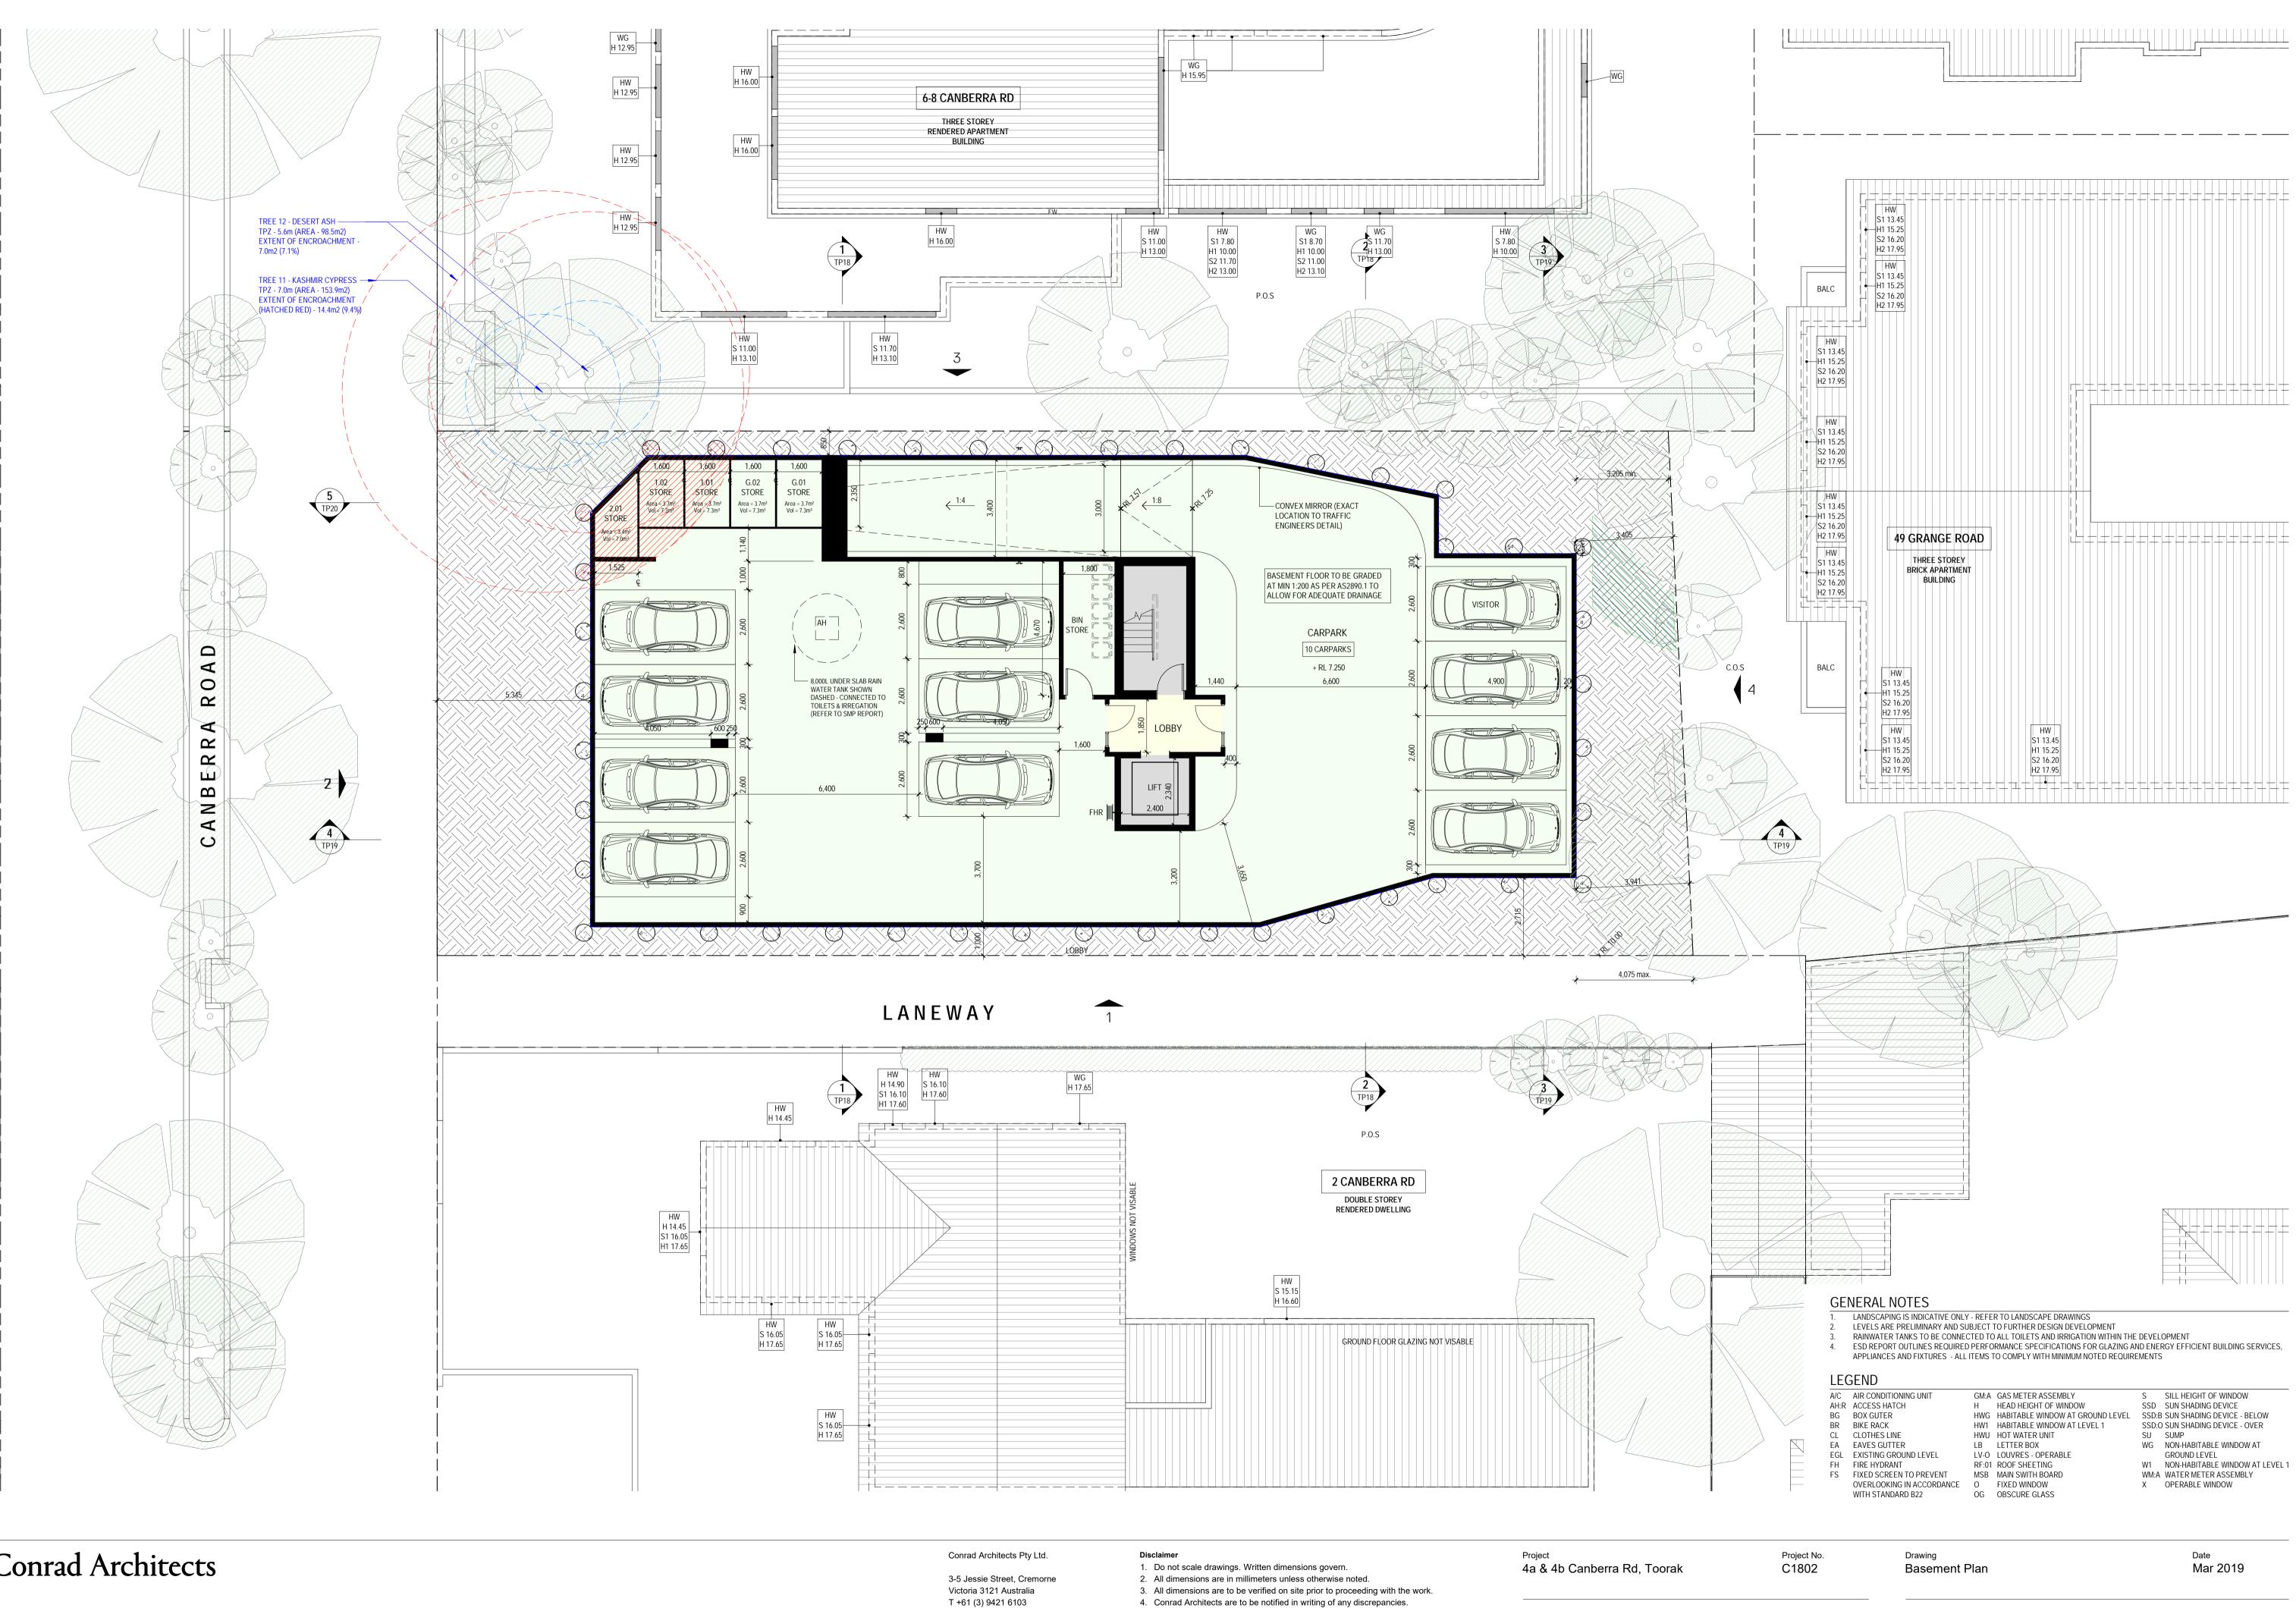Drawing No. TP10




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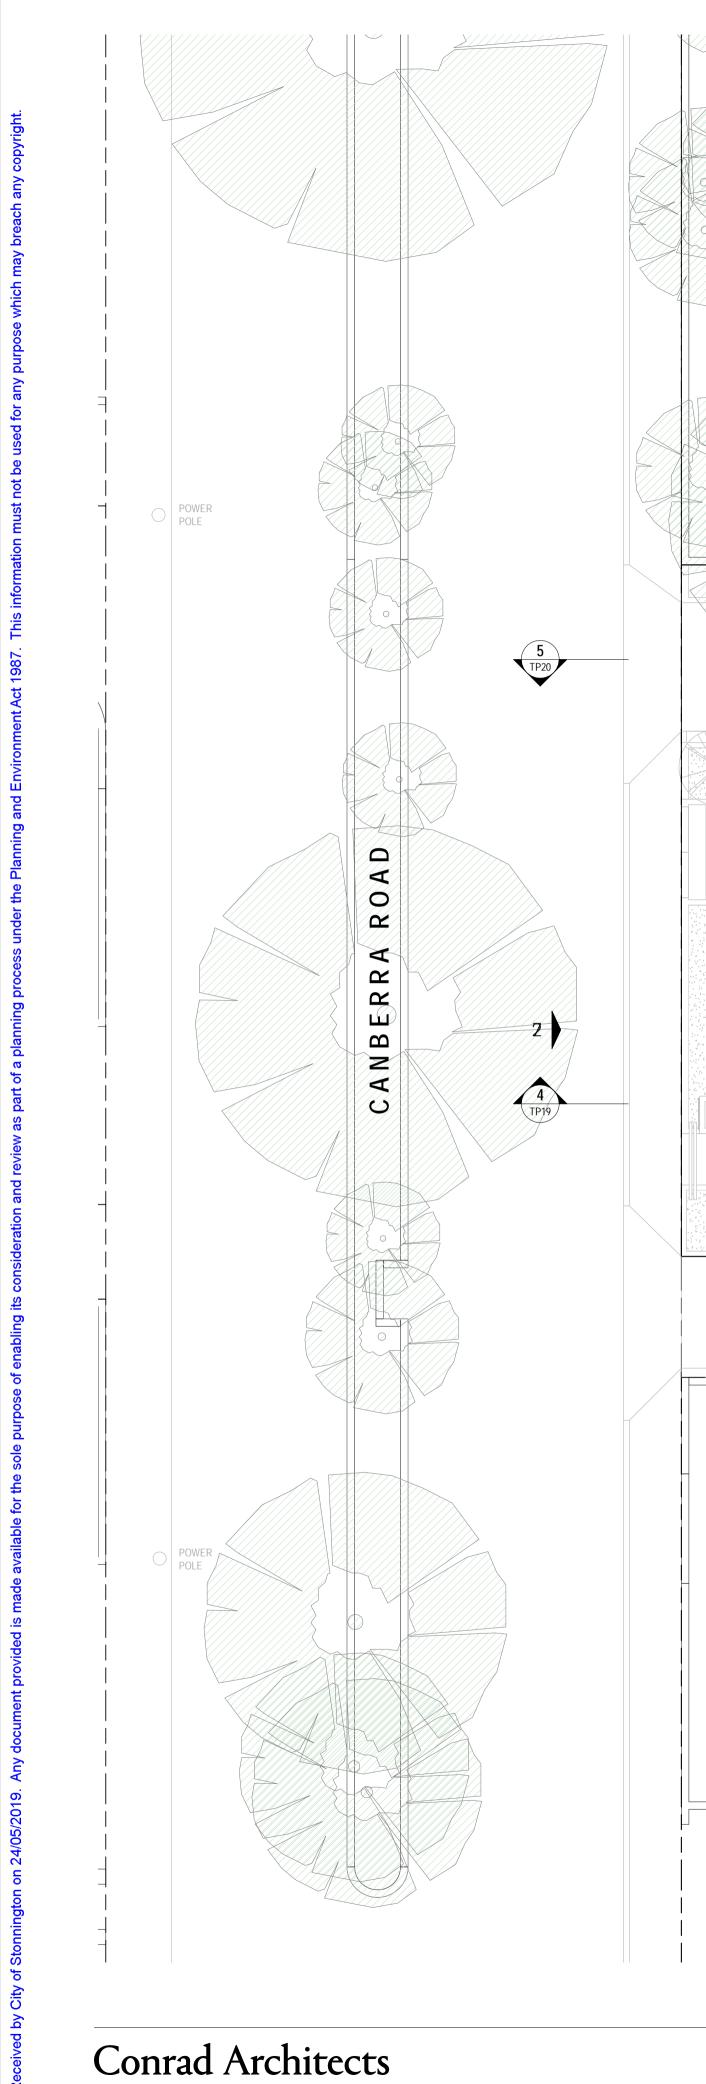



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CANBERRA

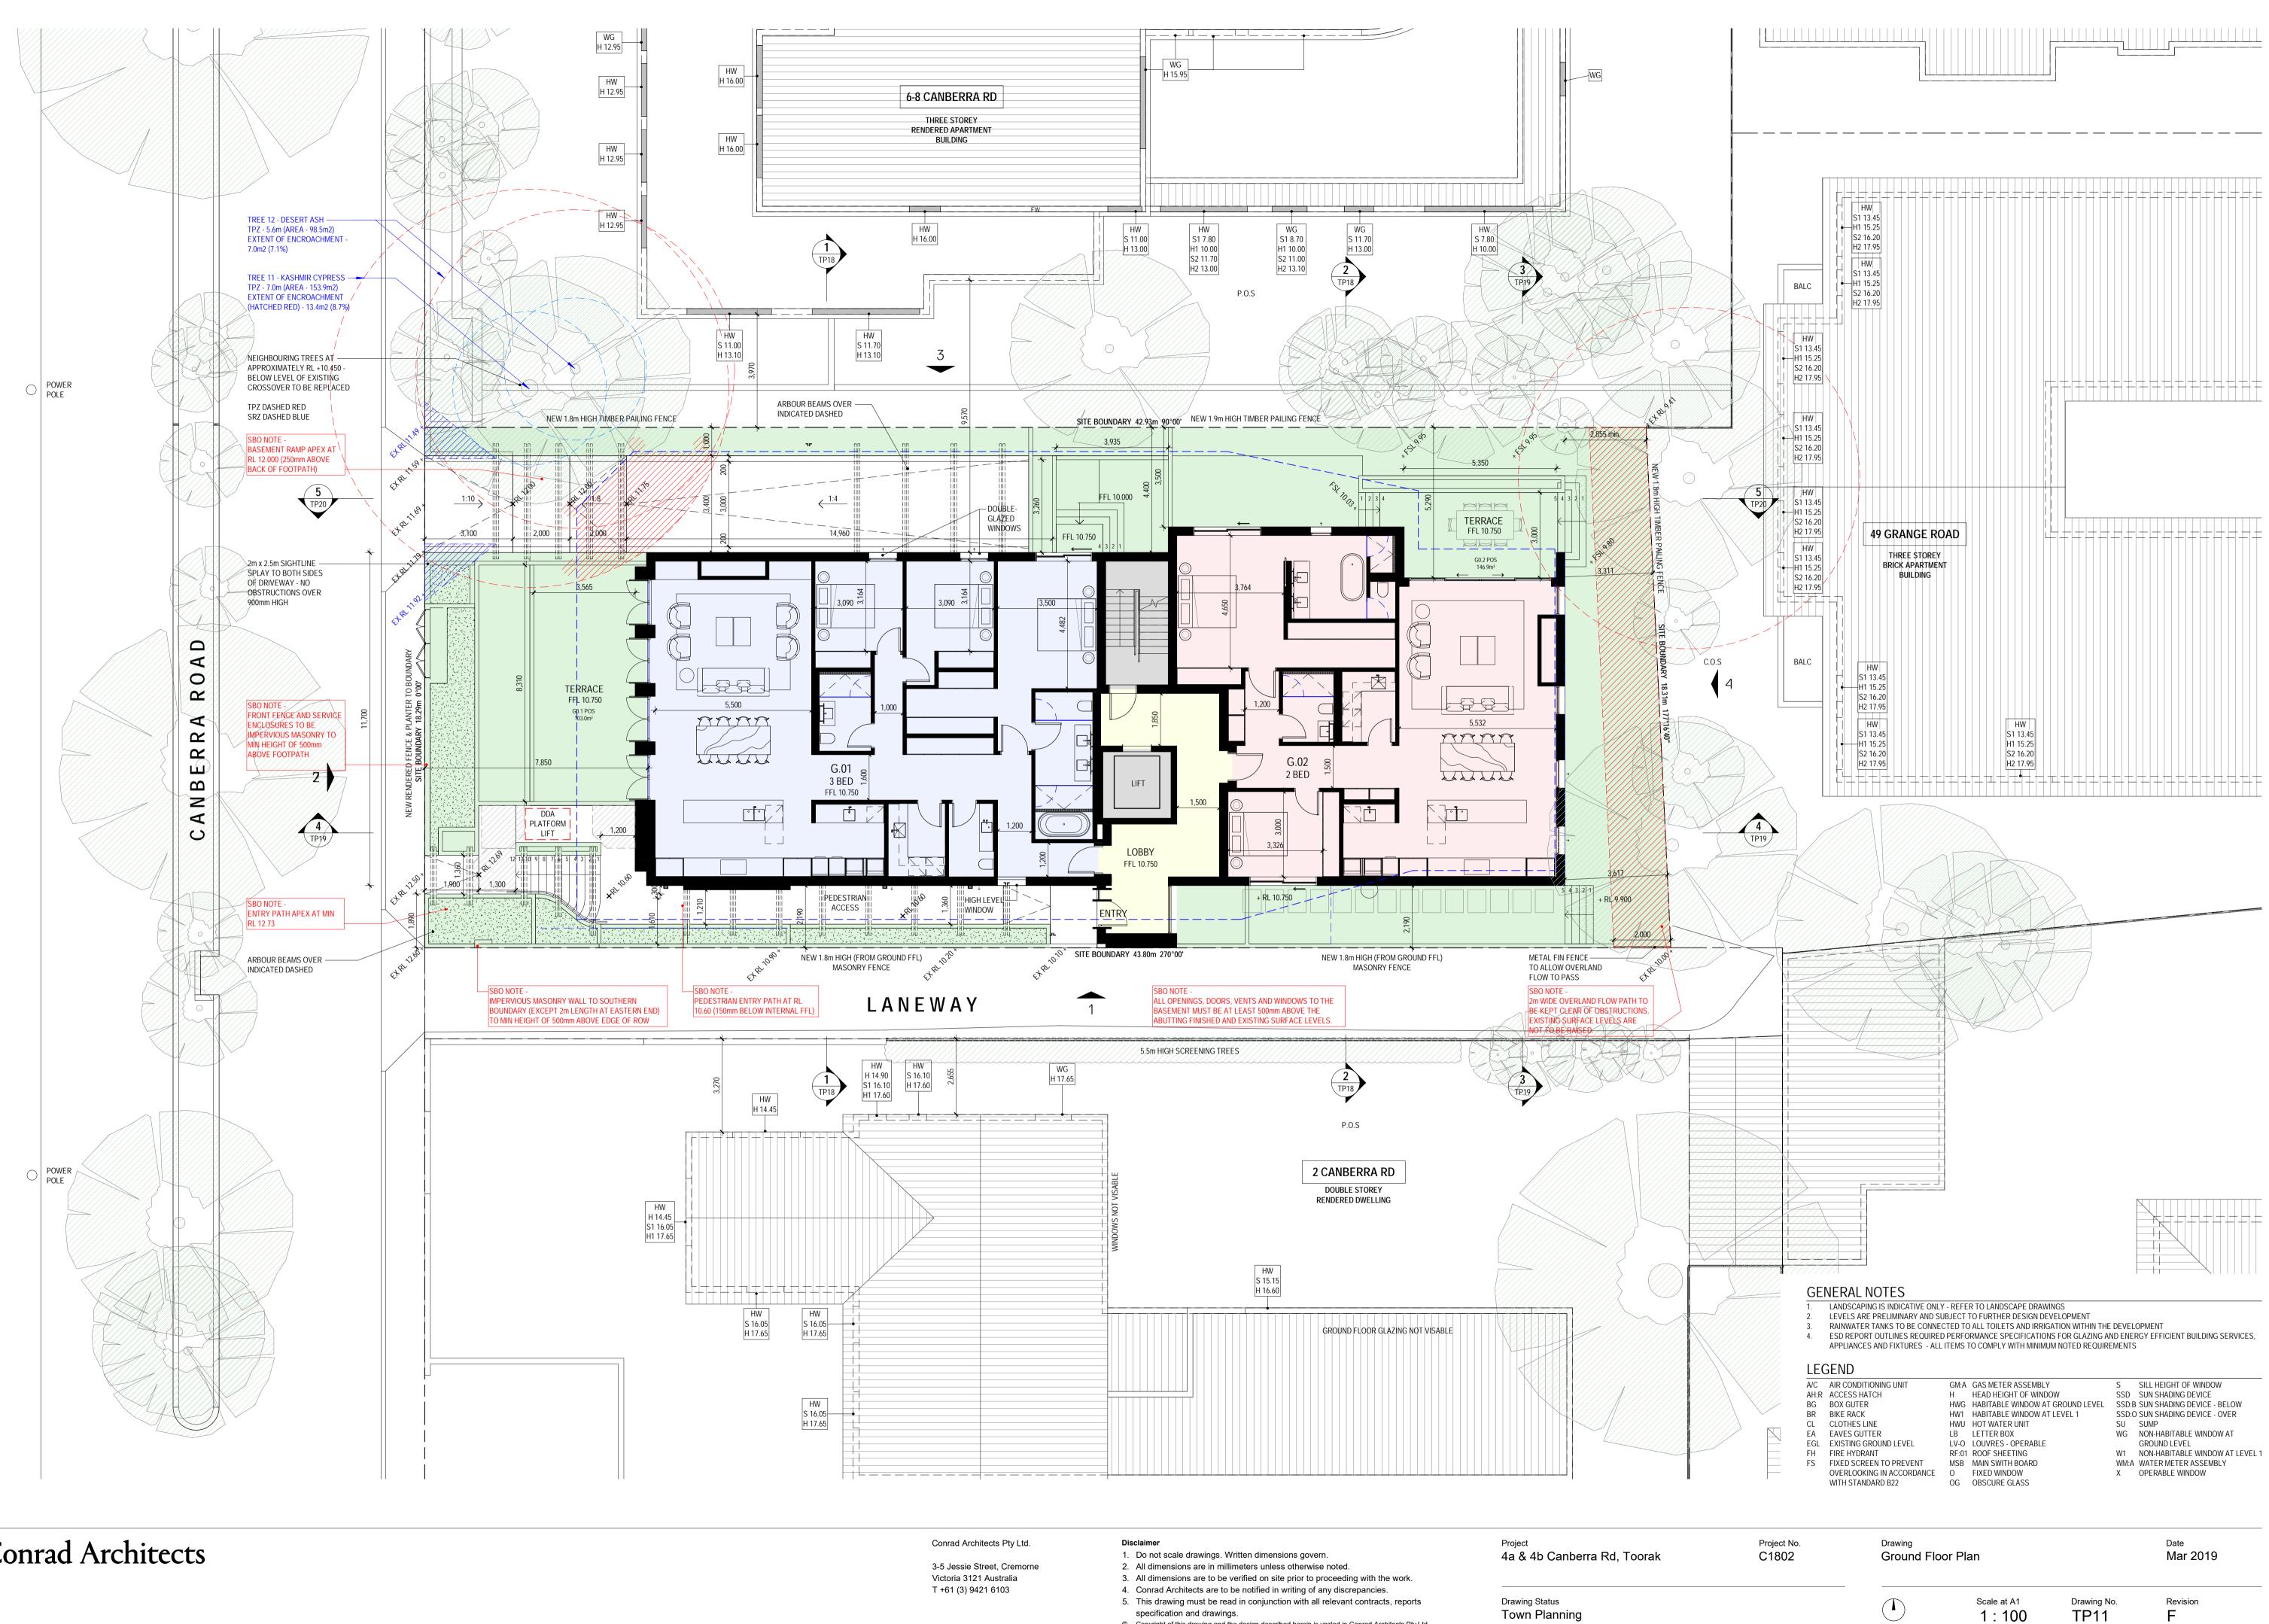ROAD

LEVEL 2

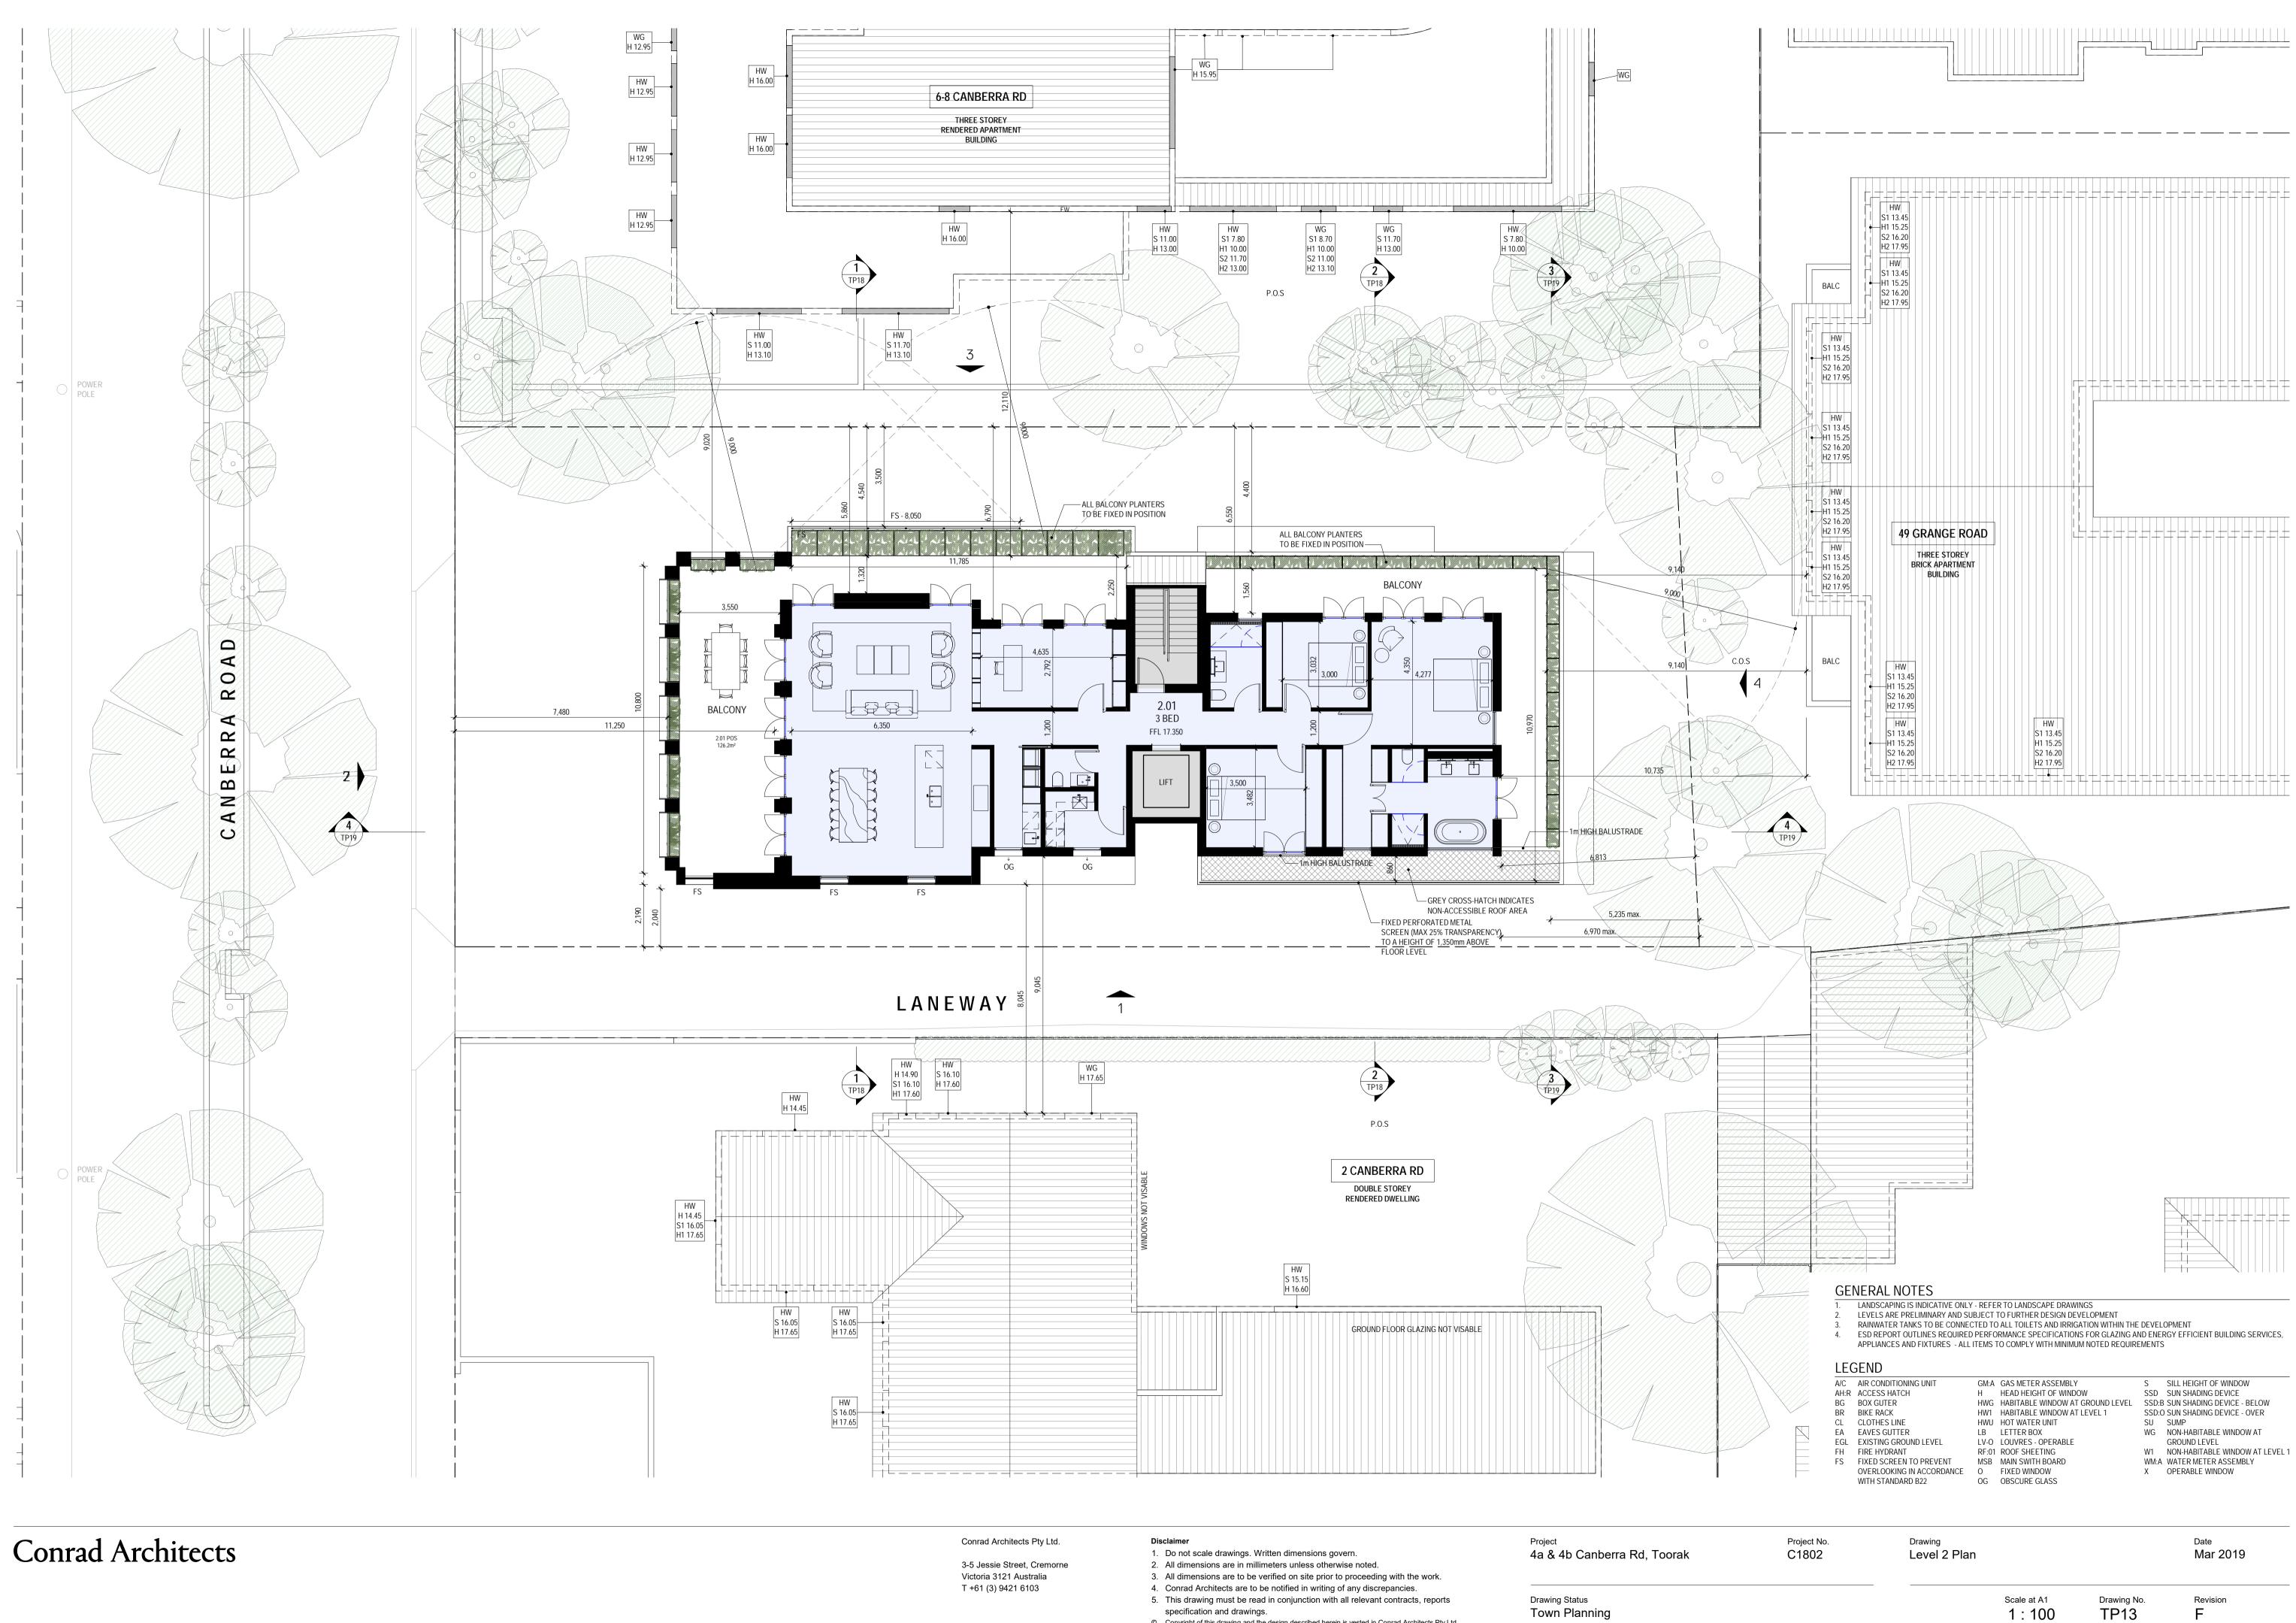


RL + 21.300

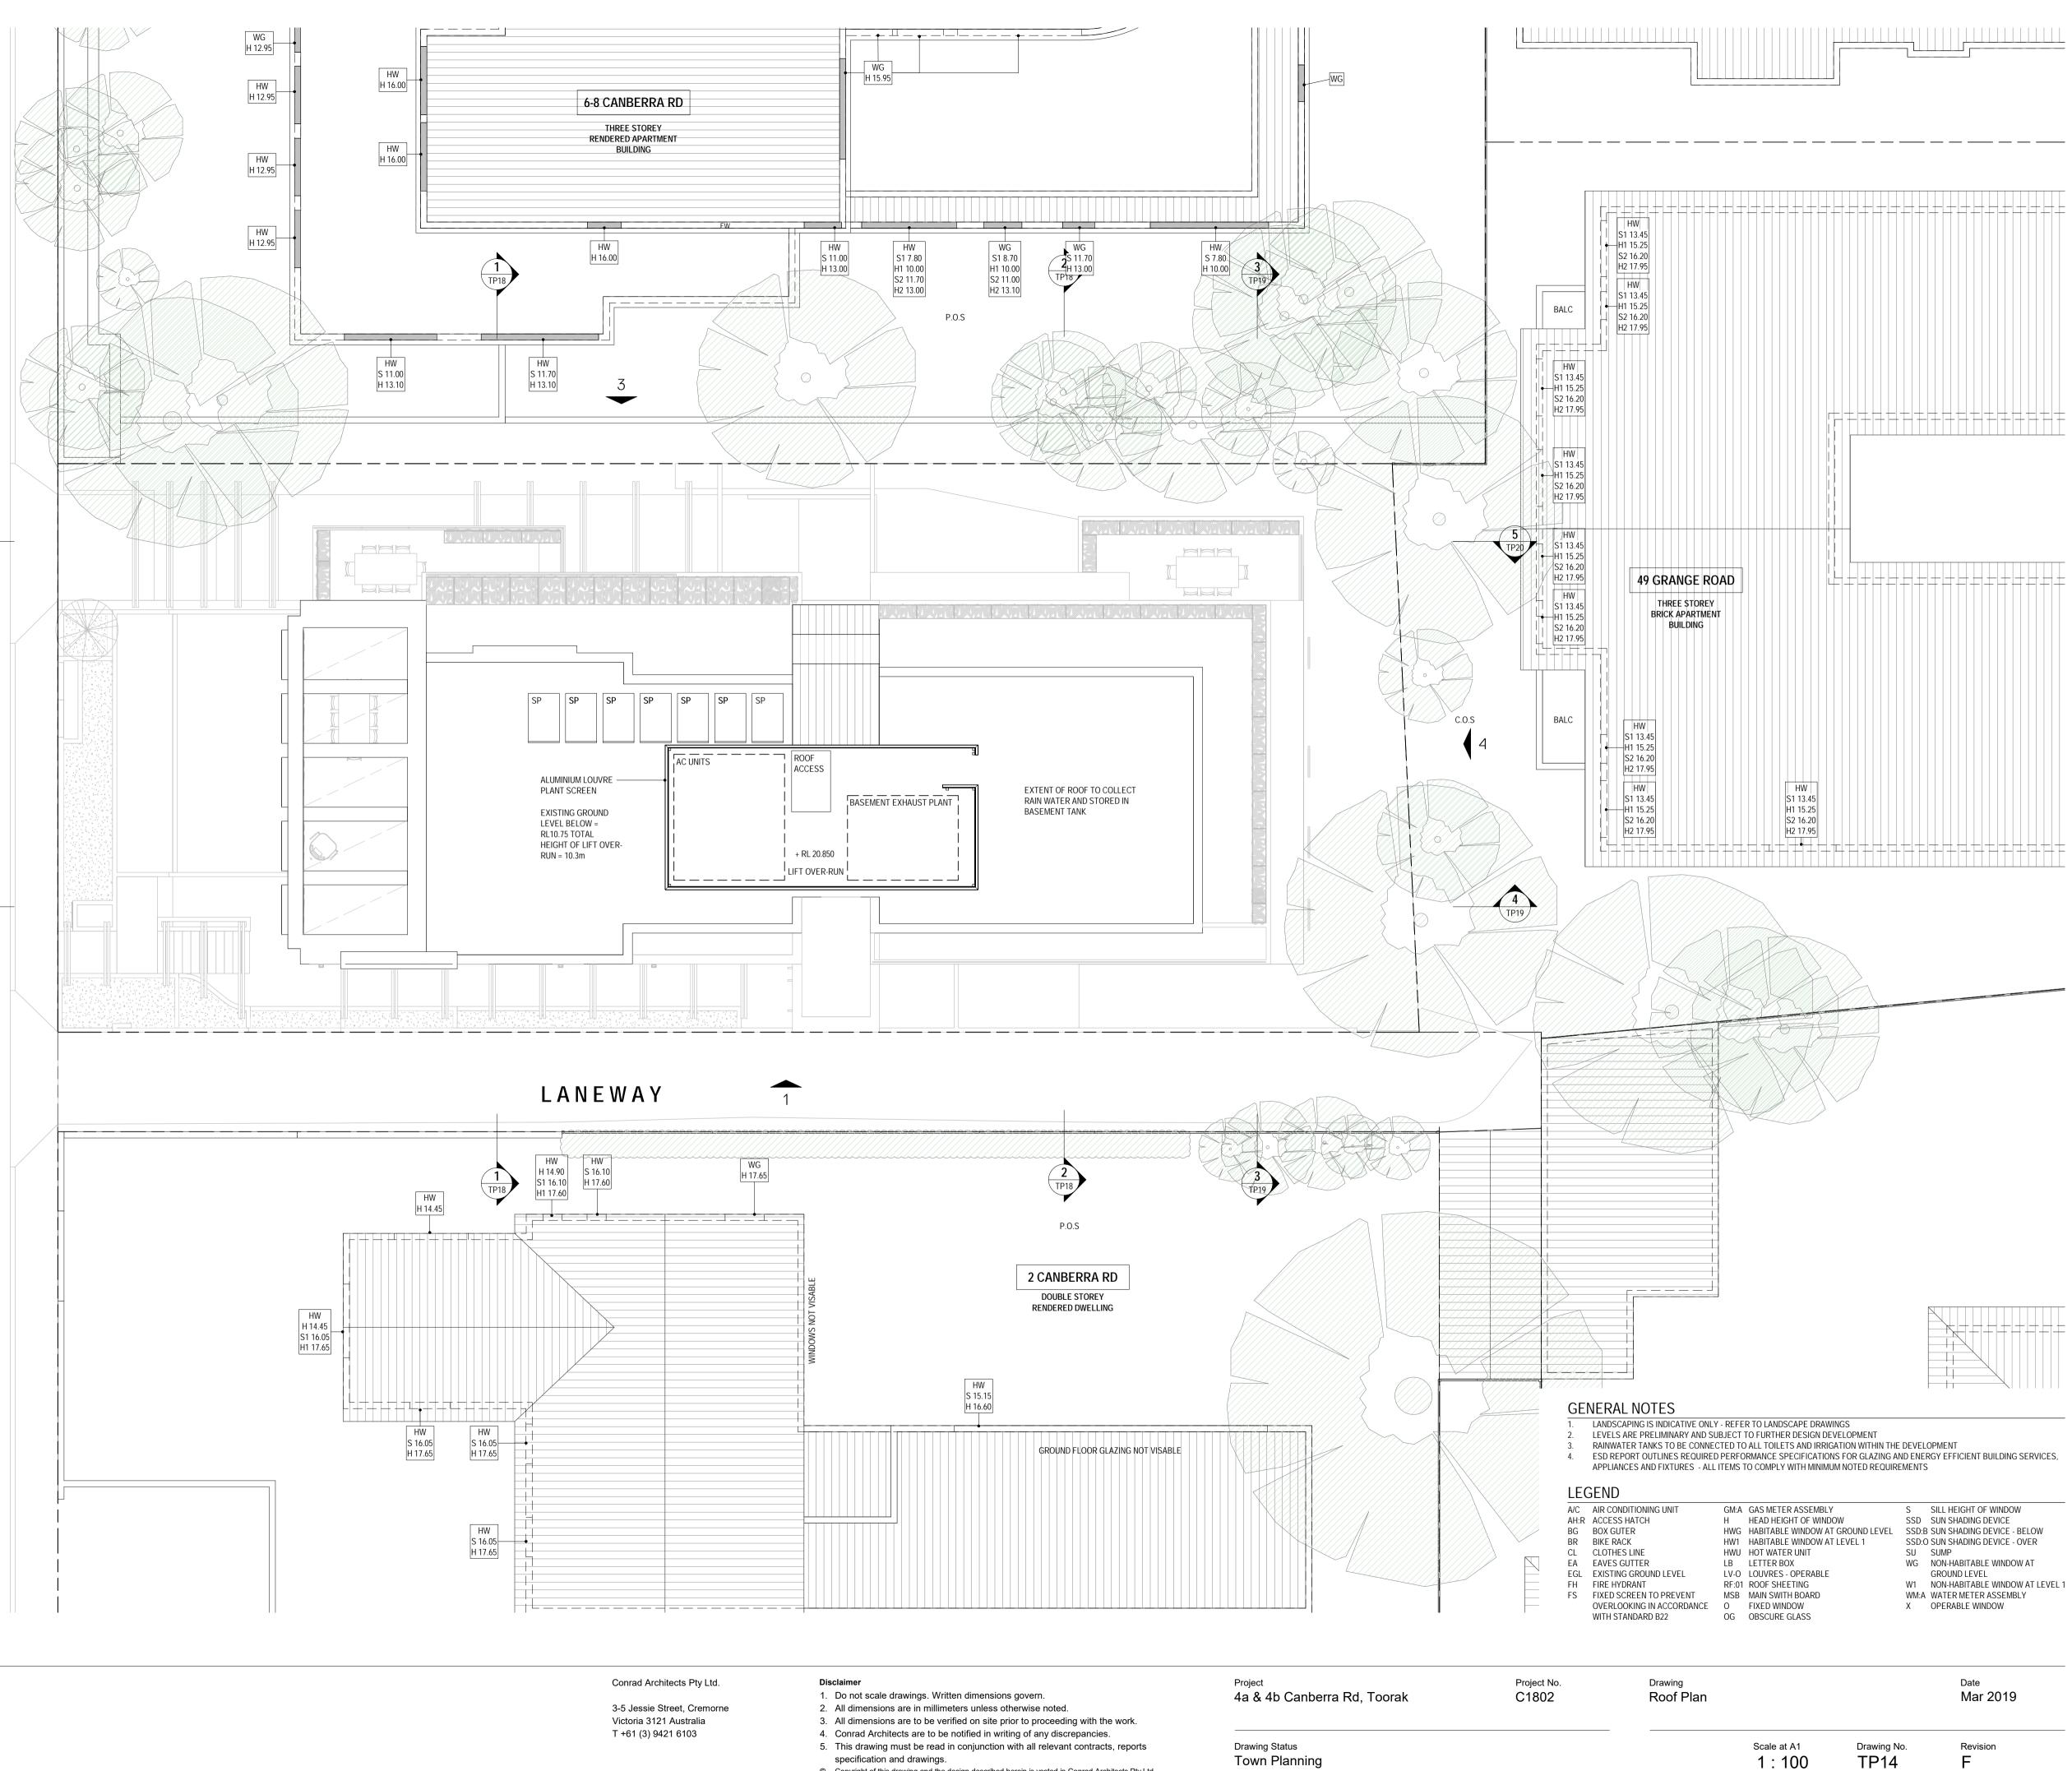RE:01

RE:01

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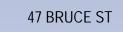
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Project 4a & 4b Canberra Rd, Toorak
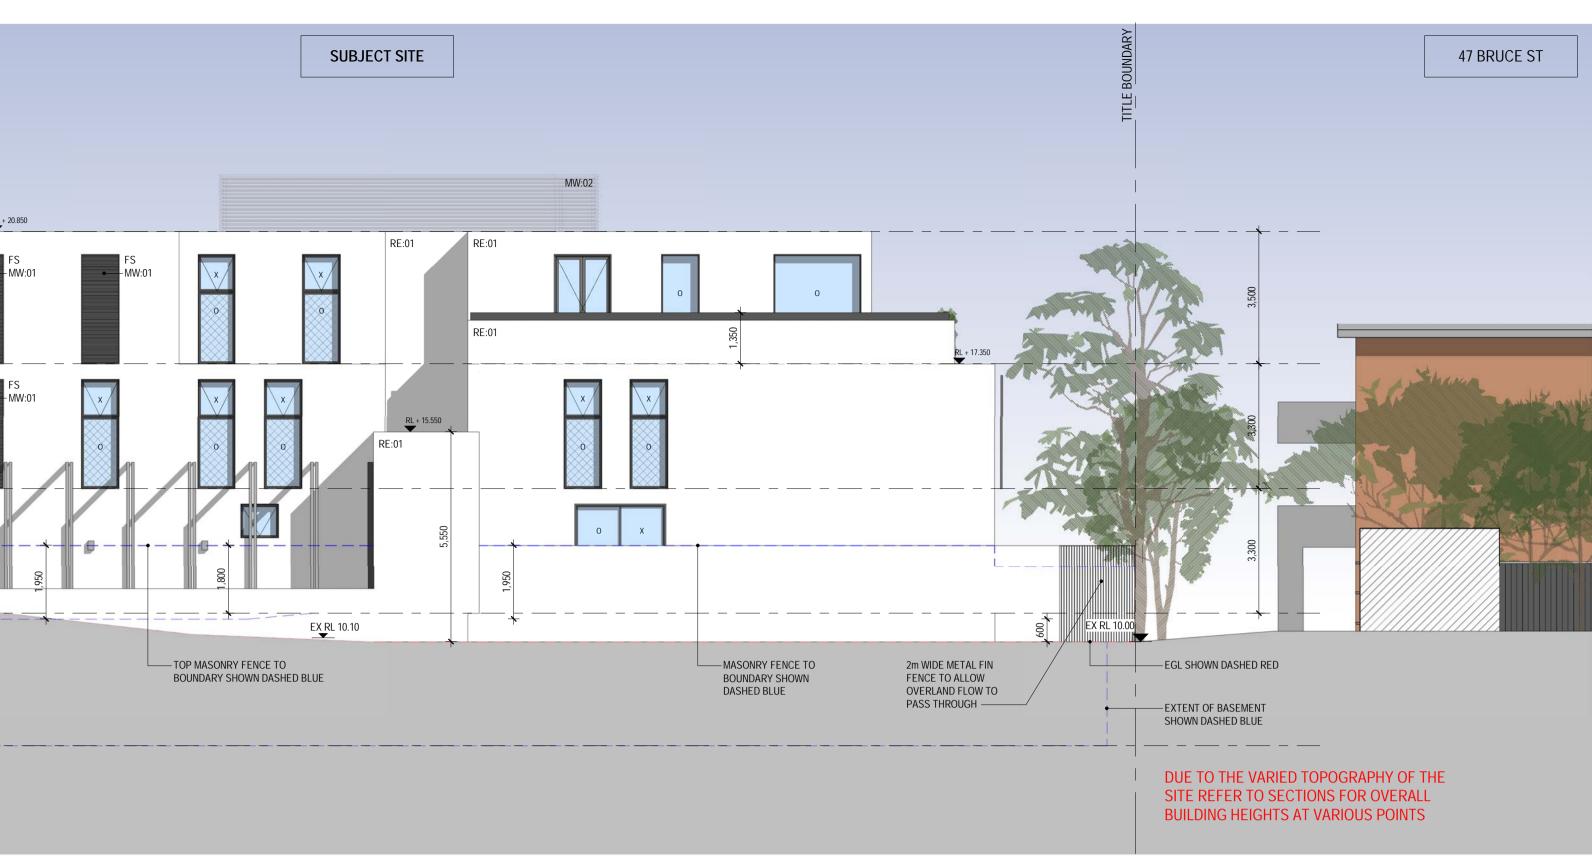
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LEGEND

A/C	AIR CONDITIONING UNIT
AH:R	ACCESS HATCH

- BG BOX GUTER BR BIKE RACK
- CL CLOTHES LINE
- EA EAVES GUTTER
- EGL EXISTING GROUND LEVEL
- FH FIRE HYDRANT
- FS FIXED SCREEN TO PREVENT OVERLOOKING IN ACCORDANCE O FIXED WINDOW
- WITH STANDARD B22
- RF:01 ROOF SHEETING MSB MAIN SWITH BOARD

HWU HOT WATER UNIT

LV-O LOUVRES - OPERABLE


LB LETTER BOX

GM:A GAS METER ASSEMBLY

H HEAD HEIGHT OF WINDOW

OG OBSCURE GLASS

EXTERNAL MATERIALS SCHEDULE

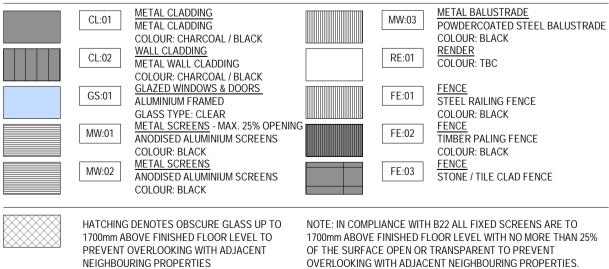

Project No. C1802

Drawing Elevations - Sheet 1

Date Mar 2019

Scale at A1 1:100

Drawing No. TP16

Revision F

S SILL HEIGHT OF WINDOW

WM:A WATER METER ASSEMBLY

X OPERABLE WINDOW

WG NON-HABITABLE WINDOW AT GROUND LEVEL W1 NON-HABITABLE WINDOW AT LEVEL 1

SSD SUN SHADING DEVICE

SU SUMP

HWGHABITABLE WINDOW AT GROUND LEVELSSD:B SUN SHADING DEVICE - BELOWHW1HABITABLE WINDOW AT LEVEL 1SSD:O SUN SHADING DEVICE - OVER



NORTH ELEVATION 1:100 3



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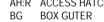
Project 4a & 4b Canberra Rd, Toorak

Drawing Status Town Planning

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LEC	GEND		
A/C	AIR CONDITIONING UNIT	GM:A	GAS METER ASSEMBLY
AH:R	ACCESS HATCH	Н	HEAD HEIGHT OF WINDOW



BR BIKE RACK CL CLOTHES LINE


- EA EAVES GUTTER
- EGL EXISTING GROUND LEVEL
- FH FIRE HYDRANT
- FS FIXED SCREEN TO PREVENT OVERLOOKING IN ACCORDANCE O FIXED WINDOW
- WITH STANDARD B22
- RF:01 ROOF SHEETING MSB MAIN SWITH BOARD
 - OG OBSCURE GLASS

HWU HOT WATER UNIT

LV-O LOUVRES - OPERABLE

LB LETTER BOX

EXTERNAL MATERIALS SCHEDULE

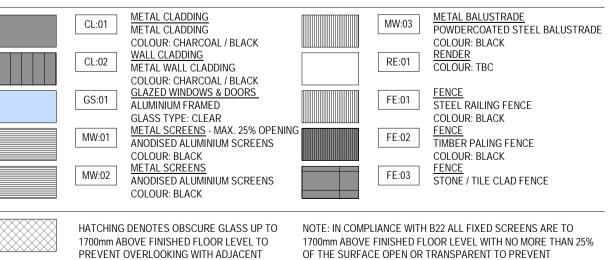

OF THE SURFACE OPEN OR TRANSPARENT TO PREVENT OVERLOOKING WITH ADJACENT NEIGHBOURING PROPERTIES.

S SILL HEIGHT OF WINDOW

WG NON-HABITABLE WINDOW AT

WM:A WATER METER ASSEMBLY

X OPERABLE WINDOW

GROUND LEVEL W1 NON-HABITABLE WINDOW AT LEVEL 1

SSD SUN SHADING DEVICE

SU SUMP

HWGHABITABLE WINDOW AT GROUND LEVELSSD:B SUN SHADING DEVICE - BELOWHW1HABITABLE WINDOW AT LEVEL 1SSD:O SUN SHADING DEVICE - OVER

Project No. C1802

Drawing Elevations - Sheet 2


NEIGHBOURING PROPERTIES

Date Mar 2019

Scale at A1 1:100





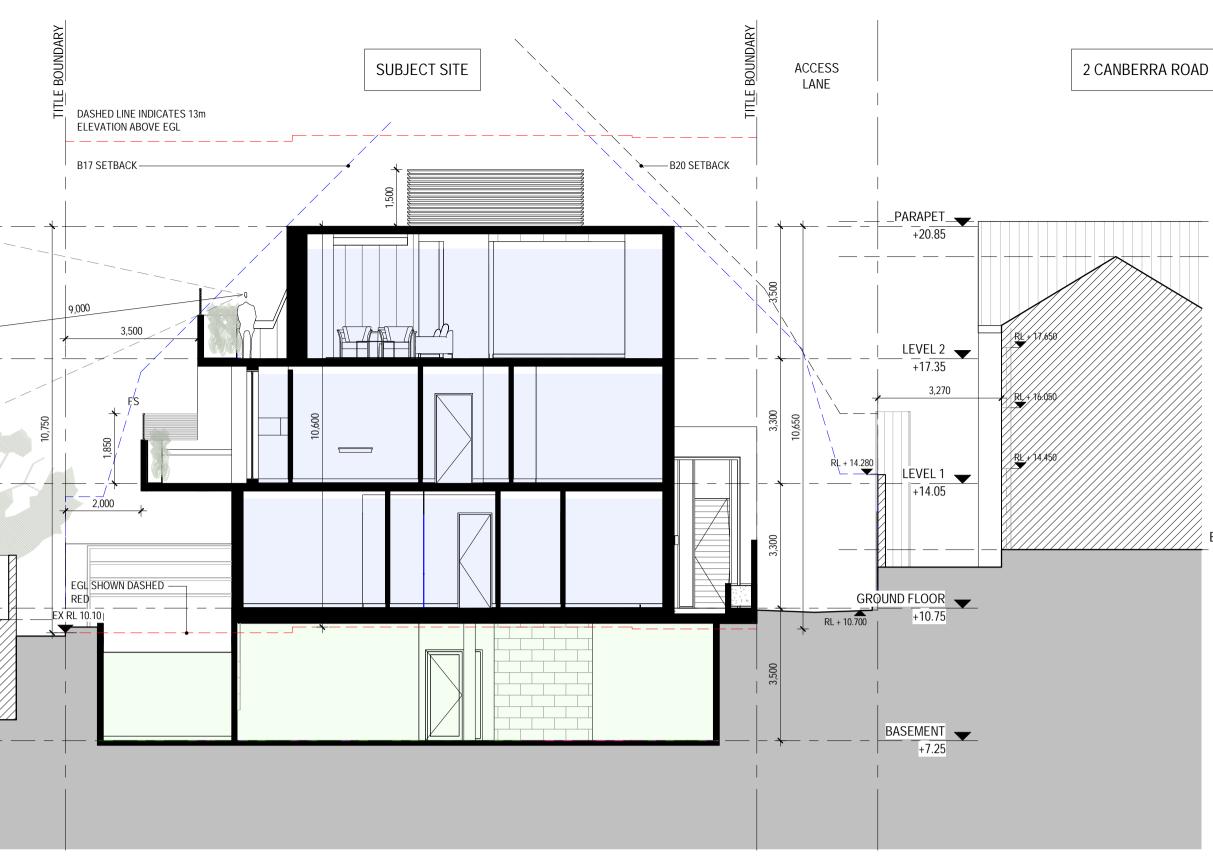

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Drawing Status Town Planning

	RIDGE RL + 20.980
	RIDGE RL + 20.050
	¥
>	

EST. GROUND FFL RL + 12.300

PARAPET RL + 17.740


GROUND FLOOR RL + 10.460

Project No. C1802

Drawing Sections - Sheet 1

_{Date} Mar 2019

Scale at A1 1:100 Drawing No.

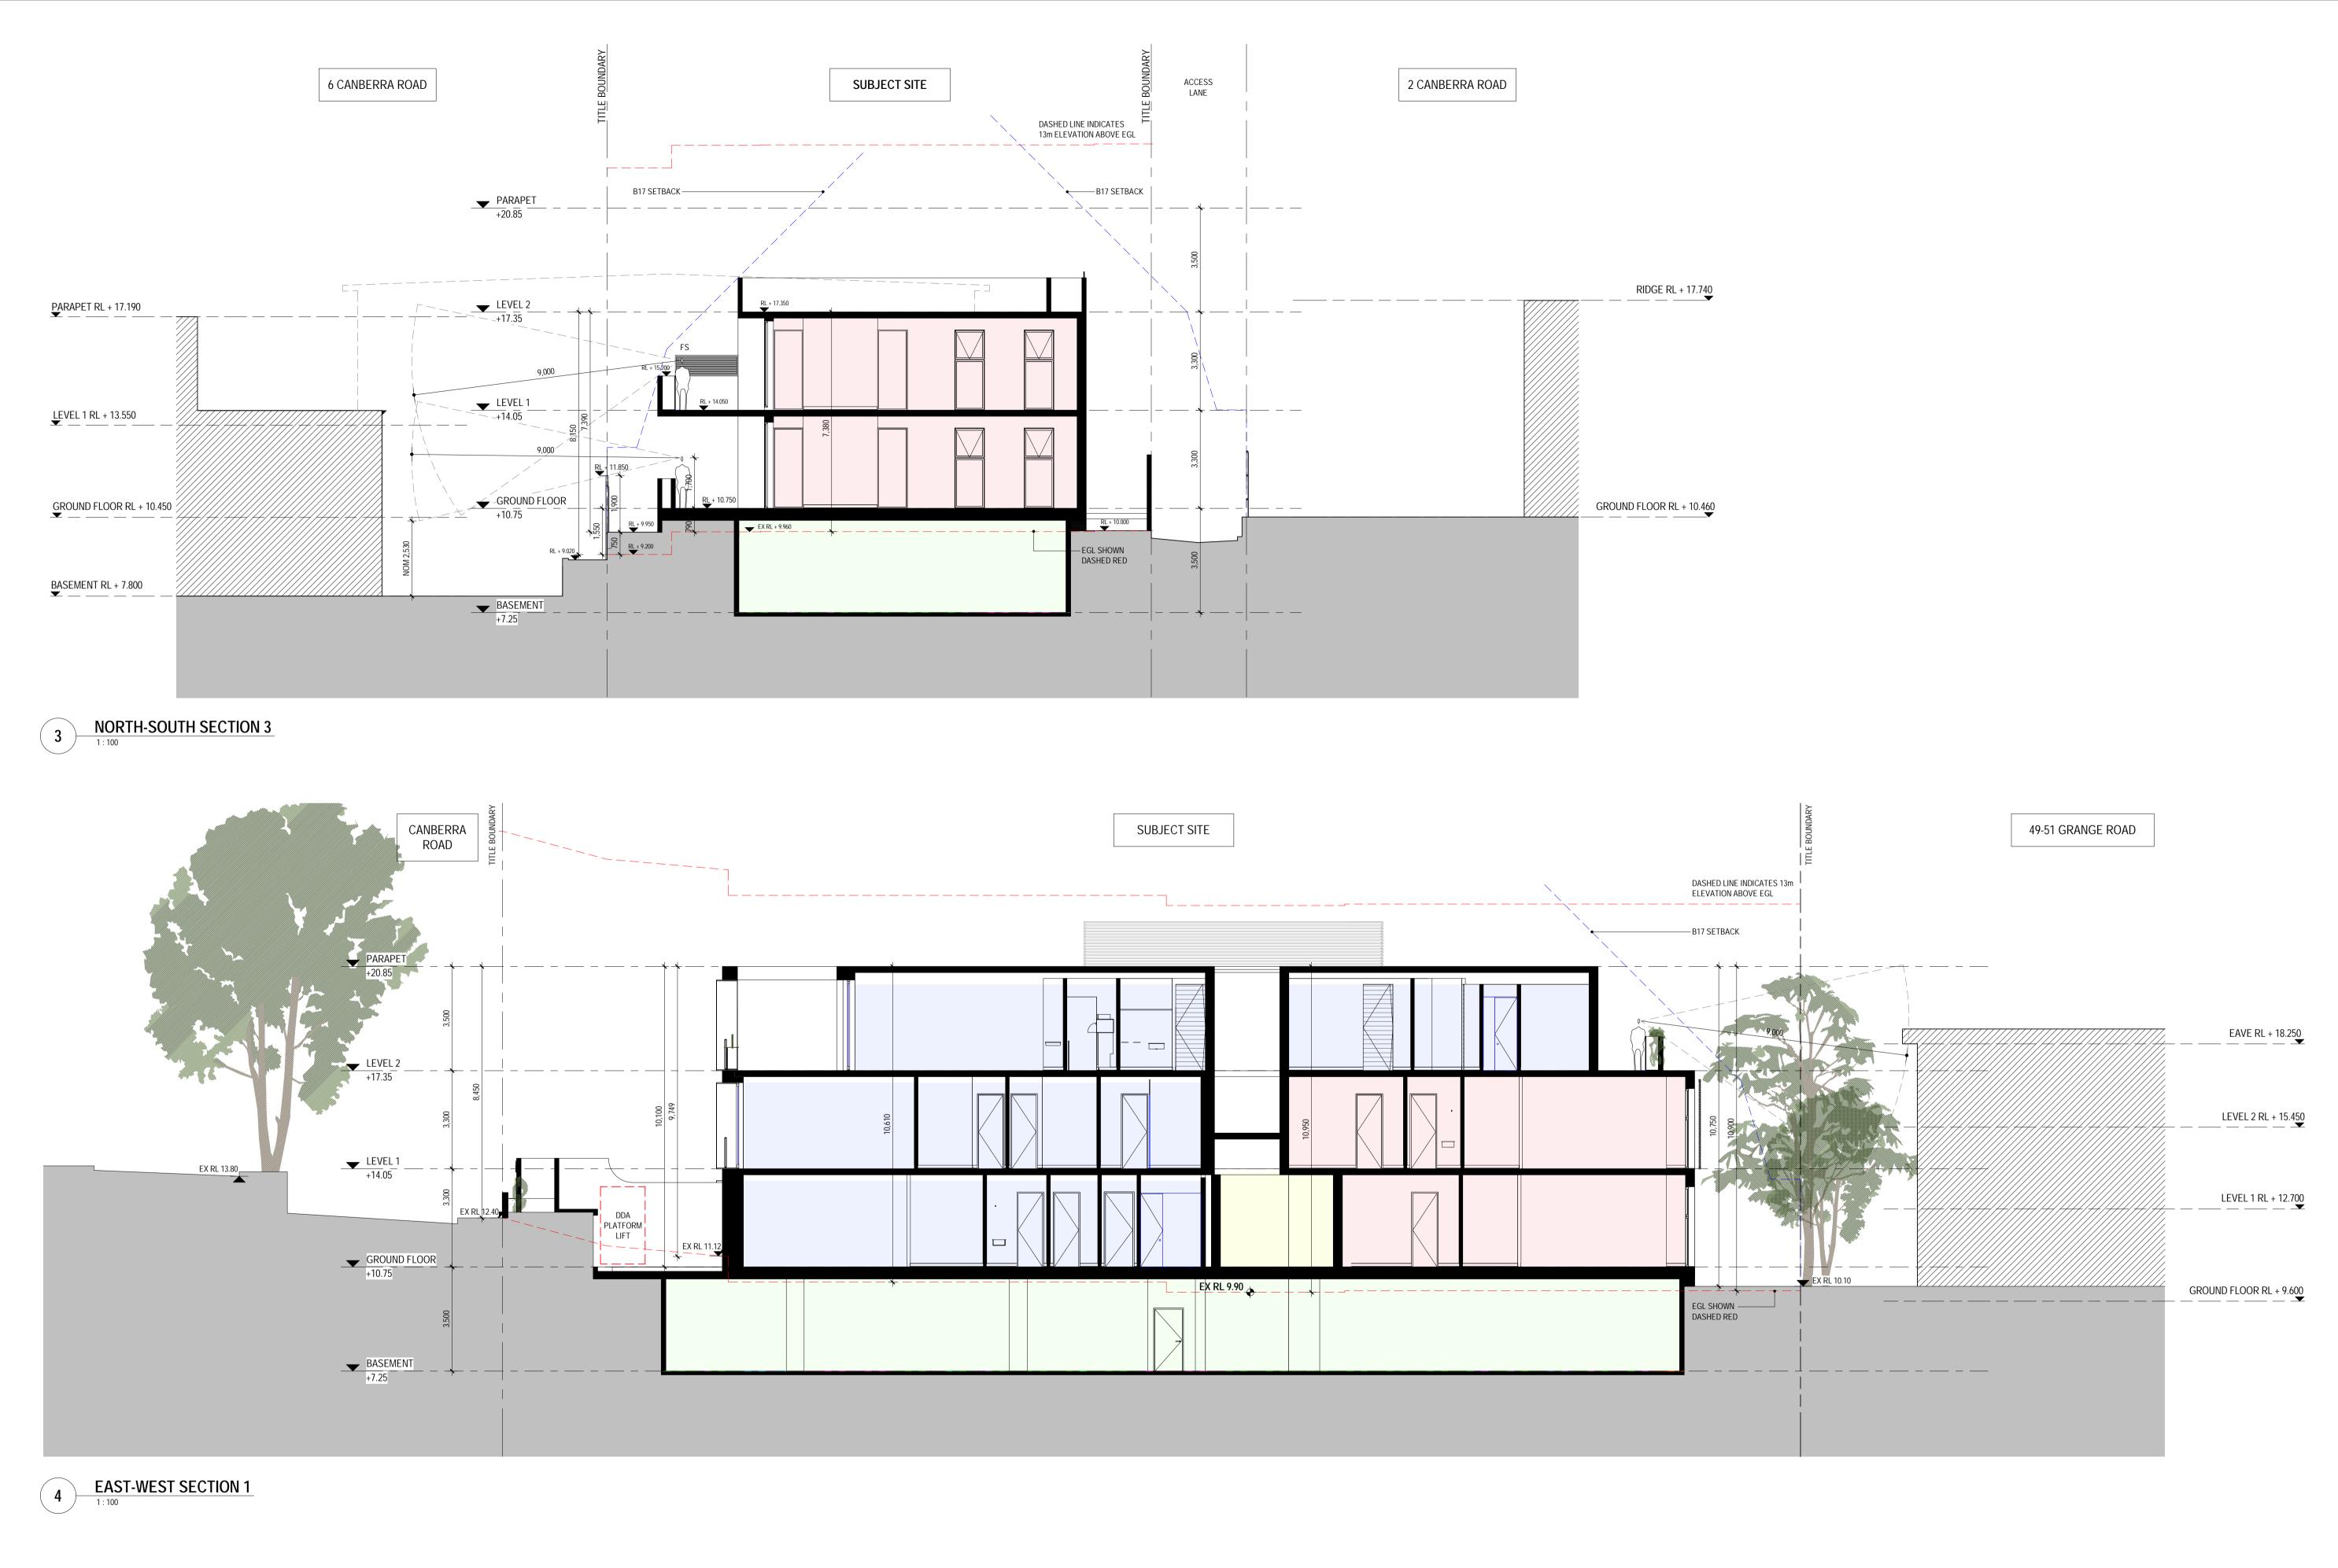

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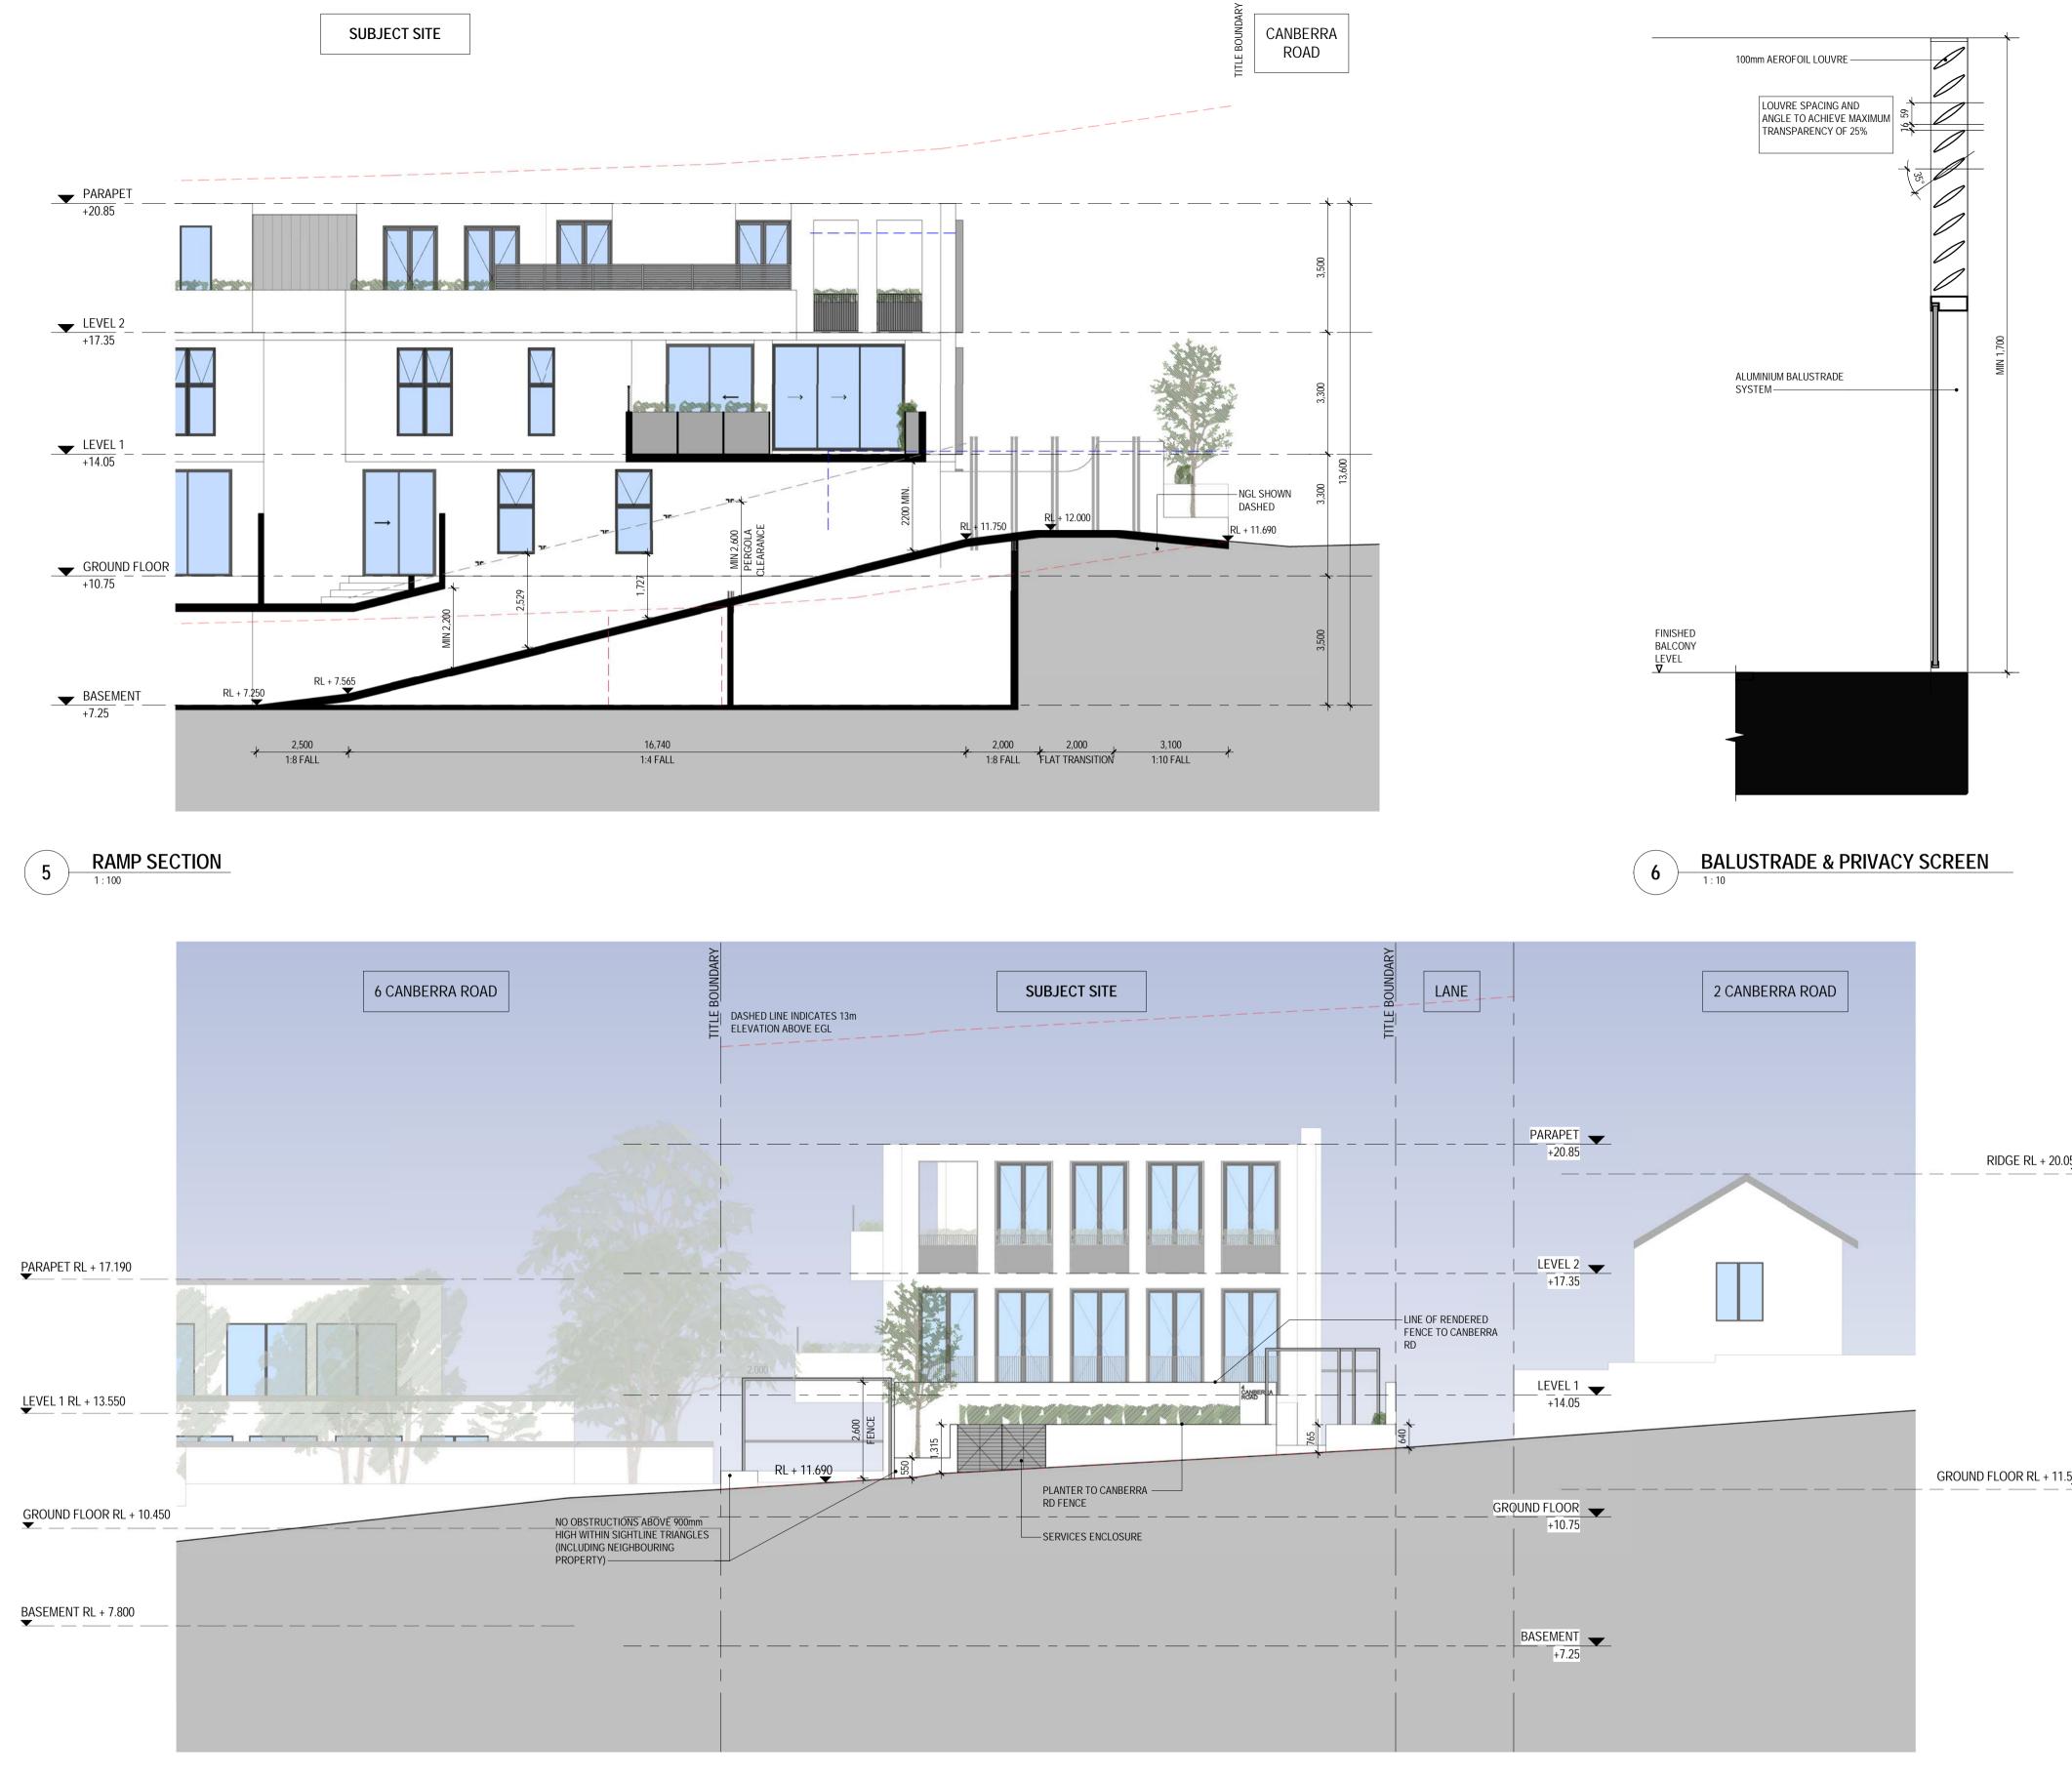


Drawing Sections - Sheet 2

_{Date} Mar 2019

Scale at A1 1:100 Drawing No.





CANBERRA RD - WEST ELEVATION (7) 1:100

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Drawing Status Town Planning

GENERAL NOTES

LANDSCAPING IS INDICATIVE ONLY - REFER TO LANDSCAPE DRAWINGS

1700mm ABOVE FINISHED FLOOR LEVEL TO PREVENT OVERLOOKING WITH ADJACENT

NEIGHBOURING PROPERTIES

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LEGEND


	JEND				
A/C AH:R BG BR CL EA EGL FH FS	AIR CONDITIONING UNIT ACCESS HATCH BOX GUTER BIKE RACK CLOTHES LINE EAVES GUTTER EXISTING GROUND LEVEL FIRE HYDRANT FIXED SCREEN TO PREVENT OVERLOOKING IN ACCORDANCE WITH STANDARD B22	H HWG HW1 HWU LB LV-O	GAS METER ASSEMBLY HEAD HEIGHT OF WINDOW HABITABLE WINDOW AT GROUN HABITABLE WINDOW AT LEVEL HOT WATER UNIT LETTER BOX LOUVRES - OPERABLE ROOF SHEETING MAIN SWITH BOARD FIXED WINDOW OBSCURE GLASS	1 SSD:0 SU WG W1	SILL HEIGHT OF WINDOW SUN SHADING DEVICE 3 SUN SHADING DEVICE - BELOW O SUN SHADING DEVICE - OVER SUMP NON-HABITABLE WINDOW AT GROUND LEVEL NON-HABITABLE WINDOW AT LEVEL WATER METER ASSEMBLY OPERABLE WINDOW
EX	CL:01	<u>ADDING</u> ADDING HARCOA		MW:03	METAL BALUSTRADE POWDERCOATED STEEL BALUSTRADE COLOUR: BLACK
	CL:02 WALL CLAI		DING		RENDER COLOUR: TBC
	GS:01 COLOUR: C GS:01 GLAZED W GLASS TYF	NDOWS FRAME FE: CLEA	& DOORS D	FE:01	FENCE STEEL RAILING FENCE COLOUR: BLACK FENCE

HATCHING DENOTES OBSCURE GLASS UP TO NOTE: IN COMPLIANCE WITH B22 ALL FIXED SCREENS ARE TO 1700mm ABOVE FINISHED FLOOR LEVEL WITH NO MORE THAN 25% OF THE SURFACE OPEN OR TRANSPARENT TO PREVENT OVERLOOKING WITH ADJACENT NEIGHBOURING PROPERTIES.

Project No. C1802

Drawing Date Elevations & Sections - Ramp & Privacy Screens Mar 2019

Scale at A1 Drawing No. As indicated TP20

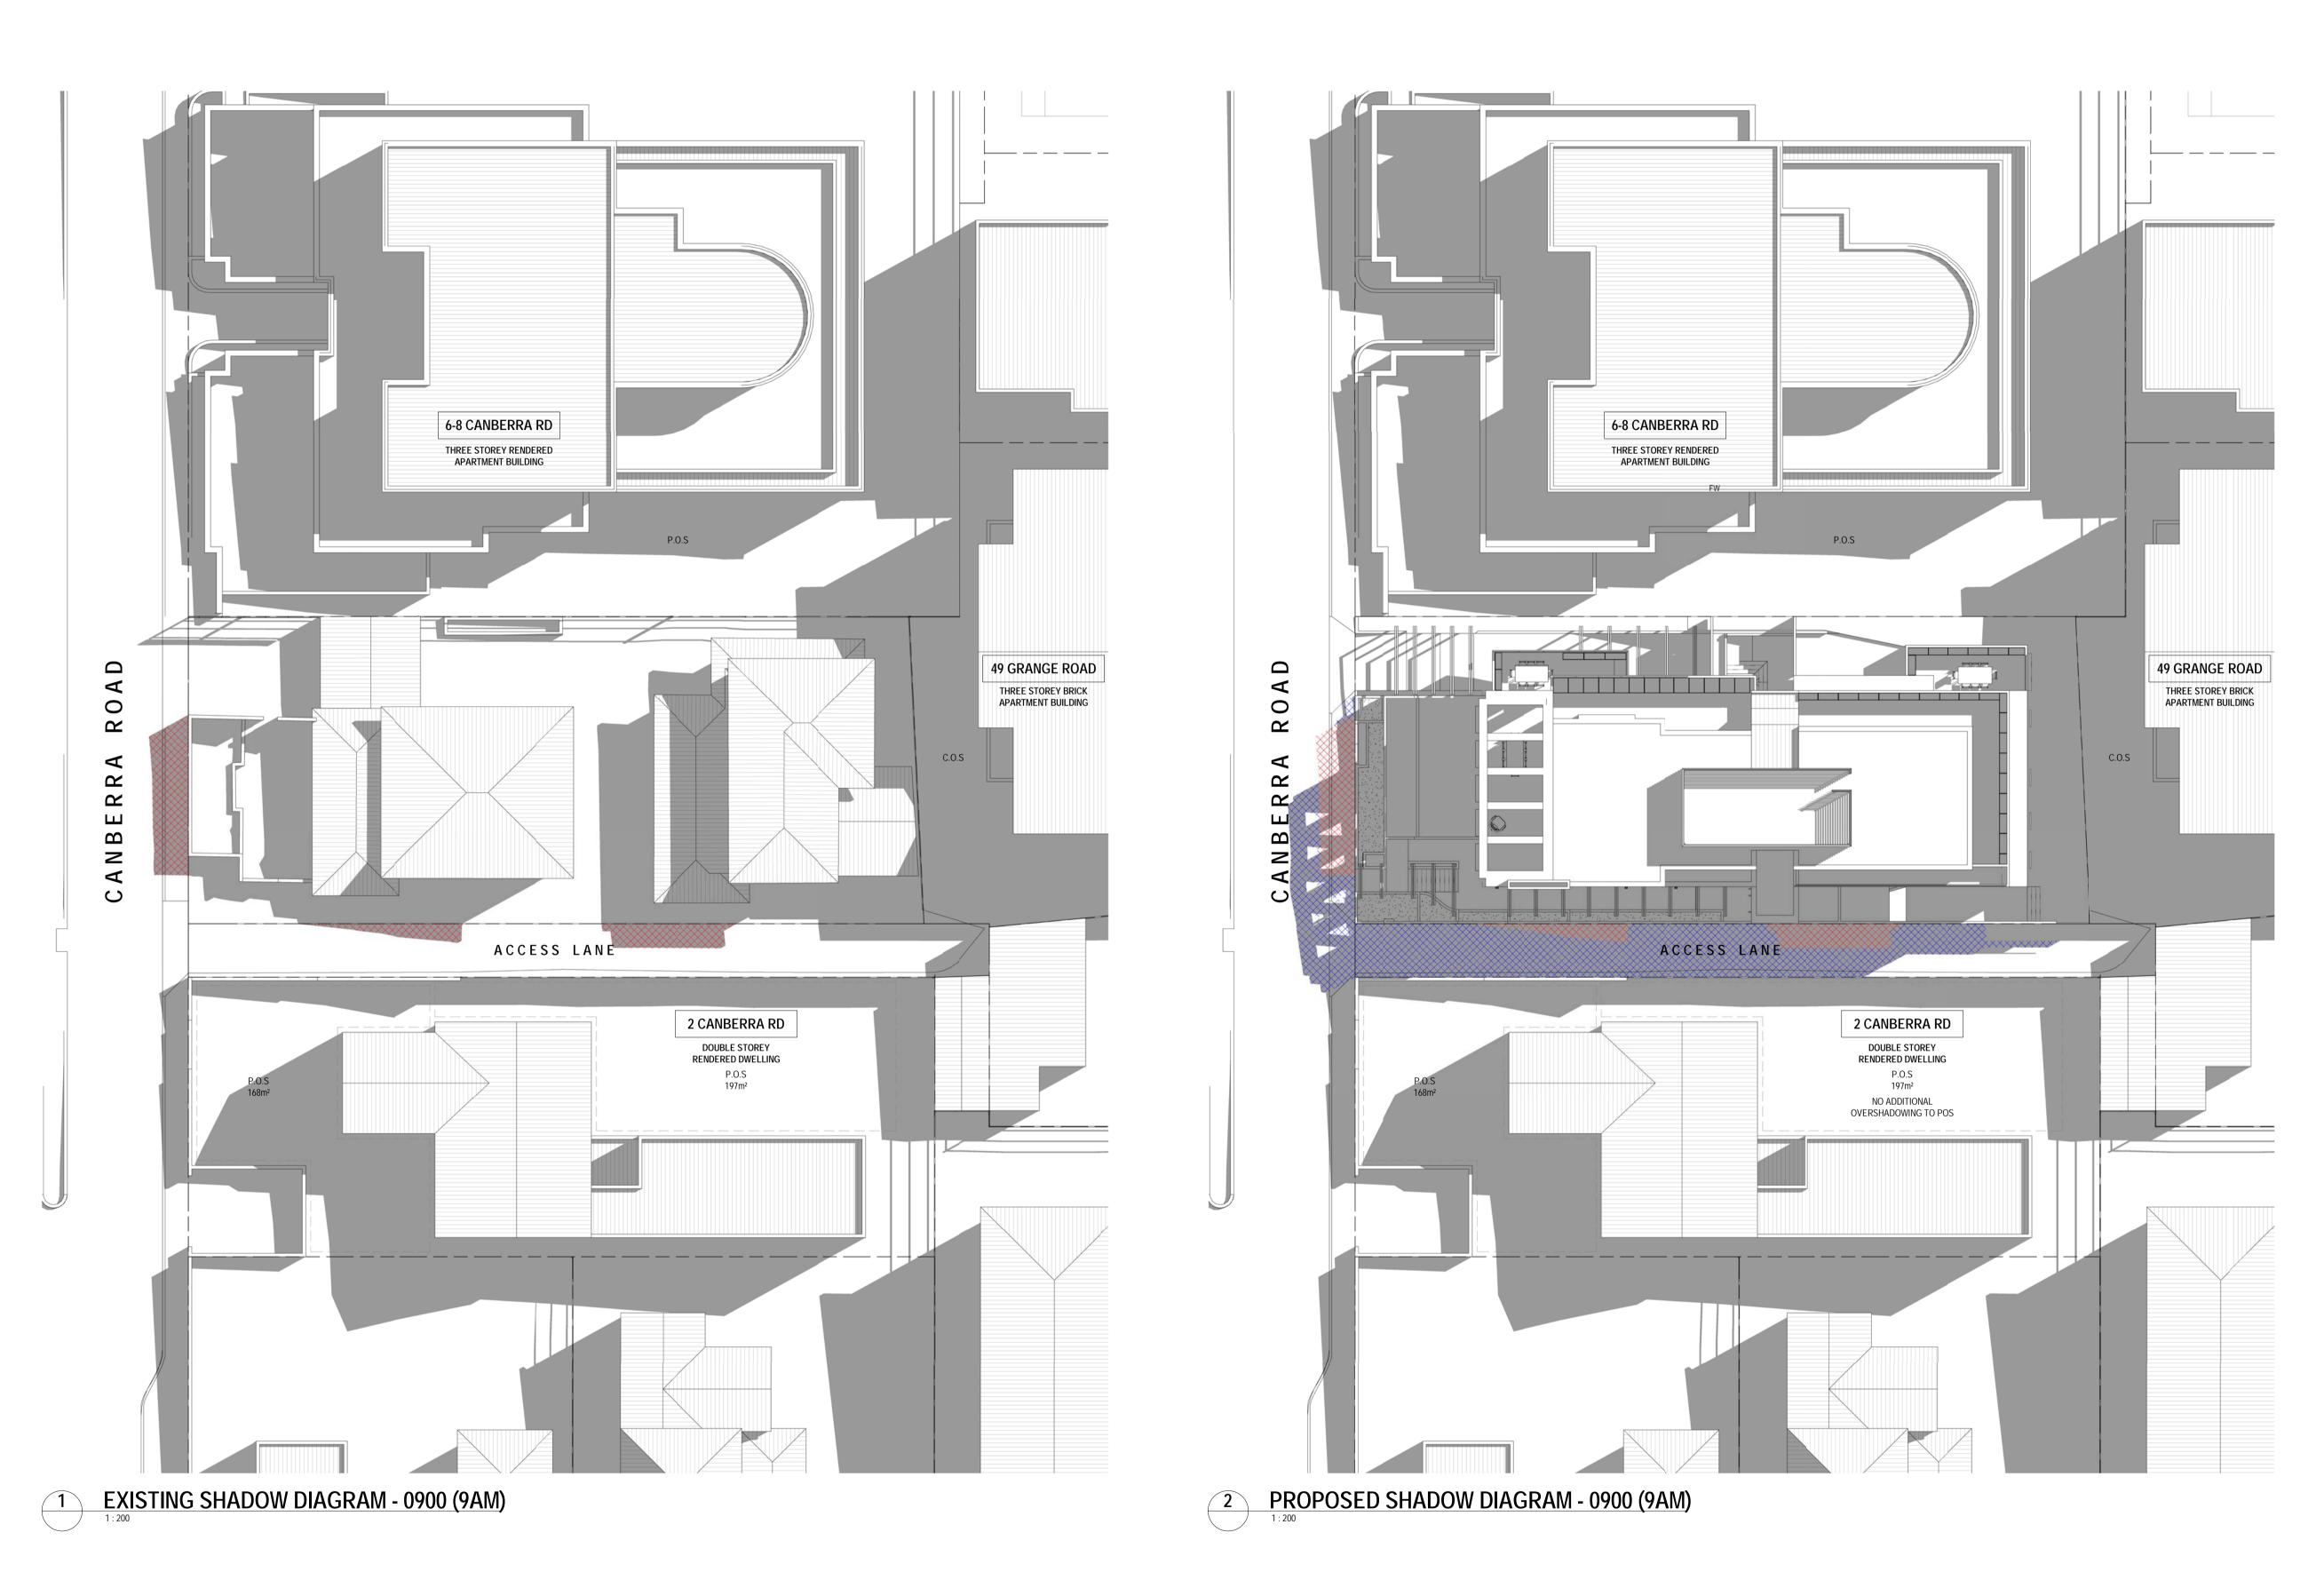

 EXTENT OF EXISTING SHADOWS WITHIN NEIGHBOURING PROPERTIES

 EXTENT OF ADDITIONAL SHADOWS WITHIN NEIGHBOURING PROPERTIES

FENCES INDICATED POSTS AND RAILS ONLY TO CLEARLY DIFFERENTIATE BETWEEN FENCE AND BUILDING SHADOWS

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Project 4a & 4b Canberra Rd, Toorak Project No. C1802 ^{Drawing} Shadow Diagrams - 9am (22 Sept) Date 09/11/13 Drawing Status Town Planning Disclaimer 1. Do not scale drawings. Written dimensions govern. 2. All dimensions are in millimeters unless otherwise noted. 3. All dimensions are to be verified on site prior to proceeding with the work. 4. Conrad Architects are to be notified in writing of any discrepancies. 5. This drawing must be read in conjunction with all relevant contracts, reports specification and drawings. © Copyright of this drawing and the design described herein is vested in Conrad Architects Pty Ltd







EXTENT OF EXISTING SHADOWS WITHIN NEIGHBOURING PROPERTIES EXTENT OF ADDITIONAL SHADOWS WITHIN NEIGHBOURING PROPERTIES


FENCES INDICATED POSTS AND RAILS ONLY TO CLEARLY DIFFERENTIATE BETWEEN FENCE AND BUILDING SHADOWS

Conrad Architects

Proj	•	Project No.
4a	& 4b Canberra Rd, Toorak	C1802
Dra	wing	Date
Sh	adow Diagrams - 12noon (22 Sept)	11/18/14
Dra	wing Status	
То	wn Planning	
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5. ©	5	





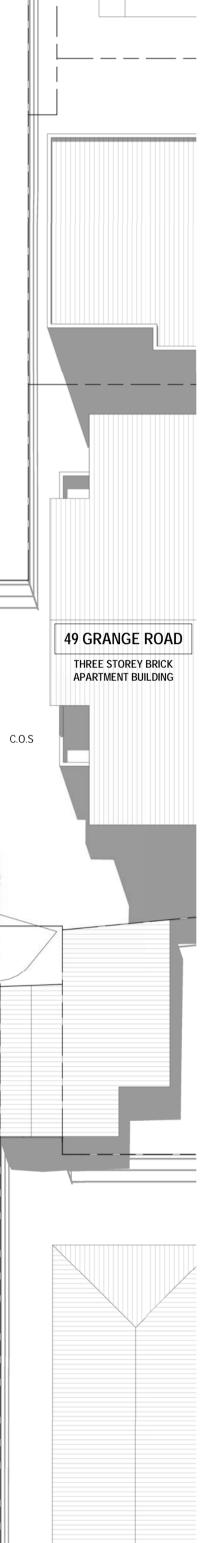

EXTENT OF EXISTING SHADOWS WITHIN NEIGHBOURING PROPERTIESEXTENT OF ADDITIONAL SHADOWS WITHIN NEIGHBOURING PROPERTIES

FENCES INDICATED POSTS AND RAILS ONLY TO CLEARLY DIFFERENTIATE BETWEEN FENCE AND BUILDING SHADOWS

Conrad Architects

Project 4a & 4b Canberra Rd, Toorak Project No. C1802 Drawing Date Shadow Diagrams - 1pm (22 Sept) 11/18/14 Drawing Status Town Planning Disclaimer 1. Do not scale drawings. Written dimensions govern. 2. All dimensions are in millimeters unless otherwise noted. 3. All dimensions are to be verified on site prior to proceeding with the work. 4. Conrad Architects are to be notified in writing of any discrepancies. 5. This drawing must be read in conjunction with all relevant contracts, reports specification and drawings. © Copyright of this drawing and the design described herein is vested in Conrad Architects Pty Ltd





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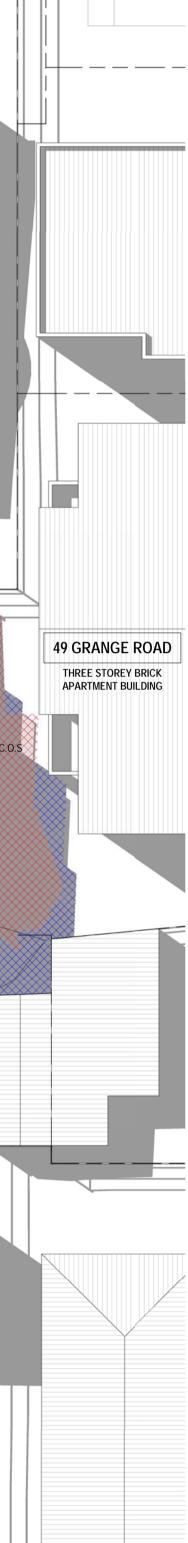
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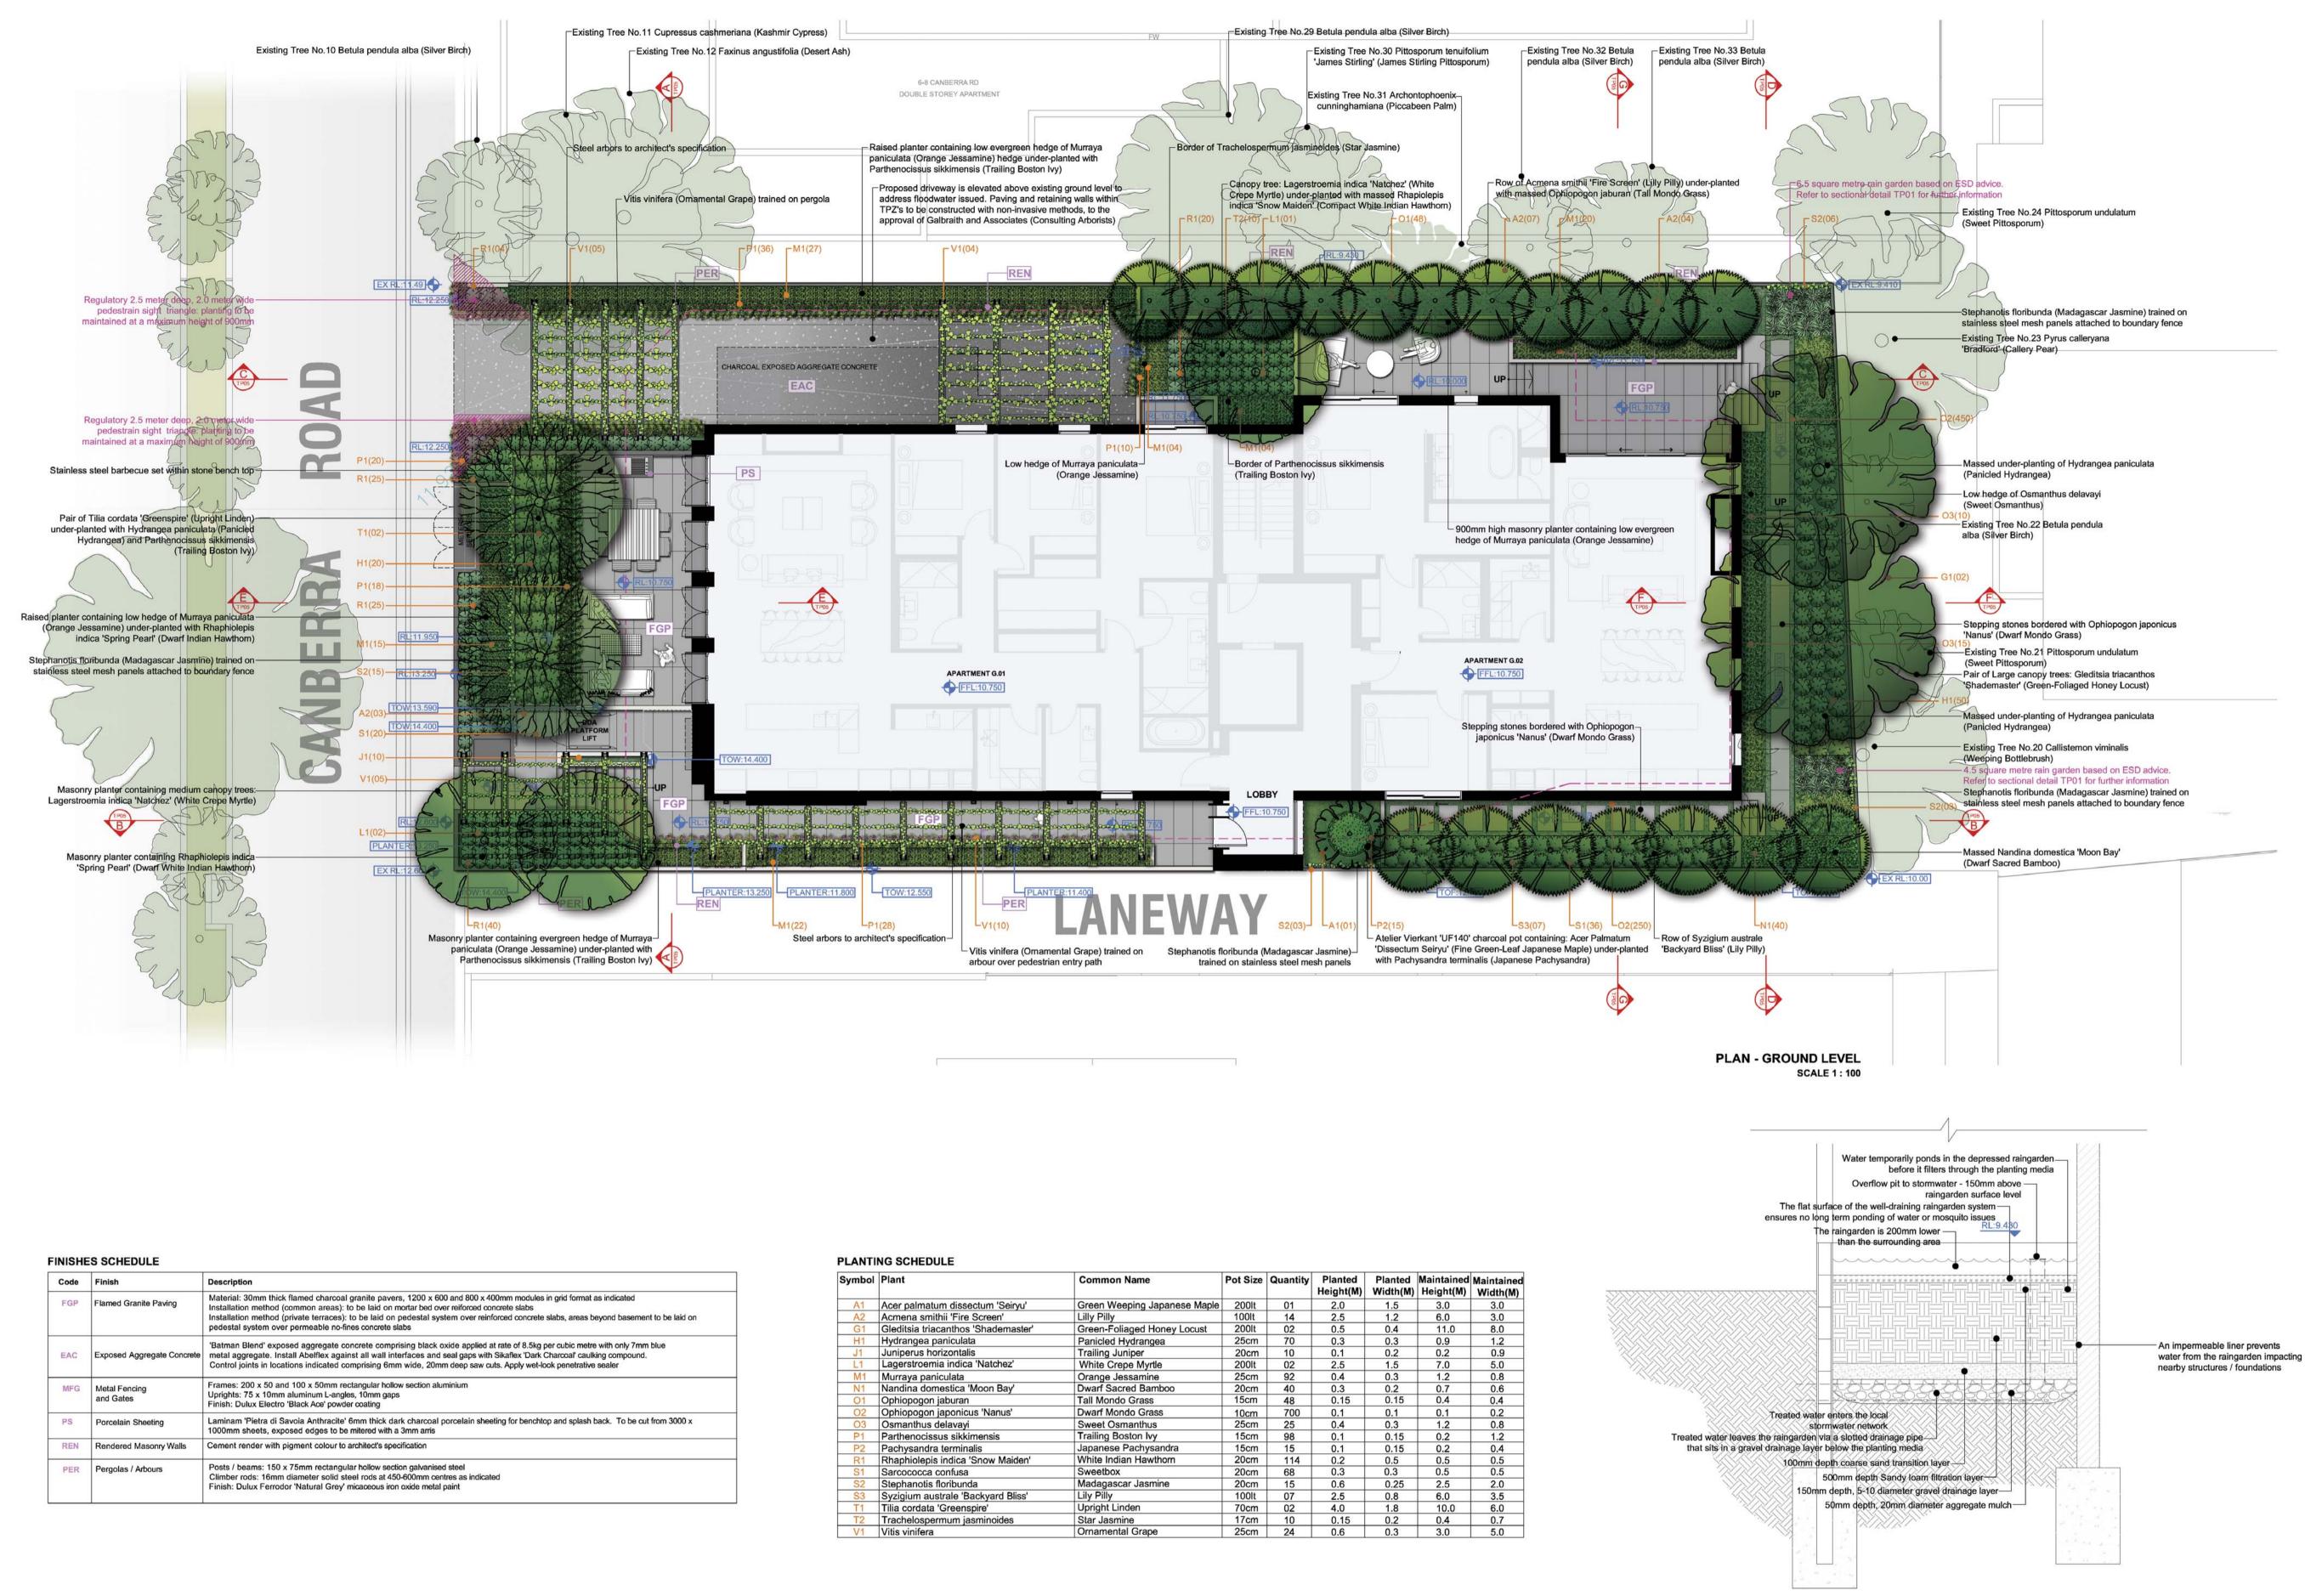
EXTENT OF EXISTING SHADOWS WITHIN NEIGHBOURING PROPERTIESEXTENT OF ADDITIONAL SHADOWS WITHIN NEIGHBOURING PROPERTIES

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Code	Finish	Description
FGP	Flamed Granite Paving	Material: 30mm thick flamed charcoal granite pavers, 1200 x 600 and 800 x 400mm modules in grid format as indicated Installation method (common areas): to be laid on mortar bed over reiforced concrete slabs Installation method (private terraces): to be laid on pedestal system over reinforced concrete slabs, areas beyond basement to be laid on pedestal system over permeable no-fines concrete slabs
EAC	Exposed Aggregate Concrete	'Batman Blend' exposed aggregate concrete comprising black oxide applied at rate of 8.5kg per cubic metre with only 7mm blue metal aggregate. Install Abelflex against all wall interfaces and seal gaps with Sikaflex 'Dark Charcoal' caulking compound. Control joints in locations indicated comprising 6mm wide, 20mm deep saw cuts. Apply wet-look penetrative sealer
MFG	Metal Fencing and Gates	Frames: 200 x 50 and 100 x 50mm rectangular hollow section aluminium Uprights: 75 x 10mm aluminum L-angles, 10mm gaps Finish: Dulux Electro 'Black Ace' powder coating
PS	Porcelain Sheeting	Laminam 'Pietra di Savoia Anthracite' 6mm thick dark charcoal porcelain sheeting for benchtop and splash back. To be cut from 3000 x 1000mm sheets, exposed edges to be mitered with a 3mm arris
REN	Rendered Masonry Walls	Cement render with pigment colour to architect's specification
PER	Pergolas / Arbours	Posts / beams: 150 x 75mm rectangular hollow section galvanised steel Climber rods: 16mm diameter solid steel rods at 450-600mm centres as indicated Finish: Dulux Ferrodor 'Natural Grey' micaceous iron oxide metal paint

Jack Merlo Design & Landscape

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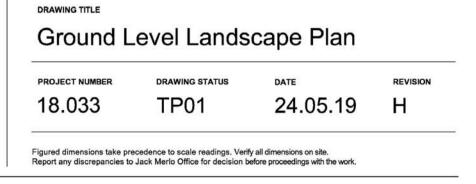
Symbol	Plant	Common Name	Pot Size	Quantity	Planted Height(M)	Planted Width(M)	Maintained Height(M)	Maintained Width(M)
A1	Acer palmatum dissectum 'Seiryu'	Green Weeping Japanese Maple	200lt	01	2.0	1.5	3.0	3.0
A2	Acmena smithii 'Fire Screen'	Lilly Pilly	100lt	14	2.5	1.2	6.0	3.0
G1	Gleditsia triacanthos 'Shademaster'	Green-Foliaged Honey Locust	200lt	02	0.5	0.4	11.0	8.0
H1	Hydrangea paniculata	Panicled Hydrangea	25cm	70	0.3	0.3	0.9	1.2
J1	Juniperus horizontalis	Trailing Juniper	20cm	10	0.1	0.2	0.2	0.9
L1	Lagerstroemia indica 'Natchez'	White Crepe Myrtle	200lt	02	2.5	1.5	7.0	5.0
M1	Murraya paniculata	Orange Jessamine	25cm	92	0.4	0.3	1.2	0.8
N1	Nandina domestica 'Moon Bay'	Dwarf Sacred Bamboo	20cm	40	0.3	0.2	0.7	0.6
01	Ophiopogon jaburan	Tall Mondo Grass	15cm	48	0.15	0.15	0.4	0.4
02	Ophiopogon japonicus 'Nanus'	Dwarf Mondo Grass	10cm	700	0.1	0.1	0.1	0.2
03	Osmanthus delavayi	Sweet Osmanthus	25cm	25	0.4	0.3	1.2	0.8
P1	Parthenocissus sikkimensis	Trailing Boston Ivy	15cm	98	0.1	0.15	0.2	1.2
P2	Pachysandra terminalis	Japanese Pachysandra	15cm	15	0.1	0.15	0.2	0.4
R1	Rhaphiolepis indica 'Snow Maiden'	White Indian Hawthorn	20cm	114	0.2	0.5	0.5	0.5
S1	Sarcococca confusa	Sweetbox	20cm	68	0.3	0.3	0.5	0.5
S2	Stephanotis floribunda	Madagascar Jasmine	20cm	15	0.6	0.25	2.5	2.0
S3	Syzigium australe 'Backyard Bliss'	Lily Pilly	100lt	07	2.5	0.8	6.0	3.5
T1	Tilia cordata 'Greenspire'	Upright Linden	70cm	02	4.0	1.8	10.0	6.0
T2	Trachelospermum jasminoides	Star Jasmine	17cm	10	0.15	0.2	0.4	0.7
V1	Vitis vinifera	Ornamental Grape	25cm	24	0.6	0.3	3.0	5.0

PROJECT TITLE 4A-4B Canberra Road, Toorak DJ Canberra Road Development Pty Ltd SCALE 1:100, PAGE A1

RAIN GARDEN SECTIONAL DETAIL SCALE 1 : 20

NORTH

A





FINISHES SCHEDULE

Code	Finish	Description
FGP	Flamed Granite Paving	Material: 30mm thick flamed charcoal granite pavers, 1200 x 600 and 800 x 4 Installation method (common areas): to be laid on mortar bed over reiforced or Installation method (private terraces): to be laid on pedestal system over rein pedestal system over permeable no-fines concrete slabs
MC	Metal Cladding	6-10mm thick (as indicated) aluminium panels attached to face of masonry w
PS	Porcelain Sheeting	Laminam 'Pietra di Savoia Anthracite' 6mm thick dark charcoal porcelain she 1000mm sheets, exposed edges to be mitered with a 3mm arris

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x 400mm modules in grid format as indicated d concrete slabs reinforced concrete slabs, areas beyond basement to be laid on y walls and planters. Dulux Electro 'Black Ace' powder coat finish heeting for benchtop and splash back. To be cut from 3000 x

PLANTING SCHEDULE

Symbol	Plant	Common Name	Pot Size	Quantity	Planted Height(M)		Maintained Height(M)	Maintainec Width(M)
C1	Cotoneaster dammeri	Trailing Cotoneaster	20cm	27	0.1	0.2	0.2	1.0
M1	Murraya paniculata	Orange Jessamine	25cm	12	0.4	0.3	1.2	0.8
R1	Rhaphiolepis indica 'Snow Maiden'	White Indian Hawthorn	20cm	20	0.2	0.5	0.5	0.5



Road, Toorak	DRAWING TITLE	Landscape	Plan	
elopment Pty Ltd	PROJECT NUMBER	drawing status	^{date} 24.05.19	REVISION
(\uparrow)		ecedence to scale readings. Veri Jack Merlo Office for decision b		



FINISHES SCHEDULE

rinioni								
Code	Finish	Description						
FGP	Flamed Granite Paving	Material: 30mm thick flamed charcoal granite pavers, 1200 x 600 an Installation method (common areas): to be laid on mortar bed over re Installation method (private terraces): to be laid on pedestal system pedestal system over permeable no-fines concrete slabs						
MC	Metal Cladding	6-10mm thick (as indicated) aluminium panels attached to face of m						
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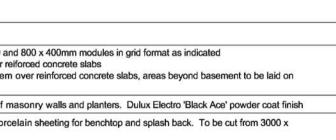
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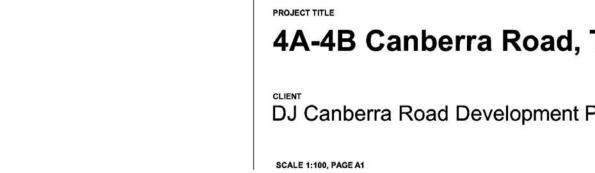
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Symbol	Plant	Common Name	Pot Size	Quantity	Planted Height(M)	Planted Width(M)	Maintained Height(M)	Maintained Width(M)
J1	Juniperus horizontalis	Trailing Juniper	20cm	33	1.5	0.2	0.2	0.9
R1	Rhaphiolepis indica 'Snow Maiden'	White Indian Hawthorn	20cm	75	0.2	0.5	0.5	0.5





Road, Toorak	Level 02	Landscape	Plan	
lopment Pty Ltd	PROJECT NUMBER 18.033	drawing status	^{date} 24.05.19	
		ecedence to scale readings. Veri o Jack Merlo Office for decision b		




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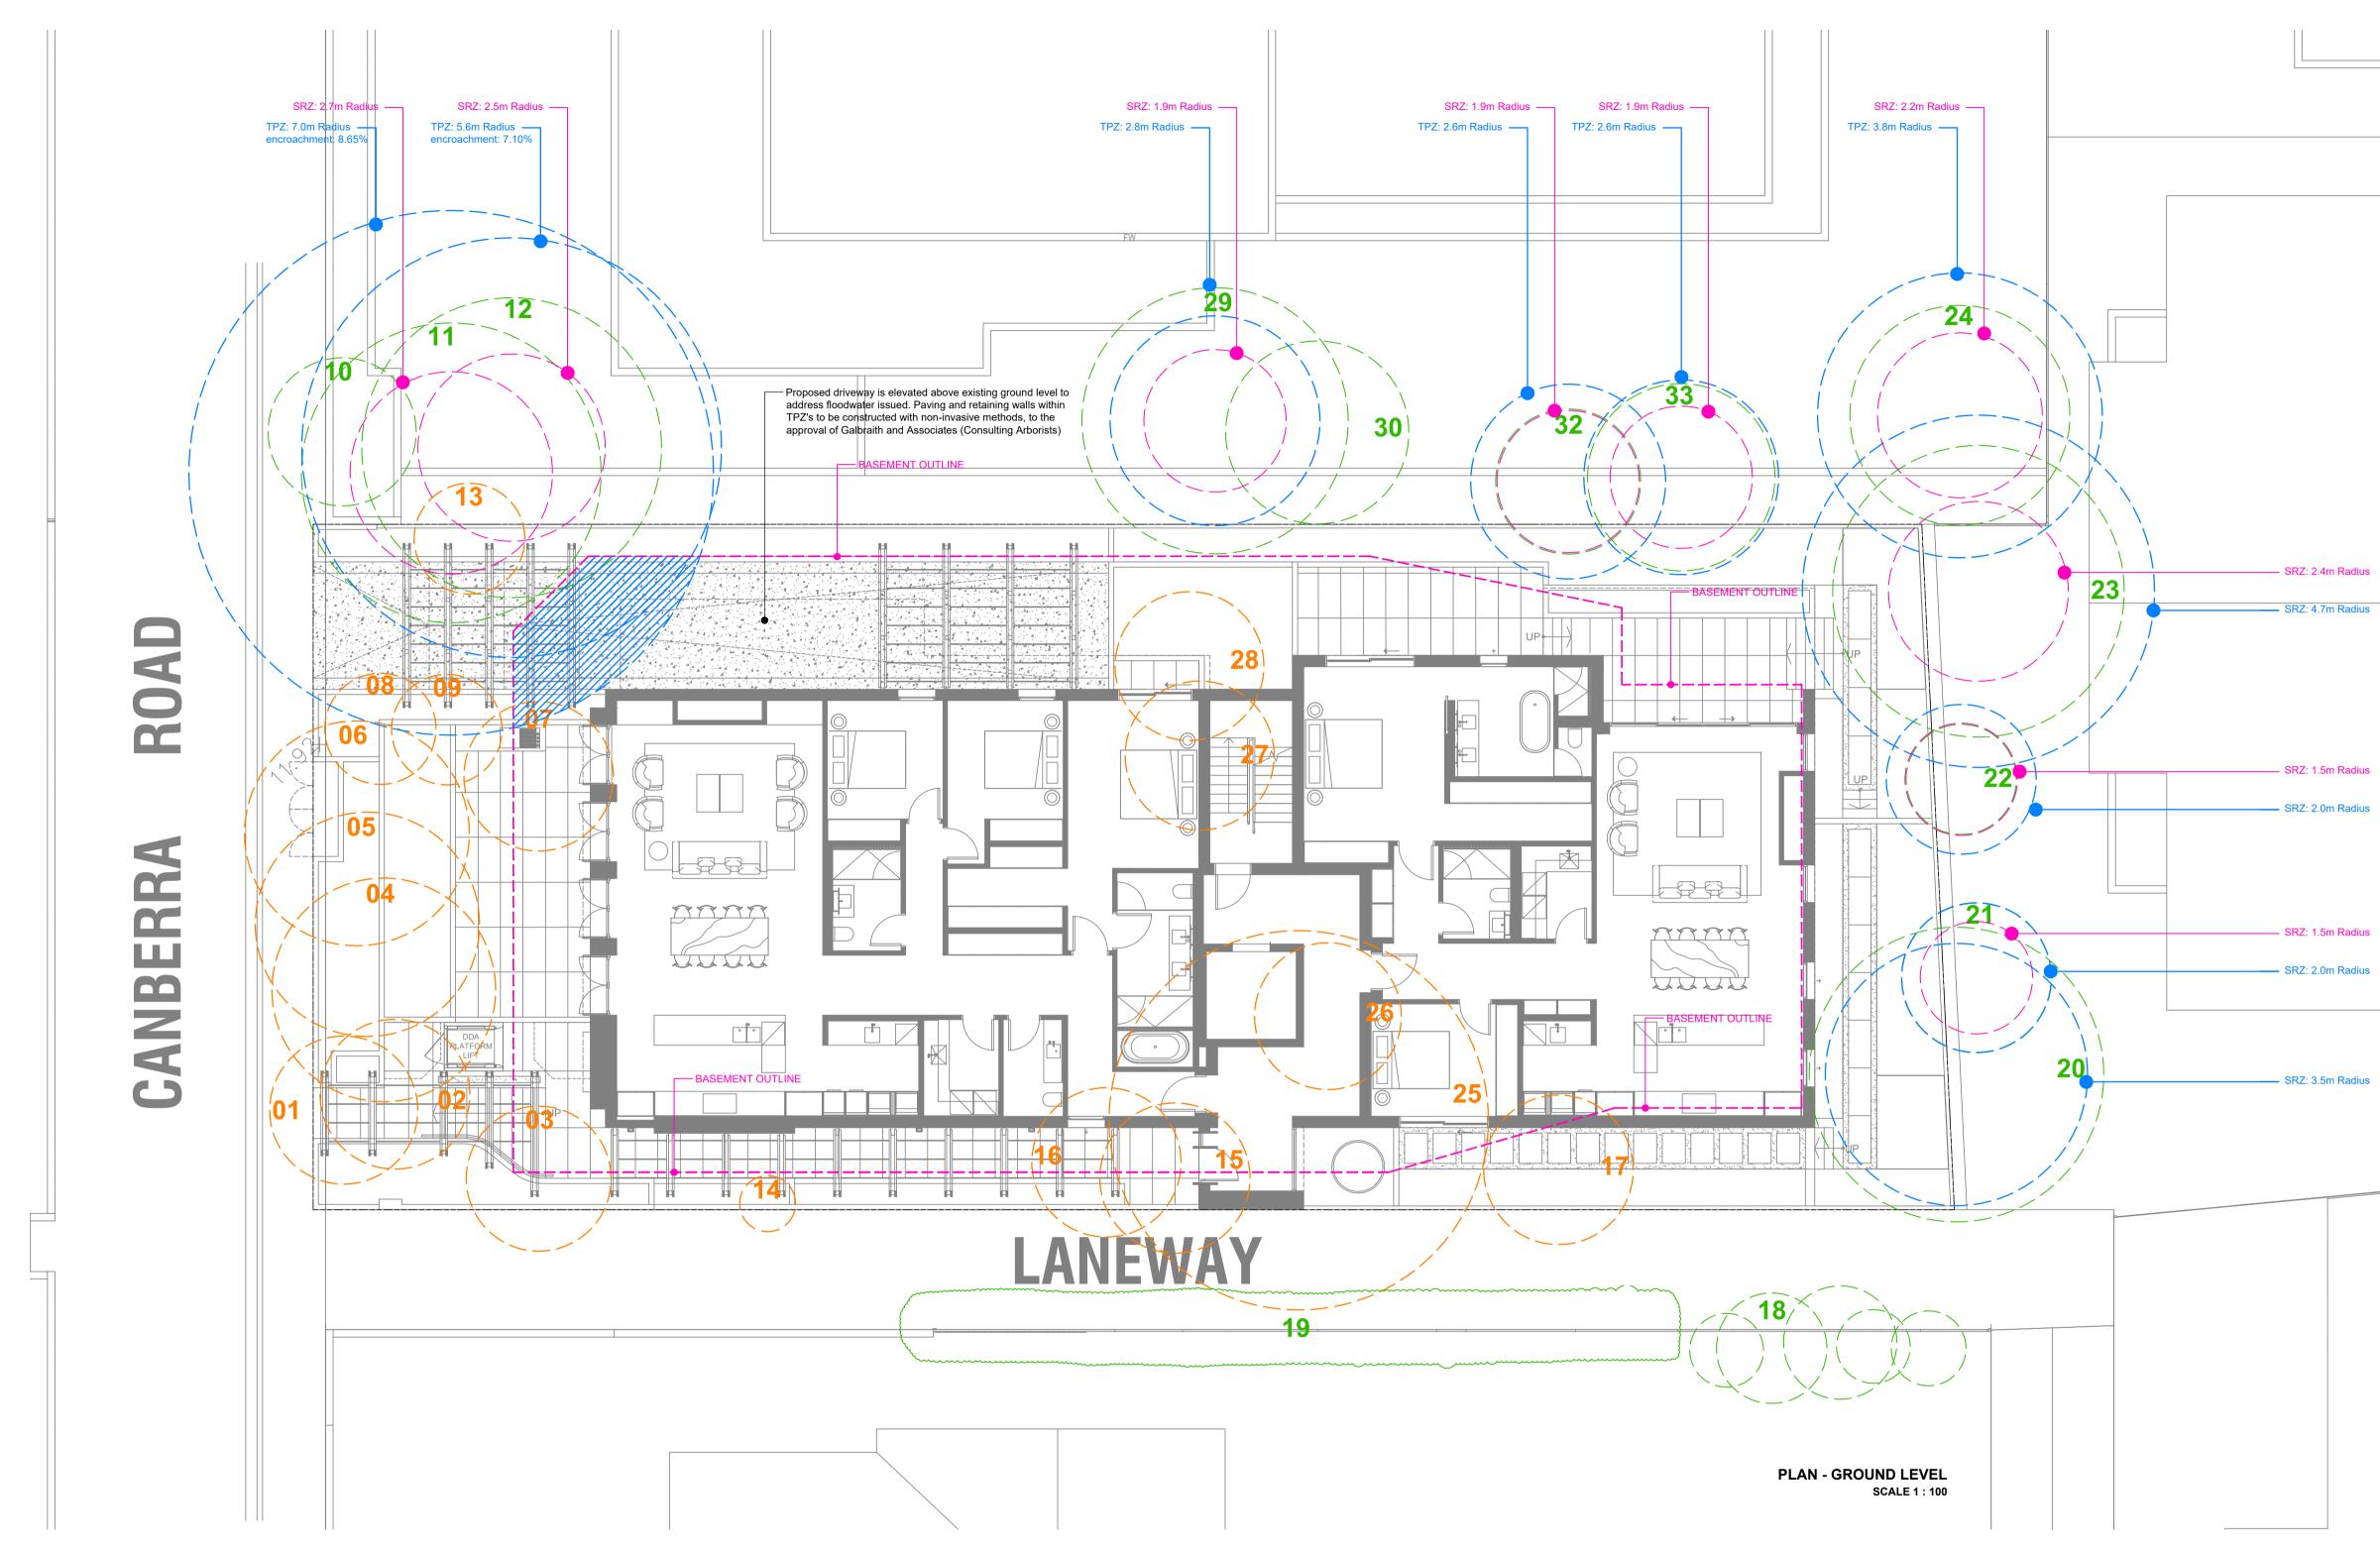
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18.033 **TP04**

24.05.19

Figured dimensions take precedence to scale readings. Verify all dimensions on site. Report any discrepancies to Jack Merlo Office for decision before proceedings with the work.



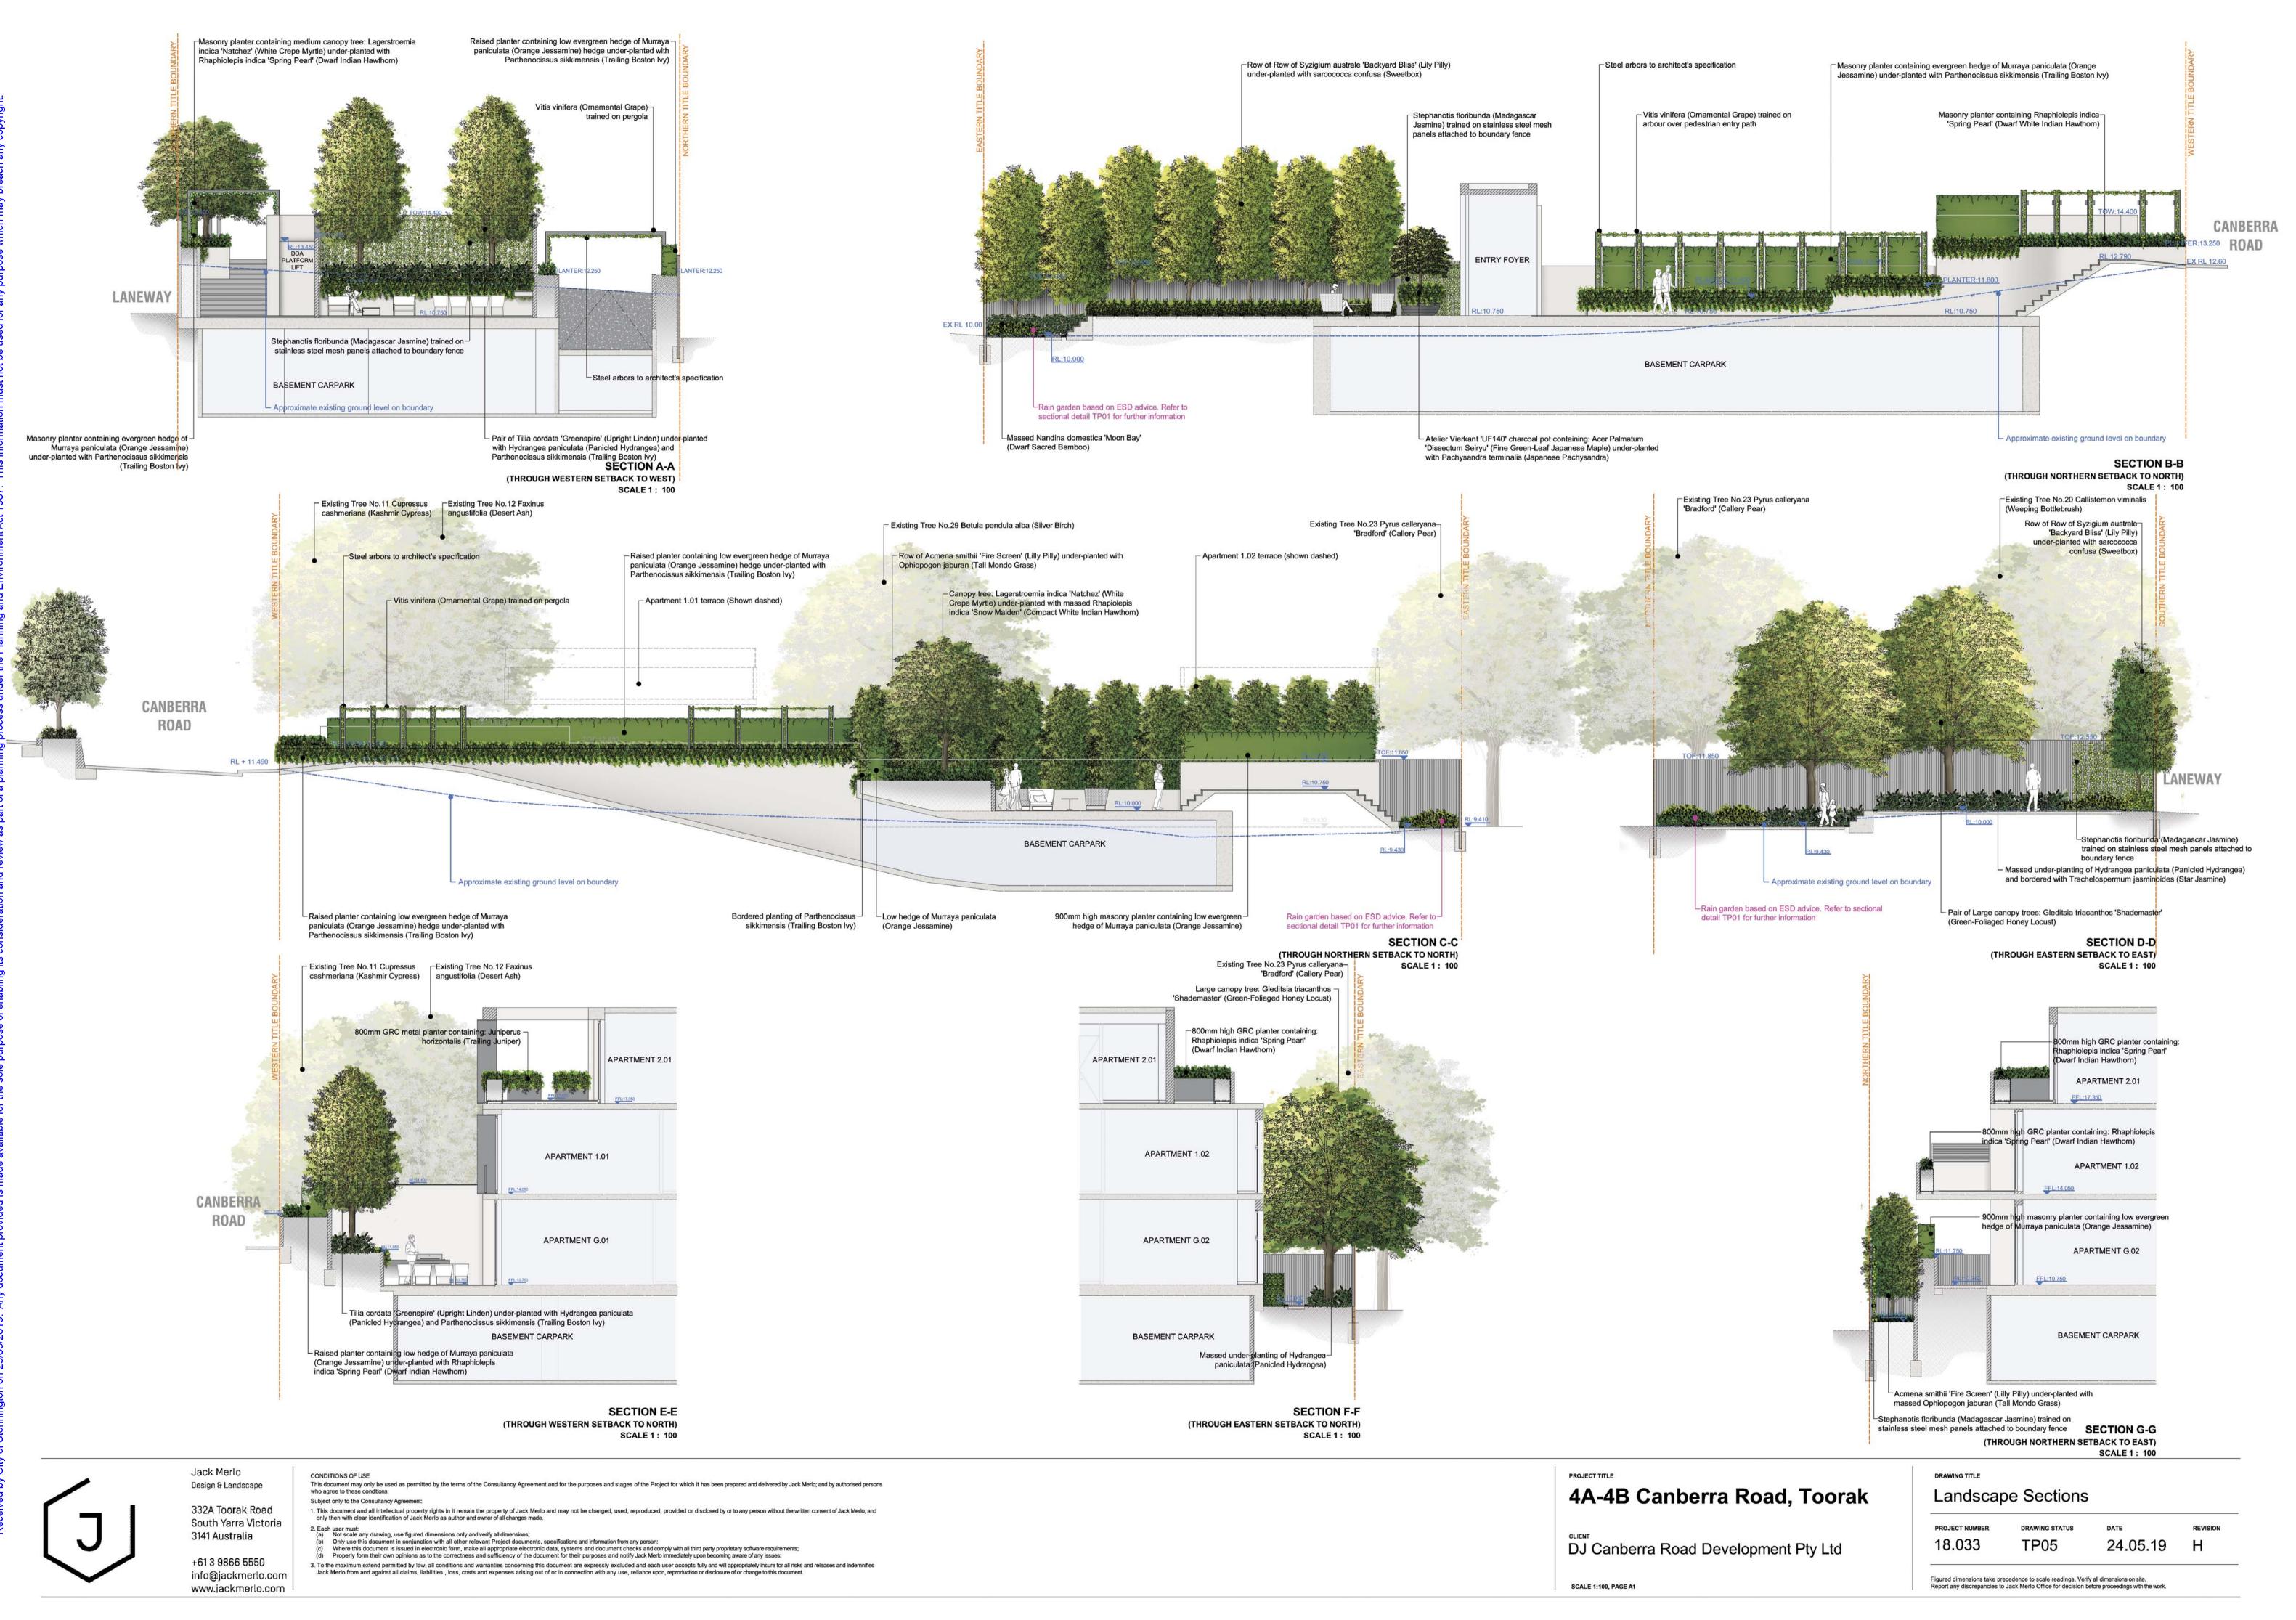

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, and	4A-4B Canberra Road, Toorak	drawing title Tree Ma	nagement F	Plan	
	DJ Canberra Road Development Pty Ltd	project number 18.033	drawing status	^{date} 24.05.19	REVISION H
fies	SCALE 1:100, PAGE A1	Figured dimensions take pr Report any discrepancies to	ecedence to scale readings. Verify o Jack Merlo Office for decision be	all dimensions on site. fore proceedings with the work.	

TABLE

Symbol	Description
\bigcirc	Existing tree - to be retained
\bigcirc	Existing tree - to be removed
\bigcirc	Structural Root Zone (SRZ)
	Tree Protection Zone (TPZ)

EXISTING TREE SCHEDULE

Tree No. Botanical Name

1 Olea europea Olive Silver Birch Betula pendula alba Betula pendula alba Silver Birch Betula pendula alba Silver Birch Silver Birch Betula pendula alba Betula pendula alba Silver Birch Arbutus unedo Strawberry Tree 8 Salix humboldtii Chilean Willow 9 Salix humboldtii Chilean Willow 10 Betula pendula alba Silver Birch 11 Cupressus cashmeriana Kashmir Cypress 12Faxinus angustifolia13Ligustrum lucidum Desert Ash Large Leaved Privet Norway Spruce 14 Picea abies 15 Schefflera actinophylla Umbrella Tree 16 Pittosporum tenuifolium 'James Stirling' James Stirling Pittosporum 17 Betula pendula 'Plena' Weeping Birch 18 Weeping Lillypillies Waterhousea Floribunda 19Weeping Lillypillies20Callistemon viminalis Waterhousea Floribunda Weeping Bottlebrush 21 Pittosporum undulatum Sweet Pittosporum 22 Betula pendula alba Silver Birch 23 Pyrus calleryana 'Bradford' Callery Pear 24 Pittosporum undulatum Sweet Pittosporum

Common Name

Silver Birch

Silver Birch

Silver Birch

Silver Birch

Silver Birch

Japanese Maple

Chinese Magnolia

James Stirling Pittosporum

To be retained or removed

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GENERAL NOTES

25 Betula pendula alba

26 Betula pendula alba

29 Betula pendula alba

32Betula pendula alba33Betula pendula alba

28 Magnolia x soulangeana

Betula pendula alba


30 Pittosporum tenuifolium 'James Stirling'

27 Acer palmatum

- Information on this Tree Management Plan corresponds with Galbraith and Asscoiates Arborist Report dated 28th August 2018
- Tree protection fencing, or ground protection where required, provided in accordance with AS4910-2009. • Appropriate signage on any tree protection fencing prohibiting access, excavation, changes in soil levels, or any storage within the Tree Protection Zone in accordance with 454910-2009 unless with the prior written consent and under the direct supervision of the consulting arborist.
- Maintenance of the area(s) within the Tree Protection Zone in accordance with AS4970-2009.
- Any pruning to be undertaken being in accordance with AS4373-2007



4A-4B Canberra Road, Toorak - Plant Species

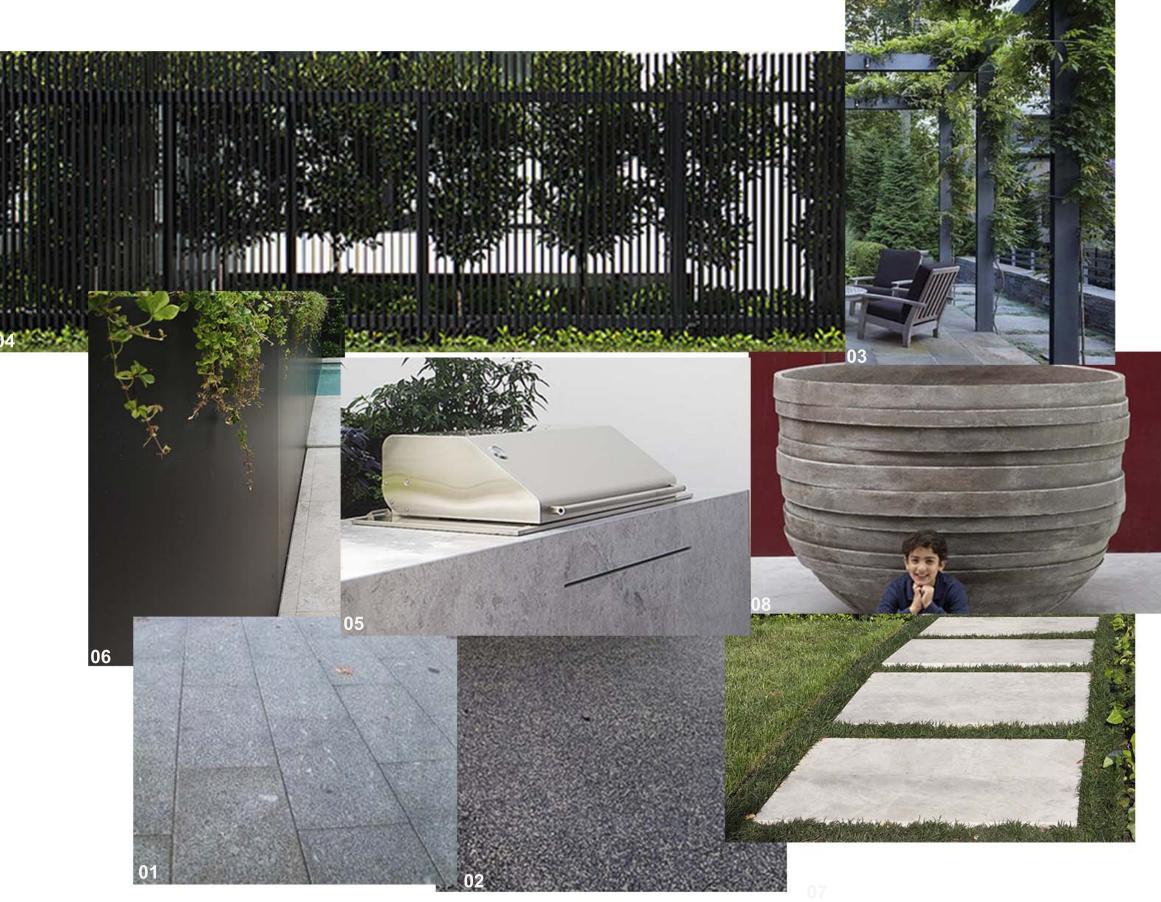

- 01. Flamed Charcoal Granite Paving
- 02. Charcoal Exposed Aggregate Concrete
- 03. Galvanised Steel Pergola
- 04. Metal Pallisade Fencing and Gate
- 05. Integrated Stainless Steel Barbecue
- 06. Metal-Clad Planter
- 07. Stepping Stone Bordered with Dwarf Mondo Grass
- 08. Atelier Vierkant 'UF140' Charcoal Pot



4A-4B Canberra Road, Toorak - Hard Landscape Elements