

6 Lomond Terrace MALVERN EAST VIC 3145

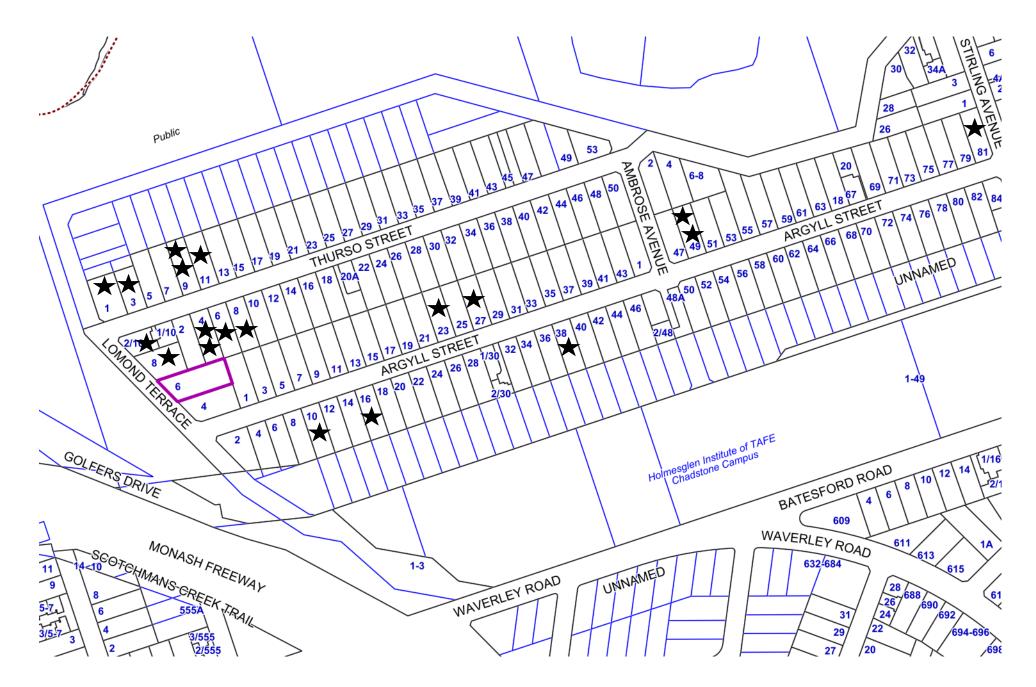

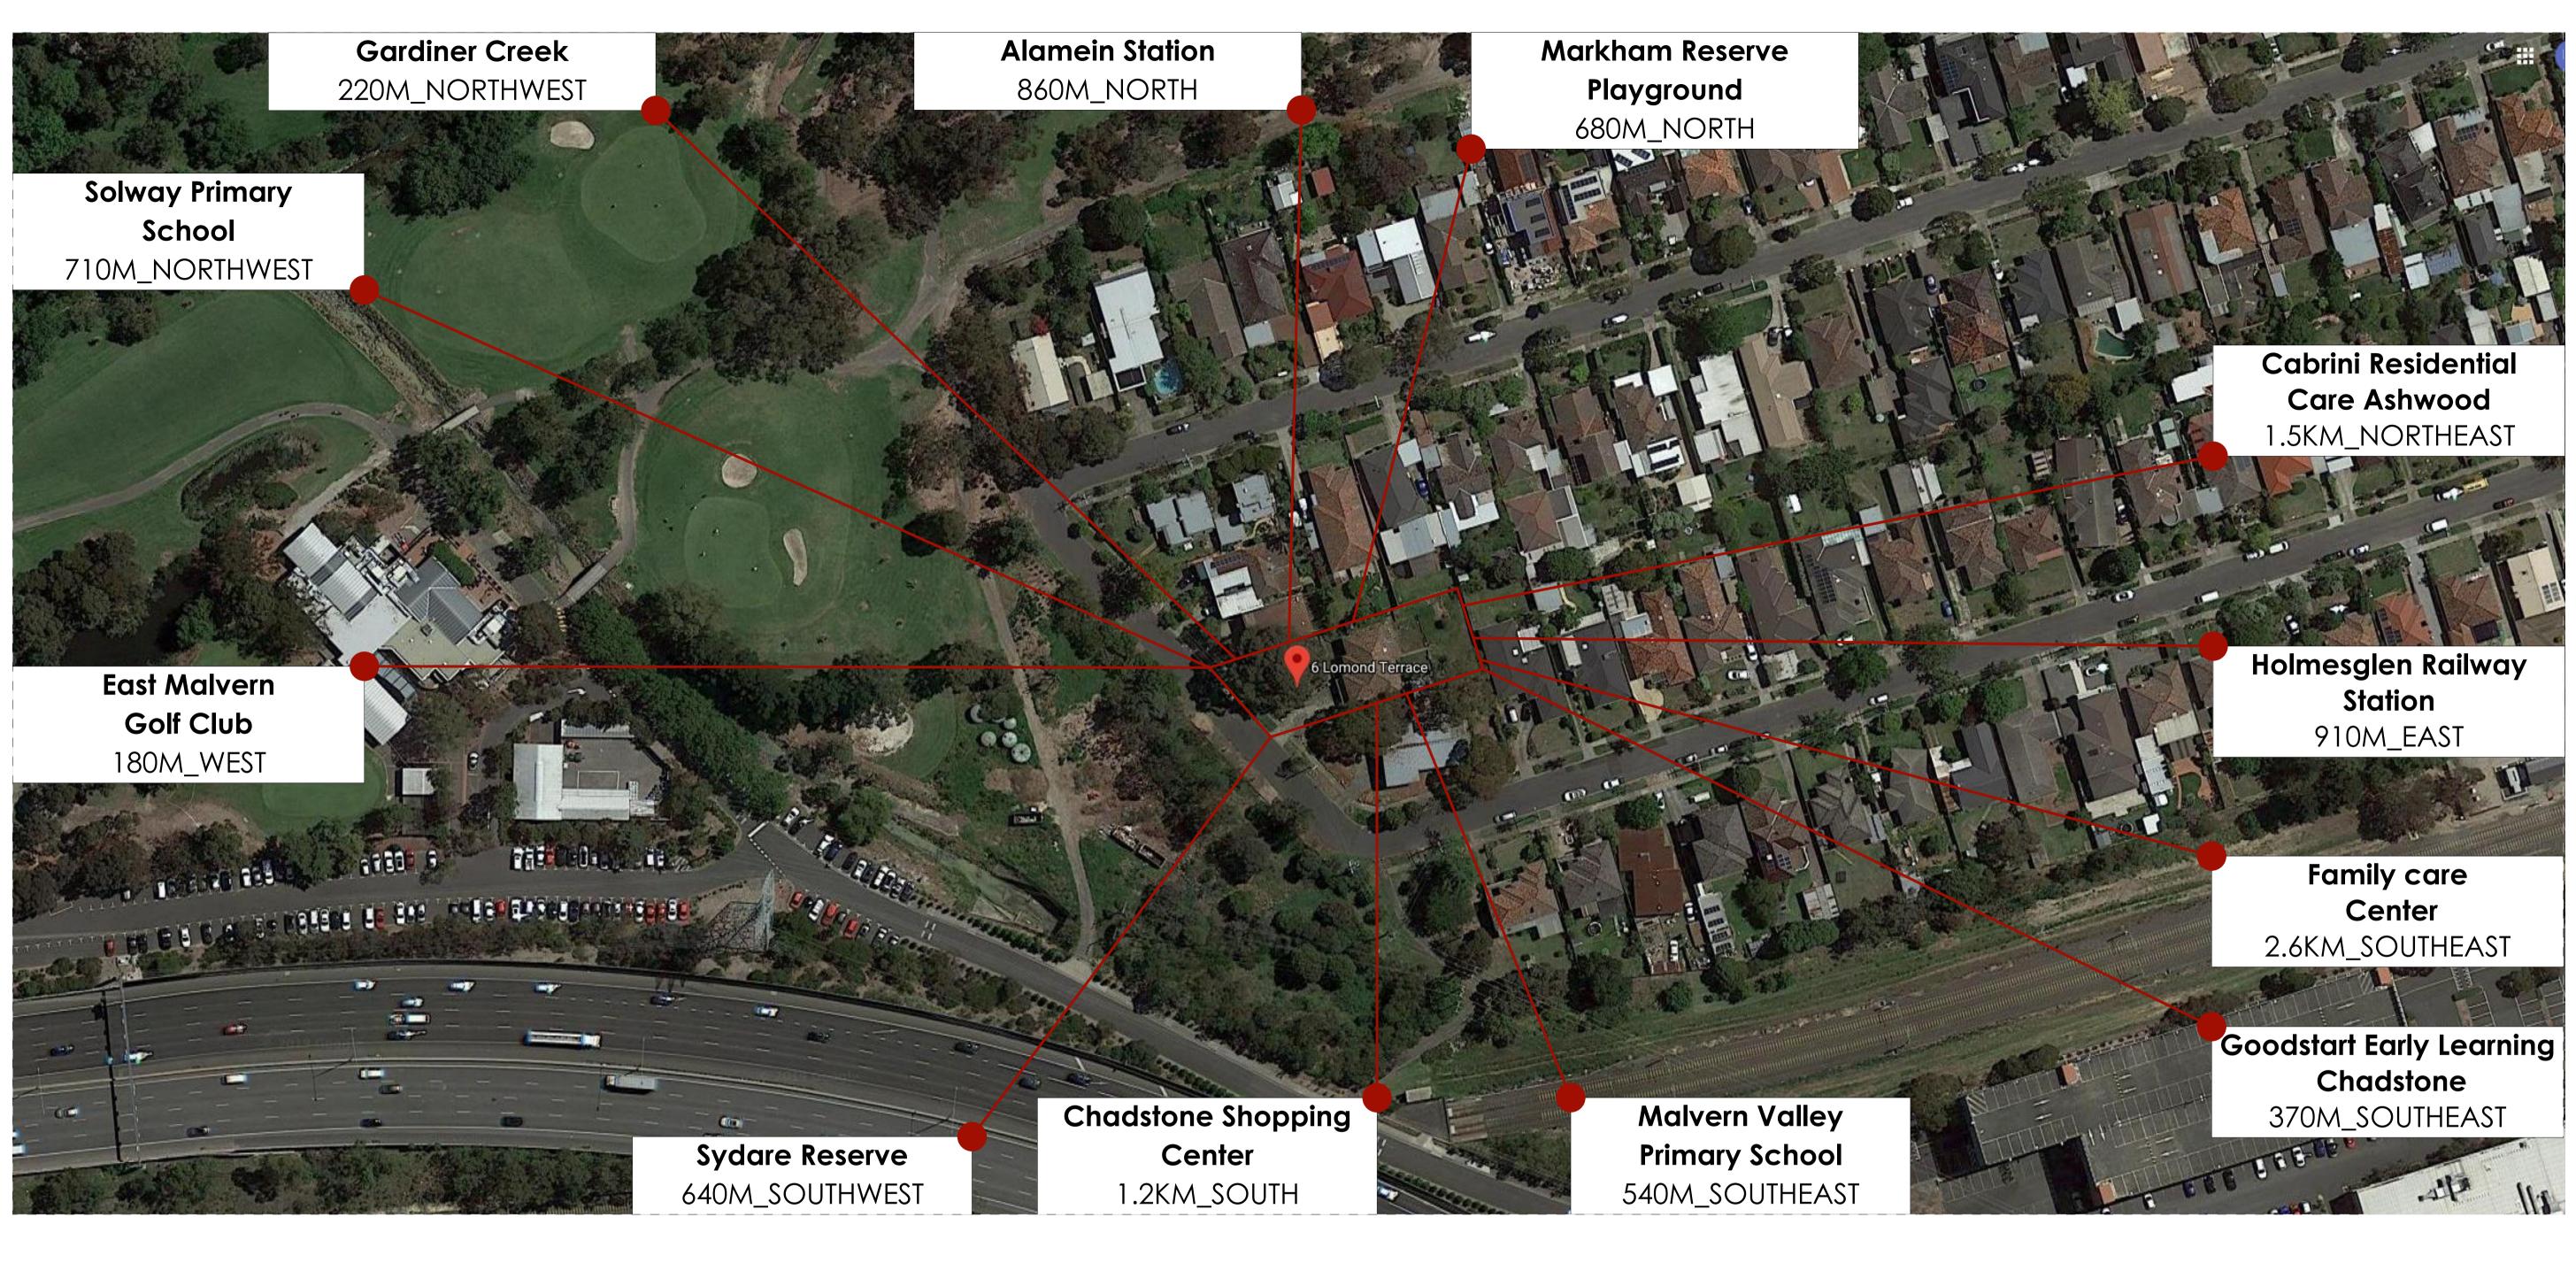



6 LOMOND TERRACE, MALVERN EAST, VIC, 3145

DRAWING NO.	REVISION	DRAWING TITLE
TP1	A	COVER SHEET
TP2	A	NEIGHBOURHOOD CHARACTER
TP3	A	SITE SURVEY & EXISTING CONDITION
TP4	A	DESIGN RESPONSE
TP5	A	GROUND FLOOR PLAN
TP6	A	FIRST FLOOR PLAN
TP7	А	ELEVATIONS
TP8	А	3D VIEWS
TP9	А	SHADOW DIAGRAMS & OVERLOOKING DIAGRAM


A TP LODEGMEN

Date

13/09/2019




Attl-415 Ferntree Gully Rd, Mount Waverley 3149 T: +61 3 9546 7078 F: +61 3 9546 7221 WWW west urban start

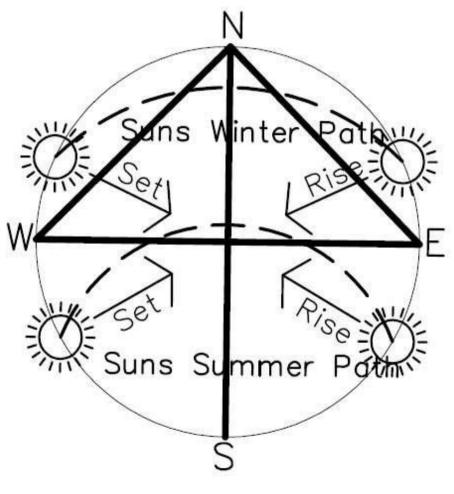



COVER SHEET

Drawing No

Project Location 6 LOMOND TERRACE MALVERN EAST VIC 3145

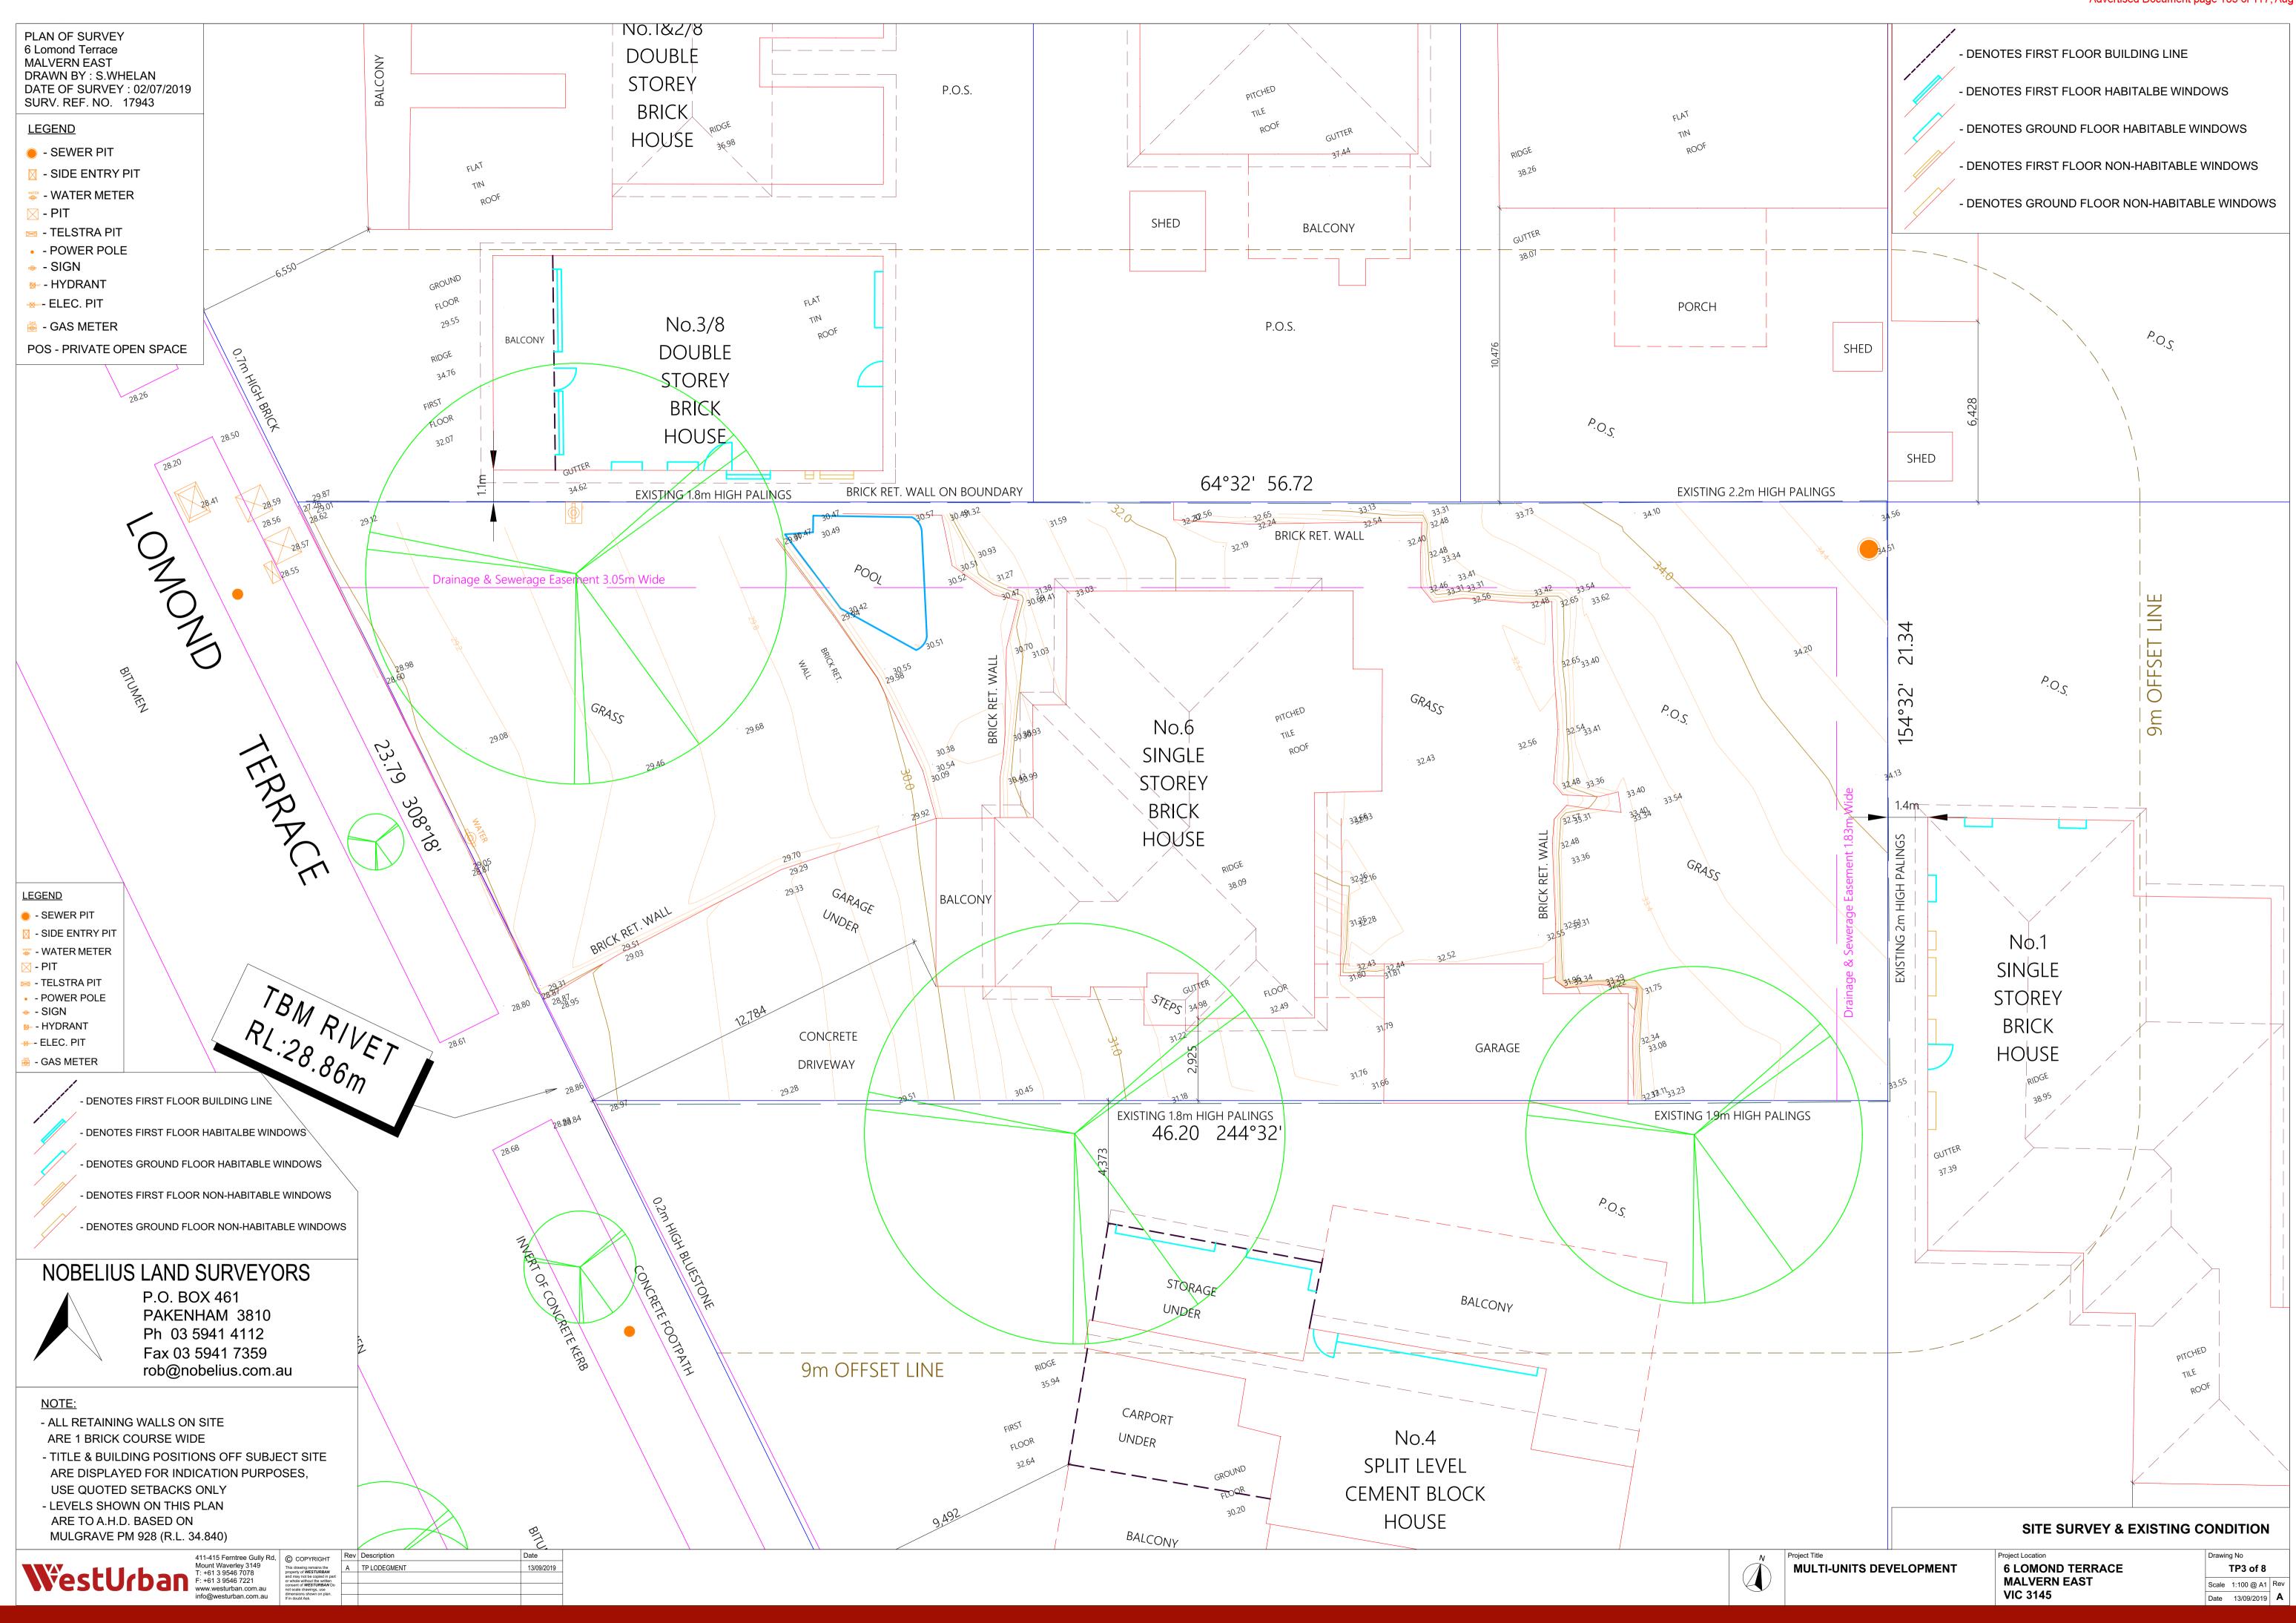


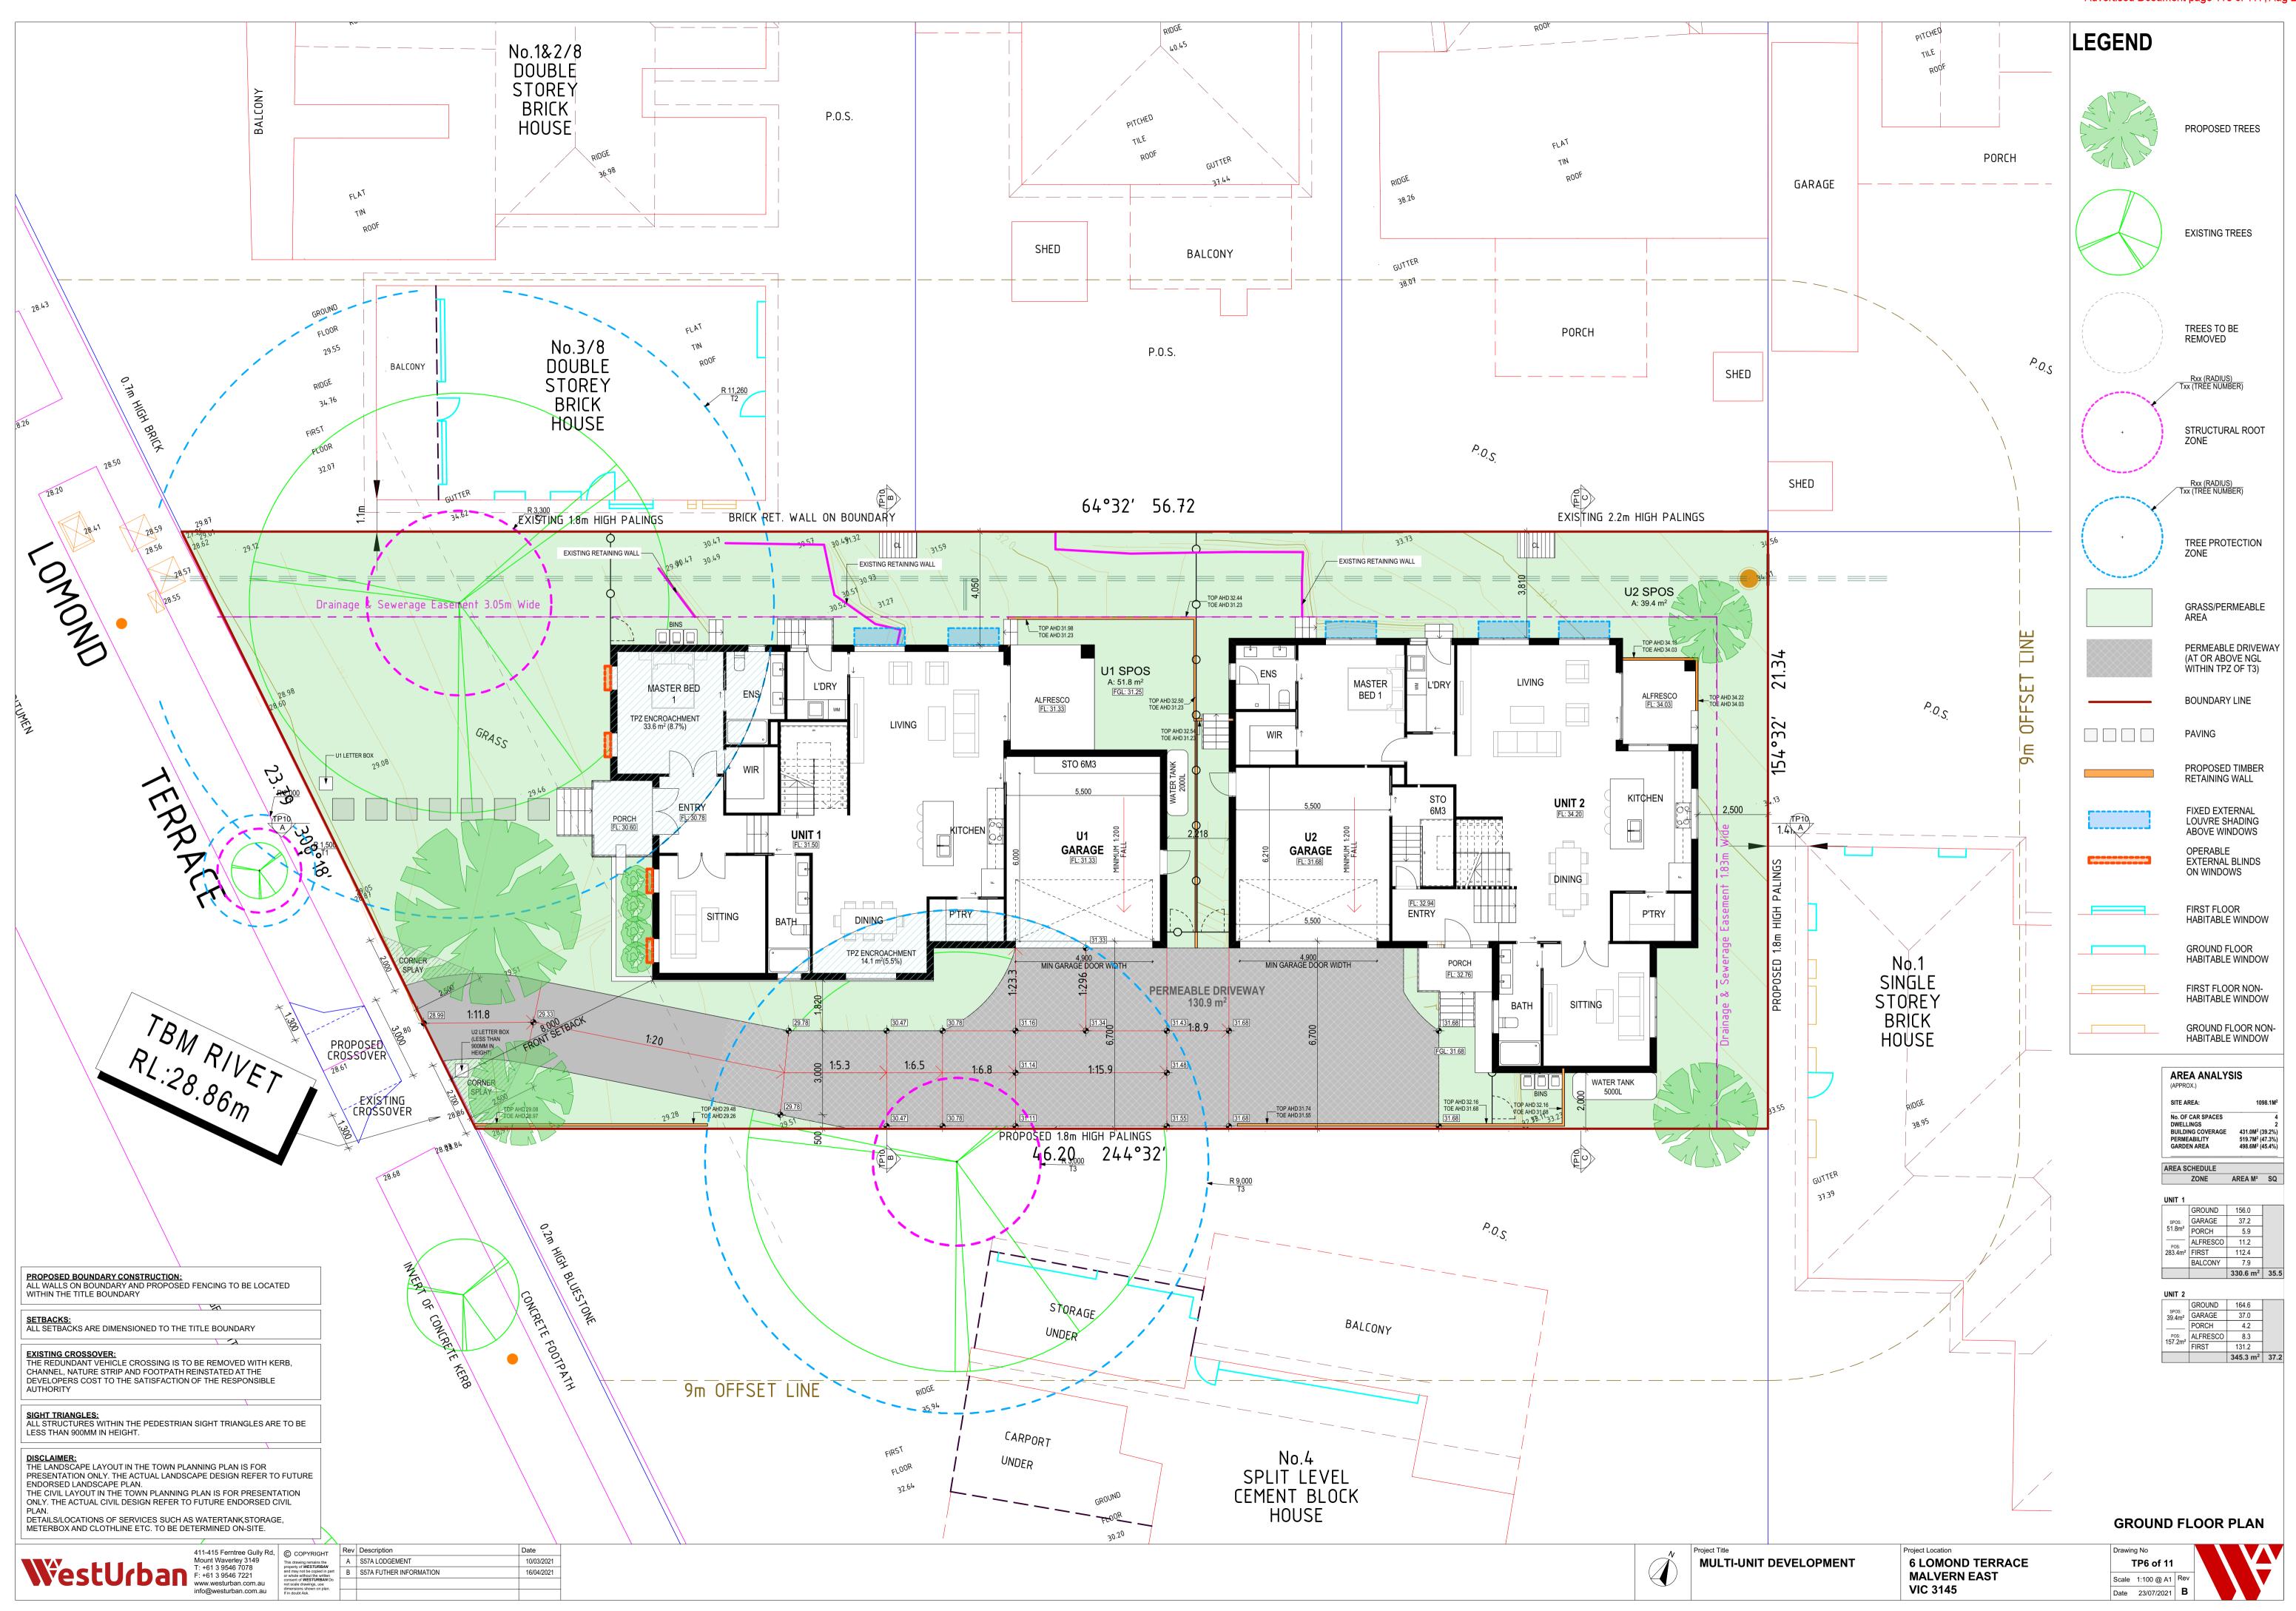

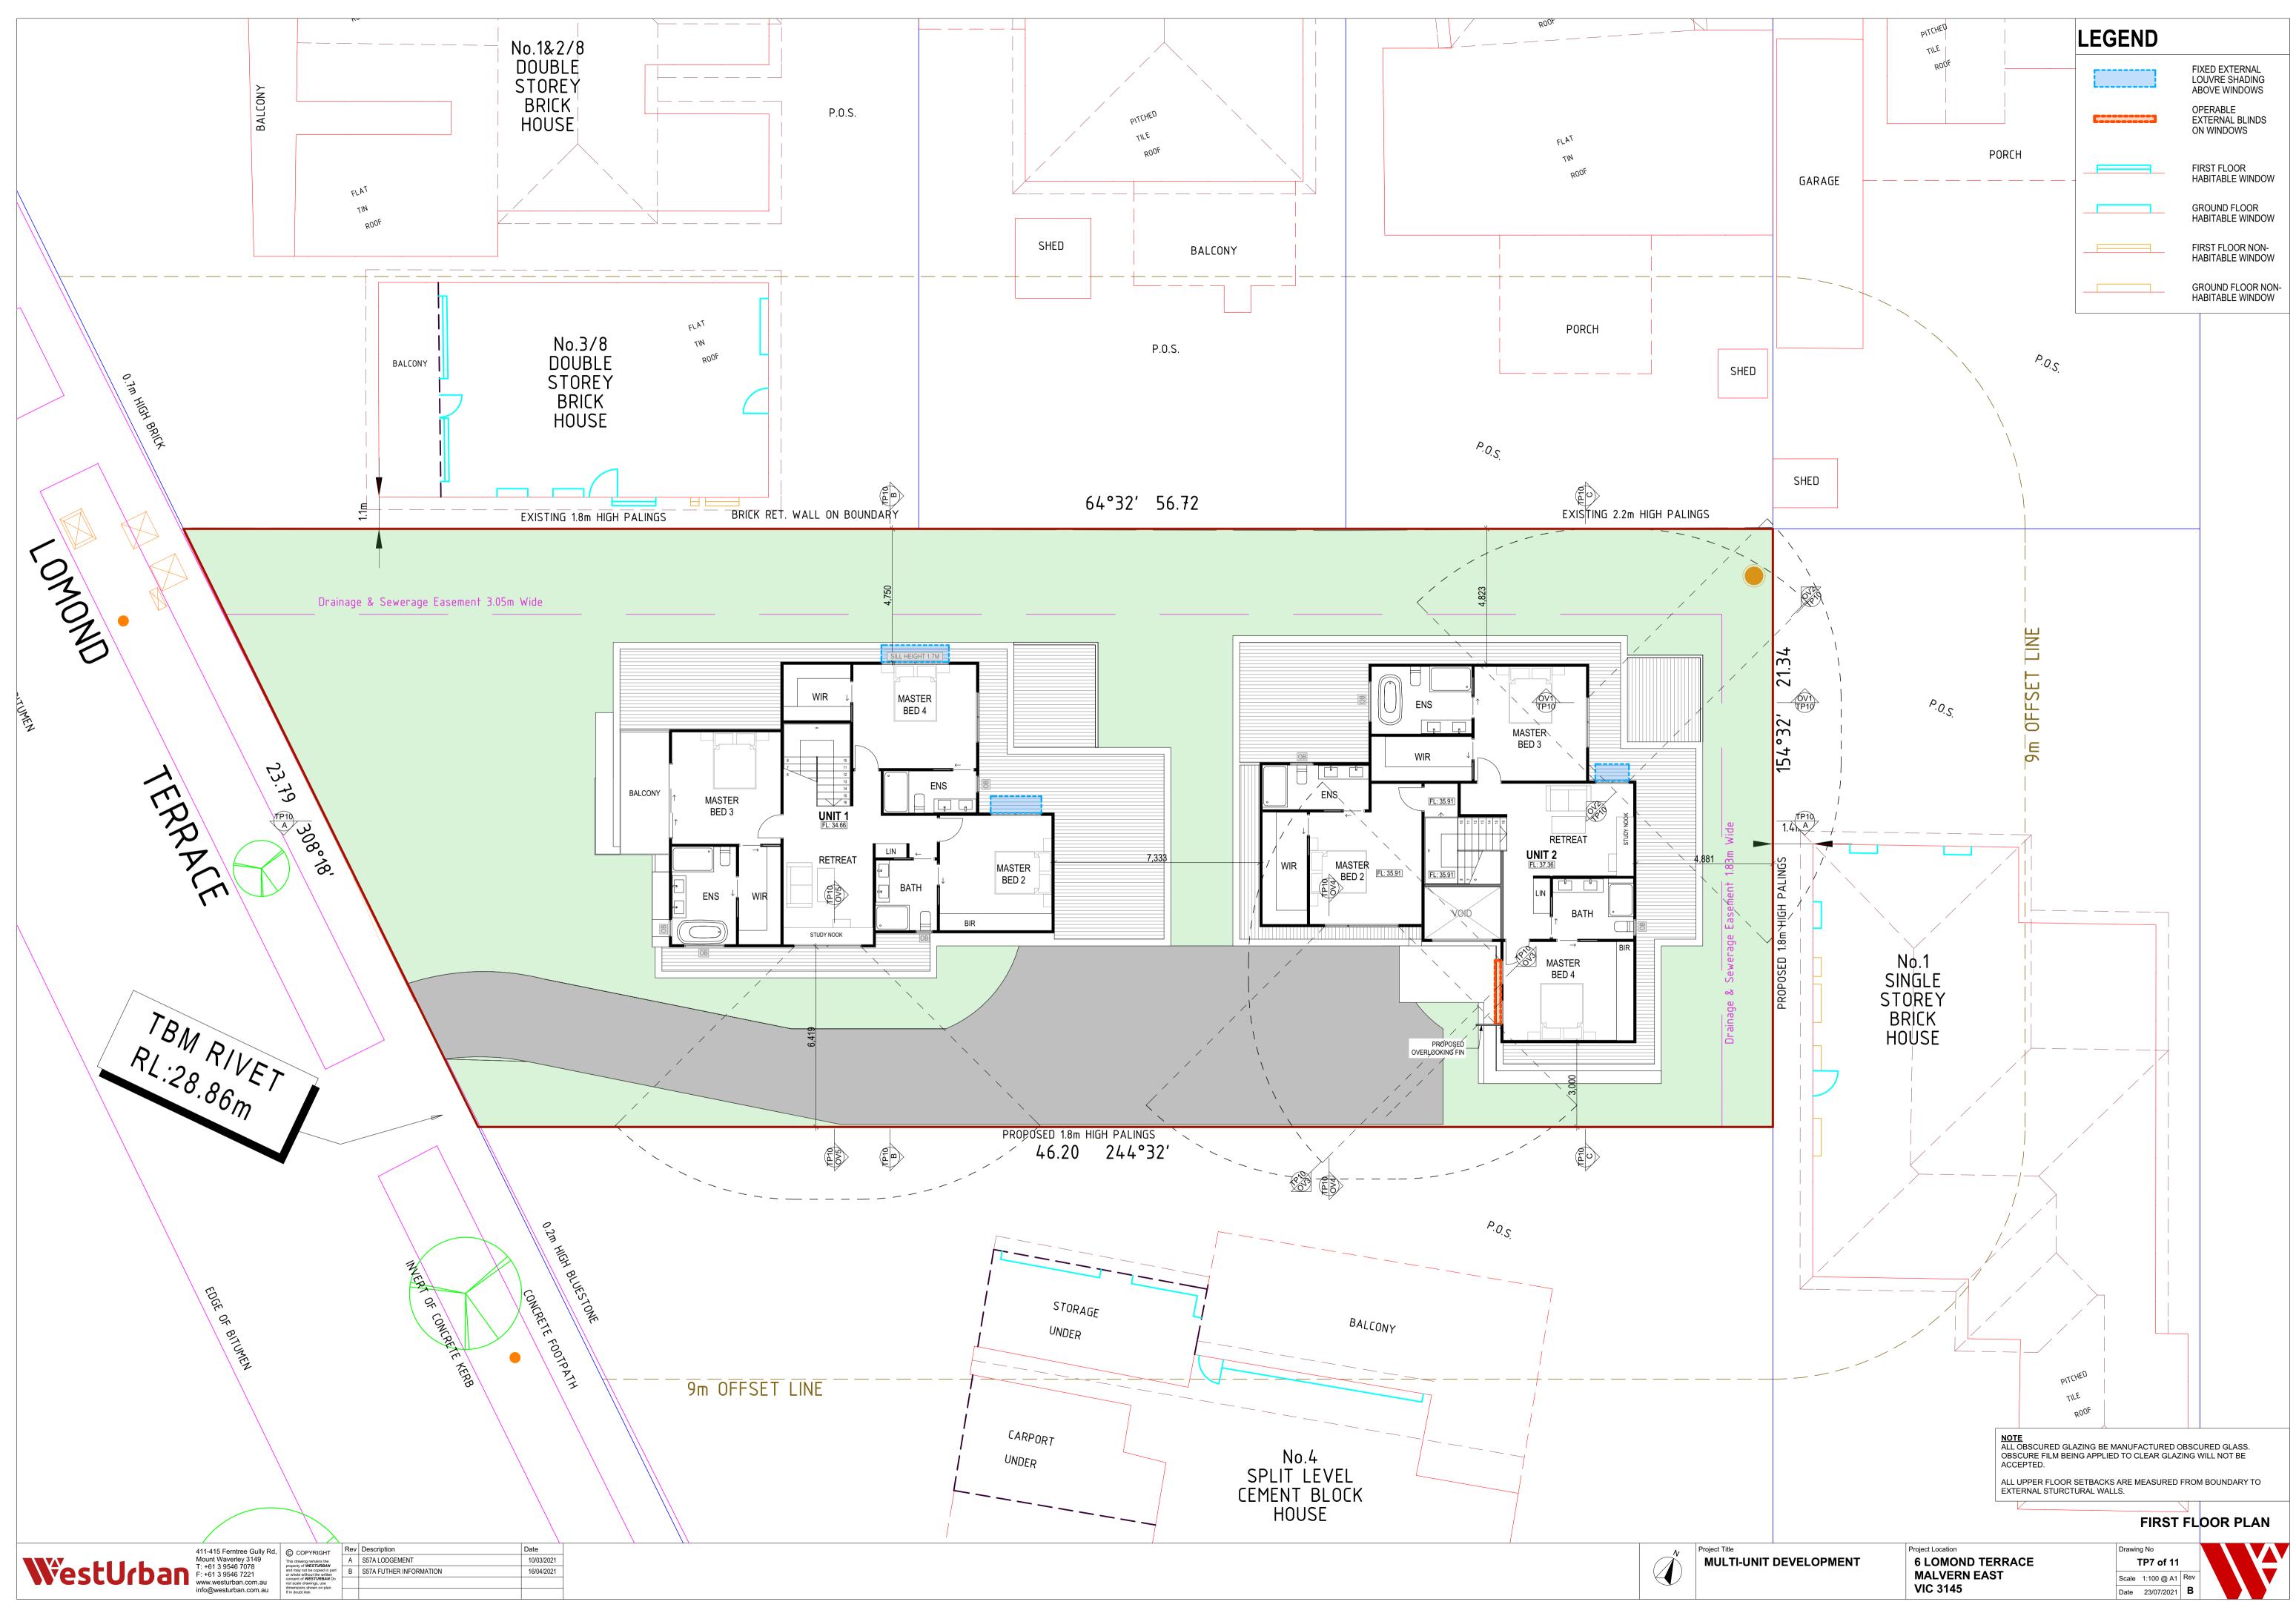

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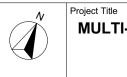


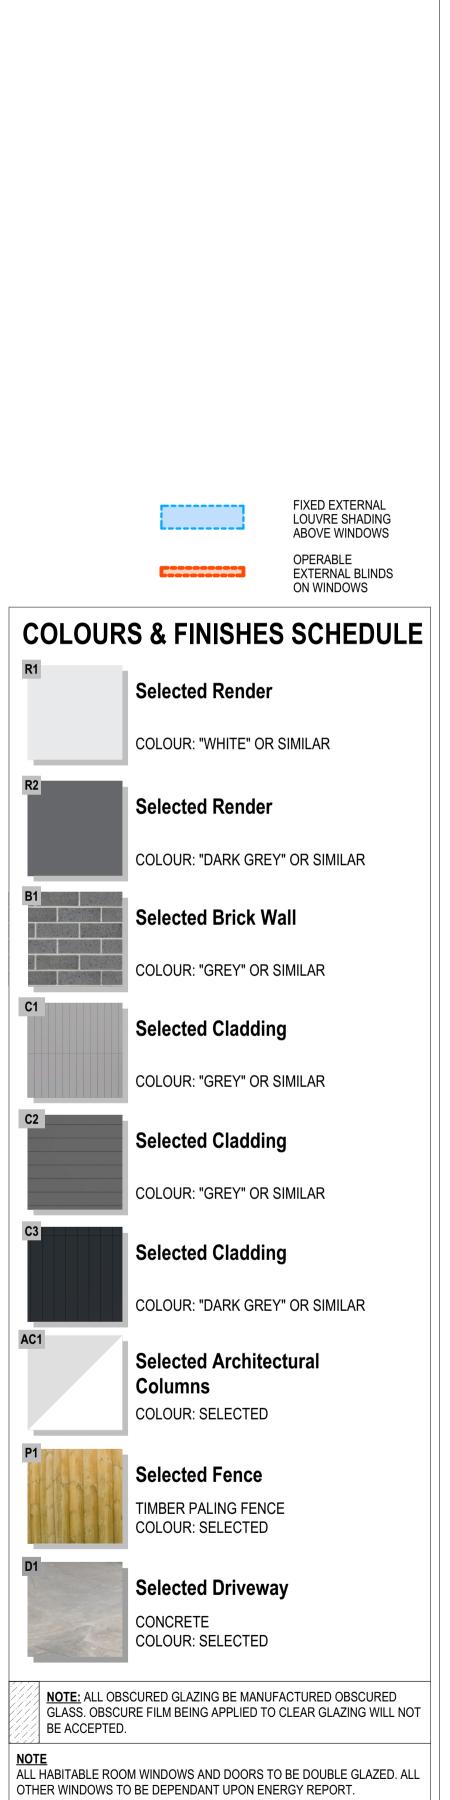


ELEVATIONS









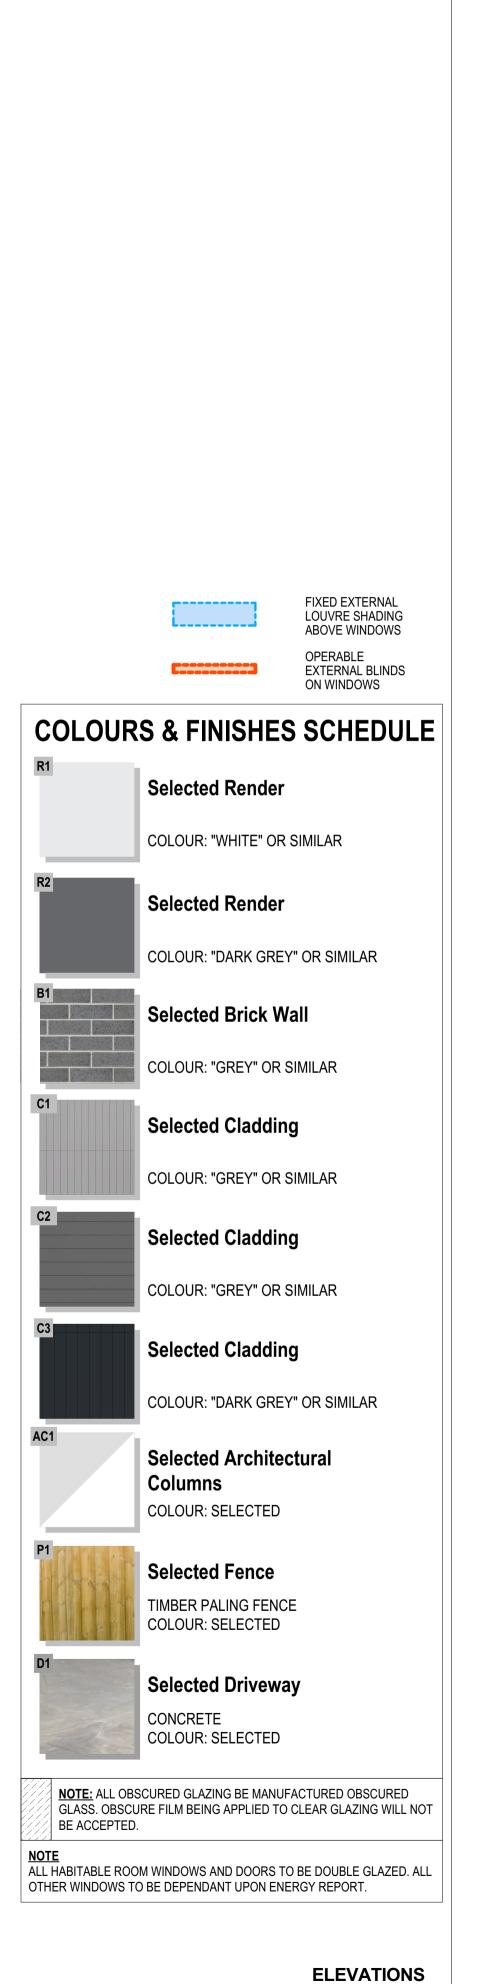



Project Location Drawing No MULTI-UNIT DEVELOPMENT 6 LOMOND TERRACE TP9 of 11 MALVERN EAST Scale 1:200, 1:100 Rev Date 23/07/2021 B VIC 3145

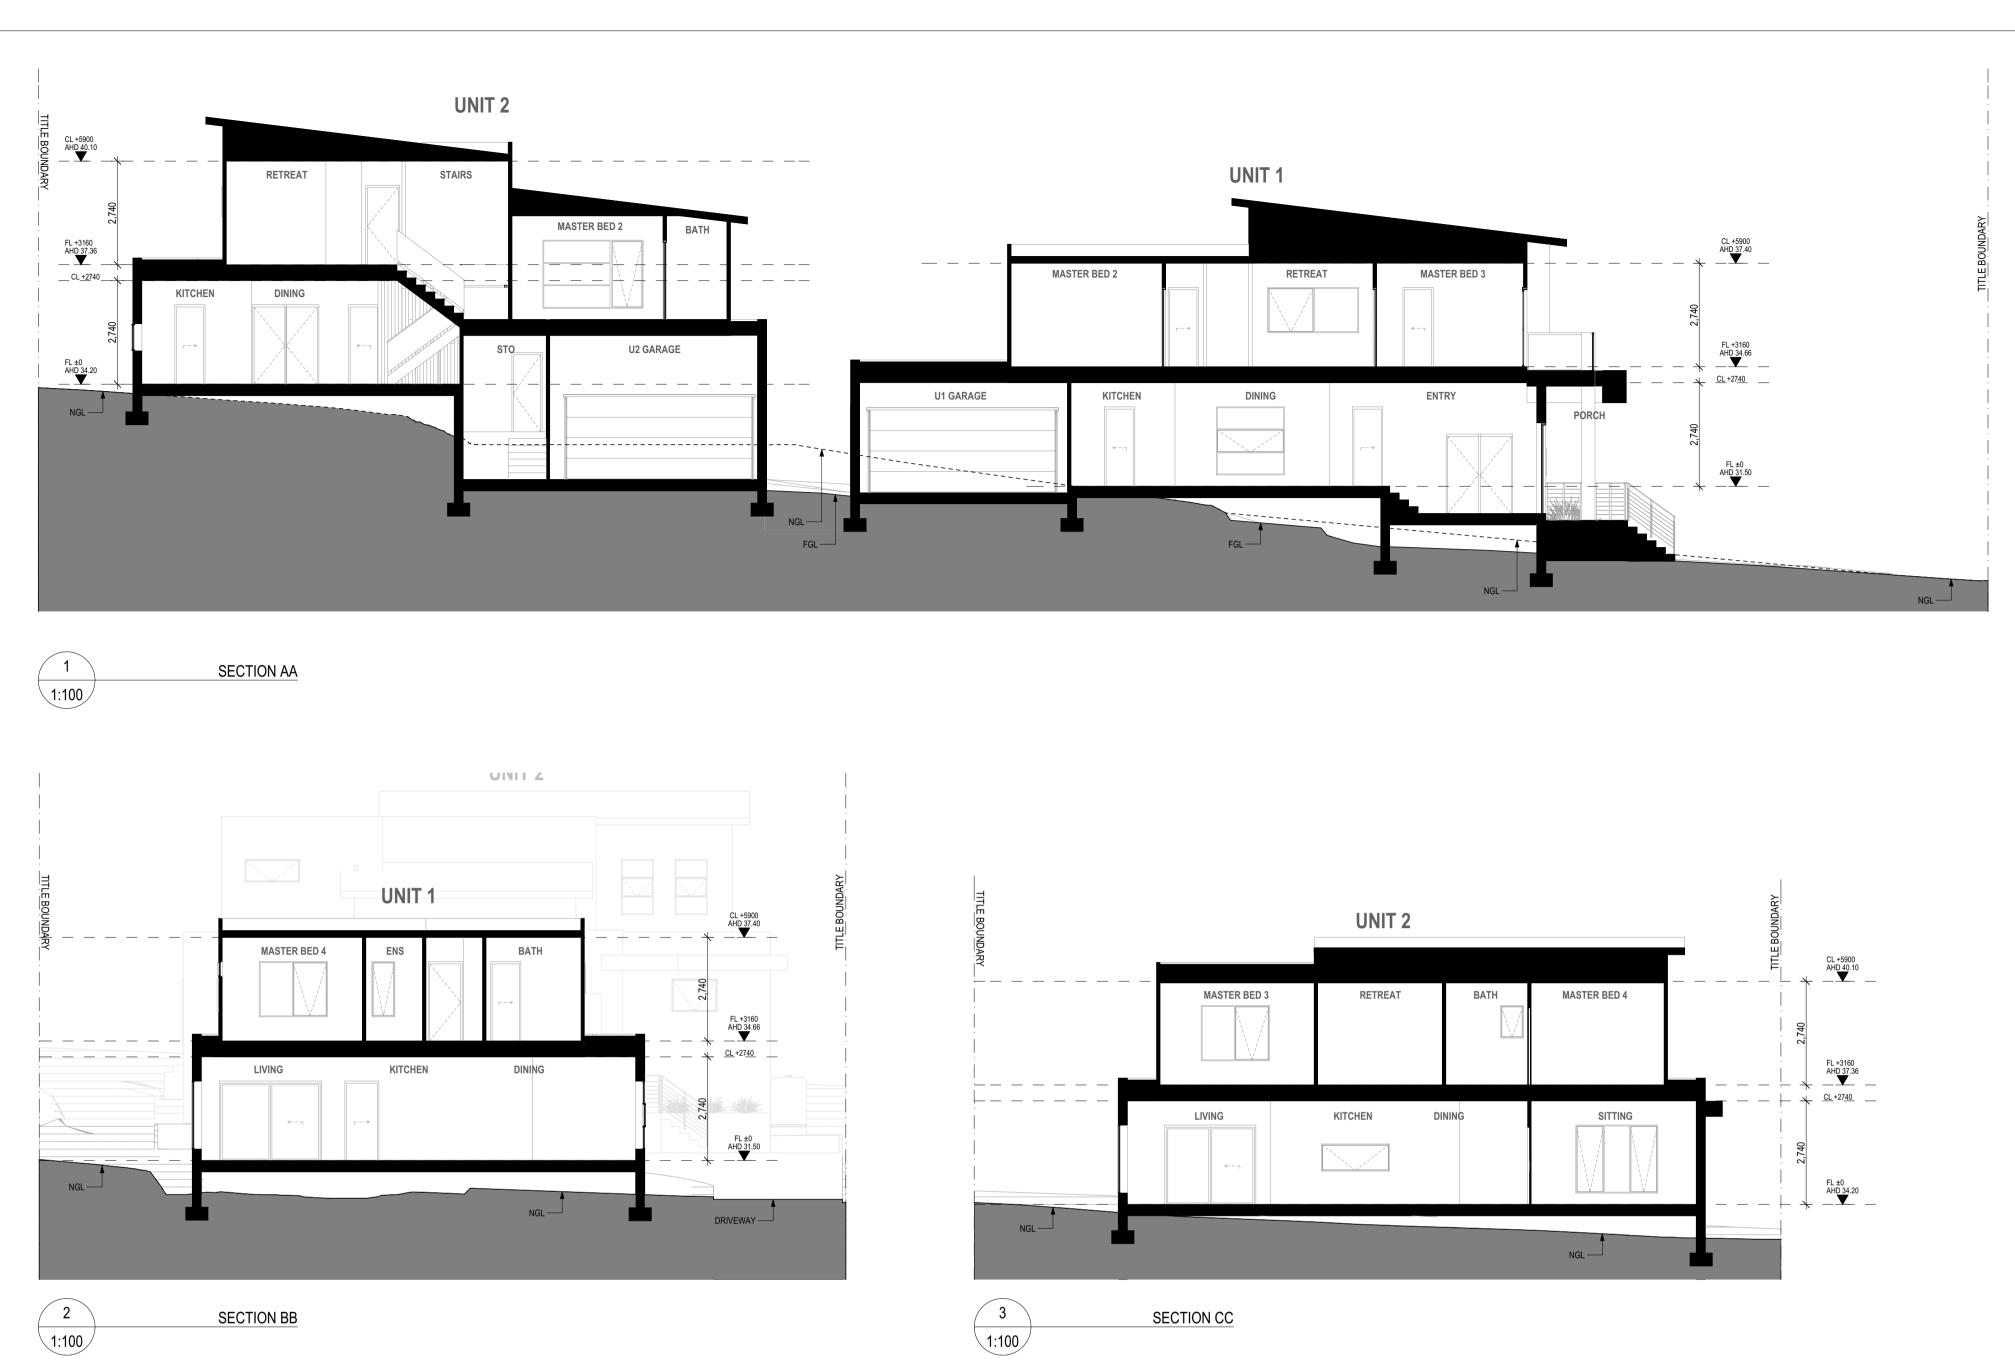

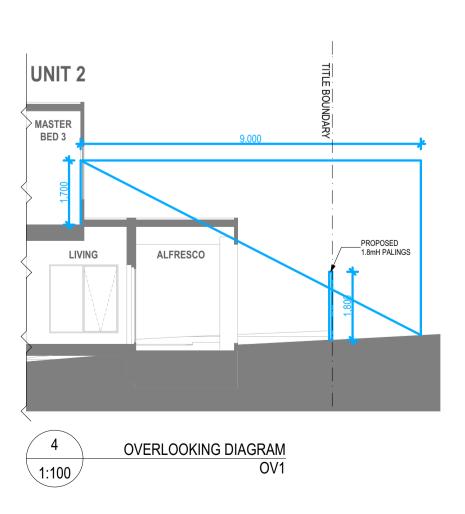


SECTION BB

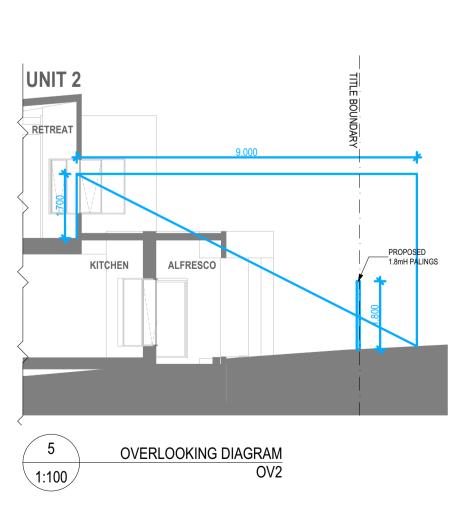

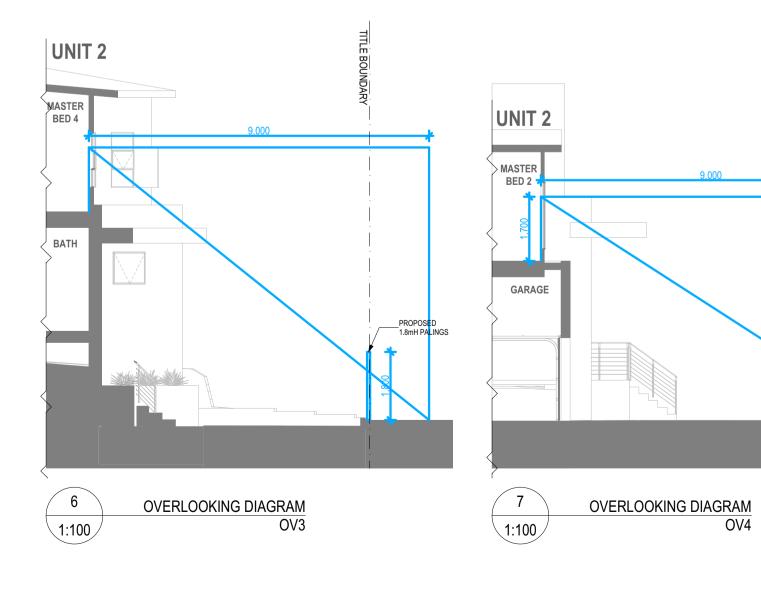


WestUrban	411-415 Ferntree Gully Rd,	C COPYRIGHT	Rev	Description	\sim	Date	3	
	Mount Waverley 3149 This drawing remains the	А	S57A LODGEMENT	-	10/03/2021	λ		
	T: +61 3 9546 7078 F: +61 3 9546 7221	property of WESTURBAN and may not be copied in part or whole without the written consent of WESTURBAN Do not scale drawings, use dimensions shown on plan.	В	S57A FUTHER INFORMATION		16/04/2021	2	
	www.westurban.com.au						1	
	info@westurban.com.au	If in doubt Ask.						

SECTION CC

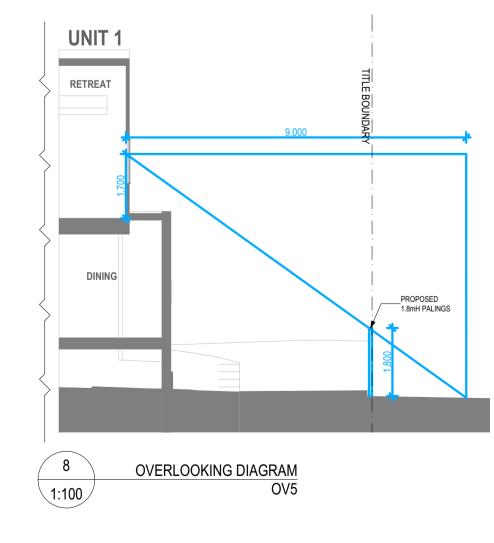

PROPOSED

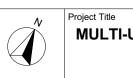


MULTI-UNIT DEVELOPMENT

Project Location 6 LOMOND TERRACE MALVERN EAST VIC 3145 Drawing No TP10 of 11
 Scale
 1:100 @ A1
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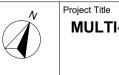
 Date
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SECTIONS







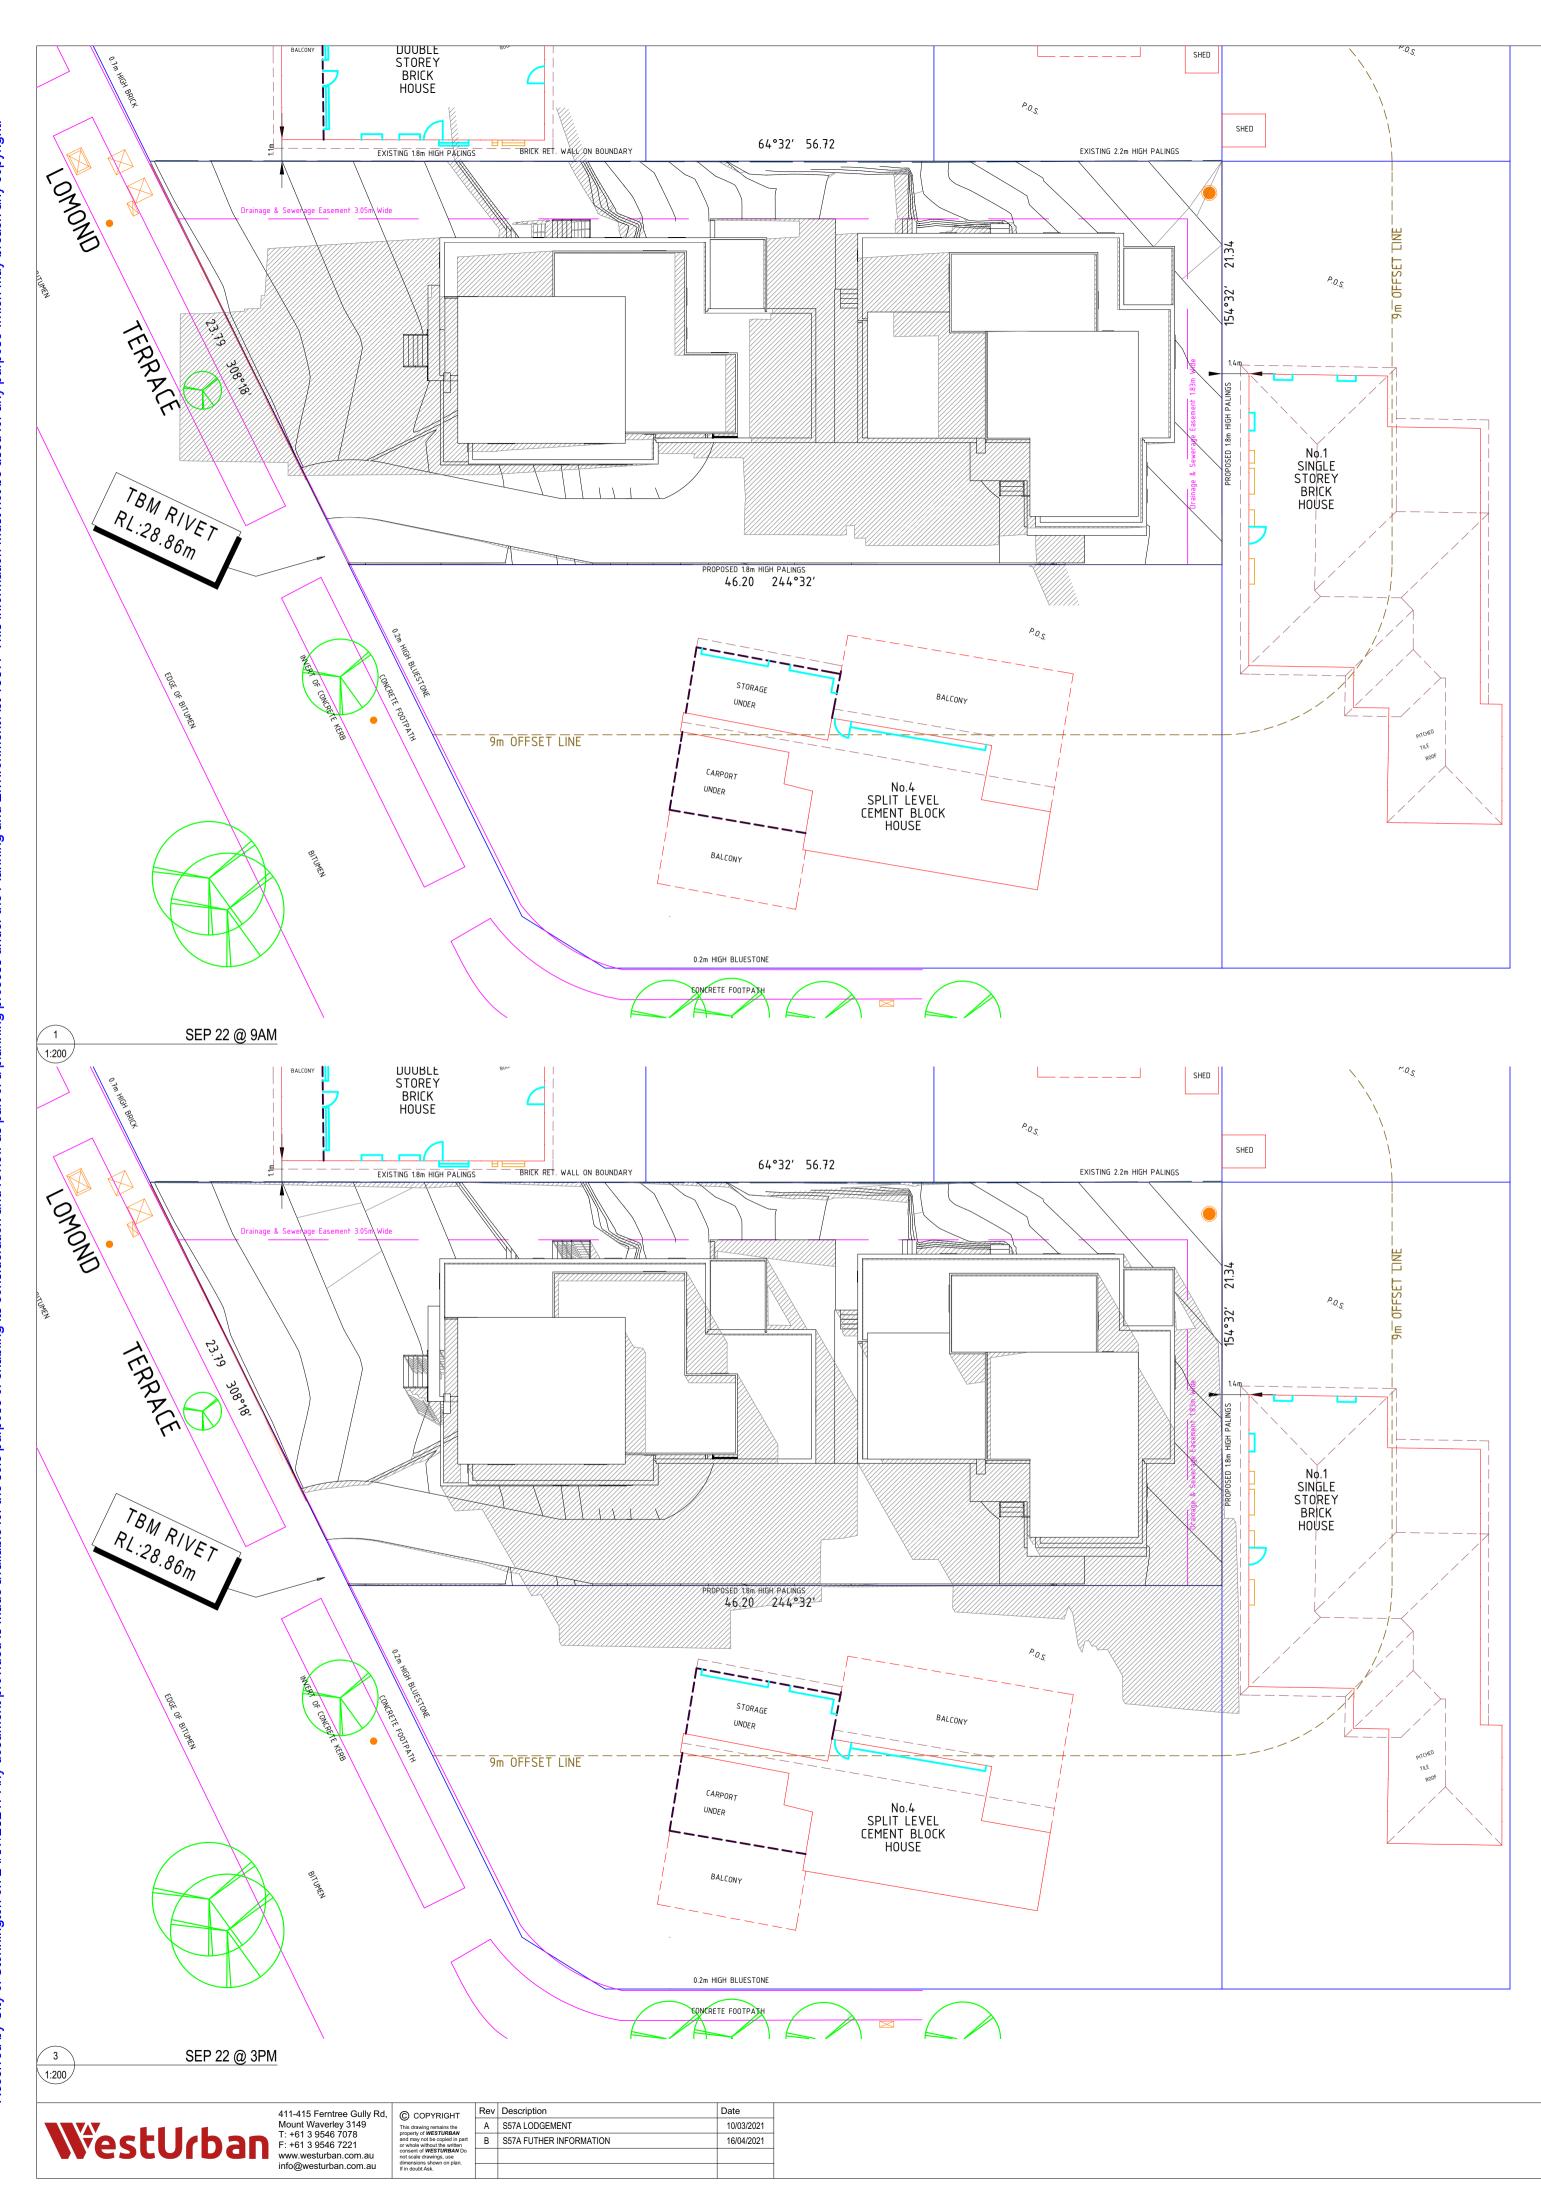

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Project Title MULTI-UNIT DEVELOPMENT

Project Location 6 LOMOND TERRACE MALVERN EAST VIC 3145

 Scale
 1:200 @ A1
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 Date
 23/07/2021
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SHADOW DIAGRAMS



Surface Finishes Detail

Garden Beds



Lawn areas

400mm APPROVED MEDIUM LOAM SOIL MIN 150mm DEEP ROTARY HOED SUBGRADE

75mm ORGANIC PINE BARK MULCH

Topping / Pebble Areas



STRATHAYR 'SIR WALTER SOFT LEAF BUFFALO' OR SIMILAR INSTANT LAWN 100MM APPROVED SANDY LOAM SOL

MIN 150mm DEEP ROTARY HOED SUBGRADE

Specifications

Subgrade preparation

Site preparation to be carried out in accordance with best horticultural practice and under suitable conditions. Disturbance to indigenous soil structure is to be minimised. The use of machinery that may damage soil structure or profile is not acceptable. Sub-grade to all lawn and planted areas is to be cultivated to a minimum depth of 150mm and shaped to achieve drainage falls prior to topsoiling. Subgrade to be tested prior to preparation and conditioning to determine ph, salinity and gypsum requirement. Any gypsum required is to to be distributed at the manufacturers recommended rate and cultivated into the sub-grade at a minimum depth of 150mm . Proposed

topping areas to be graded / drained to prevent water discharge into neighbouring properties Weed control

Remove and dispose of environmental weeds off site prior to subgrade preparation, topsoiling and planting works.

Soil Preparation

Topsoil is to be spread in maximum 150mm layers, lightly compacted by use of a 150 - 200kg roller, or by thoroughly walking until it accords with finished kerb levels or to within 75mm below edging levels to accommodate mulch. Imported topsoil for garden beds is to be medium texture general purpose garden soil and lightly compacted

- to minimum 300mm depth to garden beds. Soil is to comply with s.a.a. 2223-1978, and as follows:
- free from perennial weeds and their roots, bulbs and rhizomes free from building rubble and any other matter deleterious to plant growth
- ph to be 6.0 7.0 texture to be light to medium friable loam

free from silt material

Imported topsoil for lawn rejuvenation / establishment shall have the above characteristics, but shall be a free draining sandy loam lightly compacted to minimum 100mm depth

Mulch

The specified mulch for garden beds is to be an aged organic material with 60 - 80 percent of its volume being wood chips particles in a size range of 25 - 50 mm maximum. Mulch is to be spread at a consolidated depth of 75mm

Planting Procedure

If soil to planting hole is dry - fill with water and allow to drain completely. Tree roots are to be teased outwards if matted or circling occurs prior to backfilling. Place tree in centre of hole on firm soil to prevent sinking, ensuring top of the rootball is flush with the surrounding soil surface and the trunk is vertical. Backfill material is to be in a loose, friable state, with no bricks, rocks or foreign material - if sufficient material is not available form the original hole to backfill, a similar soil type must be sourced and used. Soil material must be firmly backfilled in layers to prevent large air pockets from occurring, then thoroughly watered in. Trees to be staked with two 2250mm x 70mm hardwood stakes driven firmly into the ground - stakes must not be placed through the rootball area. Trees are to be secured to each stake with a strong, soft and flexible material, tight enough to support the tree in windy conditions - yet loose enough to stimulate development of a good supportive root system. Tree tie material must not injure tree bark or restrict trunk growth for a minimum period of three years. Slow release fertiliser (3/6 month formulation) such as 'Osmocote' is to be applied to the top of the rootball area away from the trunk / stem to manufacturers specifications and watered in immediately. All trees to be mulched to a diameter of 1200mm wide and to a depth of 100mm but must not be in contact with the tree trunk. Mulch is to be an aged organic material with 60 - 80 percent of its volume being wood chip particles in a size ne of 25 - somm maximum. Mulch is to be spread at a conso dated depth of 75mm. The planting hole surface is to be shaped to minimise waterlogging/excessive water retention but retain the mulch material neatly. The site must be left in a clean and safe condition.

Plant Establishment Period

The landscape is to be maintained by applying best horticultural practice to promote healthy plant performance for a 13 week establishment period following the approval of Practical Completion by the responsible authority including (but not limited to) the following tasks - Pruning as necessary to maintain plants in a healthy and structurally sound manner, pest and diseases - vegetation to be pest and disease free, mulching, staking and tying - 75mm mulch depth to be maintained around tree bases throughout maintenance period, watering - as often as necessary to ensure healthy and vigorous growth in accordance with current local watering regulations, weeding - maintained in a weed free state over the entire mulch area by spraying or mechanical mean, fertilising - 3/6 x monthly slow release fertiliser in accordance with manufacturers recommended application rates, replacement of deceased, stolen or vandalised plants beyond repair or regrowth with the same species as specified in the plant schedule within the assigned maintenance period.

Irrigation

An in-ground automatic or manual drip (or spray where practical) irrigation system to be installed to all garden areas (and planter boxes if applicable) to be operated in accordance with current local watering regulations.

Timber Edging

Timber edging to be 75mm x 25mm treated pine secured to 300mm long treated pine stakes at nom. min 1000mm spacings with galvanised screws and installed to all junctions between garden beds, lawn and topping / pebble areas.

Drainage

Landscape and / or building contractor(s) are responsible for civil and hydraulic computations for landscape building works including, but not limited to surface and sub surface drainage for all landscape areas prior to commencement of works

General

It is the responsibility of the consulting engineer to specify building construction methods (for all existing and proposed built constructions on and off site) that are able to withstand disturbance from proposed trees and planting - whether directly from the tree/plant, or as a result of changes to the soil profile (i.e. soil movement as a result of changes in moisture levels). It is recommended that root control barriers be installed for any proposed trees located within 5metres of any proposed or existing (including neighbouring) building lines, retaining walls, rain gardens and any built constructions.

Plants - Quality of Trees and Shrubs

Trees and shrubs shall be healthy nursery stock free from insects, diseases and weeds. The specified plant heights, and pot sizes are minimums. if plant material is unavailable in these sizes, larger stock must be used. Plant substitution is not acceptable unless confirmed by the responsible authority in writing. The contractor is to supply and install semi mature trees which meet the following criteria: Have a minimum planted height to sizes as indicated in the plant schedule, have a minimum trunk calliper of 50mm at ground level, be undamaged and free of diseases and insect pests, not be root bound or have circling or girdling roots but have roots grown to the edge of - the container, should bear a single straight trunk, strong branching pattern, and full canopy, show healthy, vigorous growth.

Protection of Existing Trees

This plan is to be read in conjunction with the arboricultural report prepared by Psy Inv Pty Ltd (18/07/19).

All existing vegetation shown on the endorsed plan (subject site and neighbouring properties) to be retained must be suitably marked before any development (including demolition) commences on the land and that vegetation must not be removed, destroyed or lopped without the written consent of the responsible authority. Before the commencement of works (including demolition) start, tree protection barriers must be erected around trees (subject site and neighbouring properties) to form a defined tree protection zone during demolition and construction in accordance with tree protection measures as per AS 4970-2009 (Tree protection in development *sites*) and to the satisfaction of the responsible authority.

Any pruning that is required must be carried out by a trained and competent arborist with a thorough knowledge of tree physiology and pruning methods to carry out pruning to the Australian standard - AS 4373-2007 (Pruning of amenity trees). All tree protection practices must be adhered to in accordance with the arboricultural report and to the satisfaction of the responsible authority.




Advanced Tree Planting detail not drawn to scale - WIDTH OF PLANTING HOLE IS 3 X TIMES OPPOSING FLEXIBLE TIES LOOSELY AROUND TRUNK AND FASTENED TO STAKES DIAMETER OF ROOTBALL KEEP MULCH AWAY FROM TRUNK BASE TOP OF ROOTBALL FLUSH WITH 75MM MULCH LAYER SURROUNDING GARDEN LEVEL MARAN MANARAN GENTLY PACK BACKFILL USING WATER TO SETTLE SOIL AROUND ROOTBALL WALLS OF PLANTING HOLE TO BE RIPPED O ENABLE ROOT SUBGRADE EXTEND STAKES INTO UNDISTURBED SOIL-SOIL IS TO CONSIST OF WELL BLENDED EXISTING / ----SET ROOTBALL ON UNDISTURBE INDIGENOUS AND IMPORTED SOIL SOIL TO PREVENT SETTLING

Shrub Planting

detail not drawn to scale		WIDTH OF PLANTING HOLE IS 2 X TIMES DIAMETER OF ROOTBALL
TOP OF ROOTBALL FLUSH WITH		KEEP MULCH AWAY FROM SHRUB STEM
SURROUNDING SOIL LEVEL		75MM MULCH LAYER
an to a dia to a dia to a di		
GENTLY PACK BACKFILL USING WATER TO SETTLE SOIL AROUND ROOTBALL		WALLS OF PLANTING HOLE TO BE RIPPED TO ENABLE ROOTS TO PENETRATE SUBGRADE
SOIL IS TO CONSIST OF WELL BLENDED EXIS INDIGENOUS AND IMPORTED SOIL	TING /	SET ROOTBALL ON UNDISTURBED SOIL TO PREVENT SETTLING



Legend

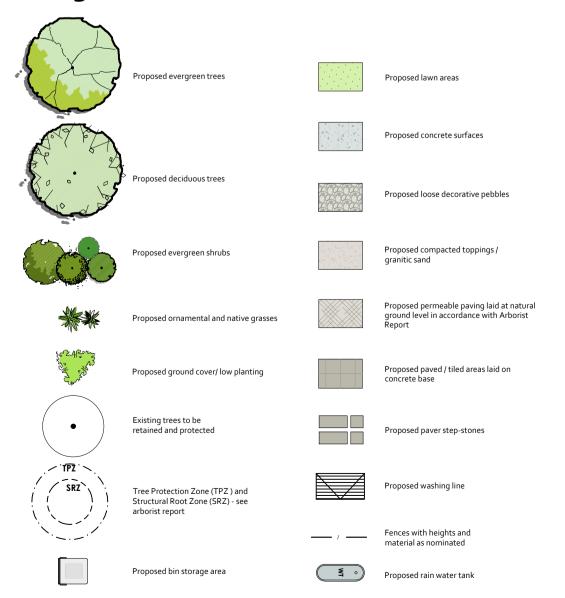

Existing Vegetation Summary

Tree No.	Botanical Name	al Name Common Name		HxW(m)
1	Tristaniopsis laurina	Kanooka	Retain	4 X 2
2	Corymbia maculata	Spotted Gum	Retain	30 X 24
3	Eucalyptus scoparia	Wallangarra White Gum	Retain	18 × 18
4	Eucalyptus botryoides	Southern Mahogony	Absent	

JUSTIN HUTCHISON PTY LTD Landscape Design | Horticultural Consultants E jhld@justinhutchison.com.au 84 Hotham Street Preston Vic 3072

P 03 8609 1780 W justinhutchison.com.au

DATE 23 04 21 SCALE 1:100 DRAWN BY J.H - D.AppSc (Hort) Burnley / Melb

PROJECT # 3023 REVISION # B

CLIENT LOMOND 6 PTY LTD

Proposed Planting Schedule

Code	Botanical Name	Common Name	Supply Size	Mature HxW(m)	Qty
TREES					
EY	Eucalyptus polyanthemos	Red Box	Min. 2m high	15 X 8	1
PF	Pyrus calleryana 'Fronzam Frontier'	Fronzam Pear	Min. 2m high	10 X 4	2
				TOTAL	3
LARGE SH	IRUBS				
ACS	Acmena smithii 'Cherry Surprise'	Lilly Pilly	20cm pot	3 X 1.5	5
AFA	Agonis flexuosa 'Jervis Bay After Dark'	Willow Myrtle	20cm pot	5 × 4	2
DP	<i>Dodonaea viscosa</i> subsp. purpurea	Purple Hop Bush	20cm pot	3 X 2	6
MGT	<i>Magnolia grandiflora</i> 'Teddy Bear'	Dwarf Magnolia	20cm pot	4 X 2	2
PL	Prunus lusitanica	Portuguese Laurel	20cm pot	3 X 2	5
MEDIUMS	SHRUBS				
ст	Choisya ternata	Mexican Orange Blossom	14cm pot	1.2 X 1.2	2
EW	<i>Euphorbia characias</i> subsp. wulfenii	Wulfen Spurge	14cm pot	1.2 X 1	12
GUL	Guichenotia ledifolia		14cm pot	1 X 1	21
RHO	Rhapiolepis indica 'Oriental Pearl'	Indian Hawthorn	14cm pot	.90 X 1	28
WFJ	<i>Westringia fruticosa</i> 'Jervis Gem'	Compact Coastal Rosemary	14cm pot	1 X 1	14
WFN	Westringia fruticosa 'Naringa'	Coastal Rosemary	14cm pot	2.2 X 1.2	57
GROUND	COVERS & LOW SHRUBS				
CRX	Correa reflexa 'Prostrate Green'	Prostrate Correa	14cm pot	.20 X 1	34
MYN	Myoporum parvifolium 'Yareena'	Creeping Boobialla	14cm pot	.10 X 1	16
тиѕѕоск	S / GRASSES / EVERGREEN PERENNIALS				
AT	Arthropodium cirrhatum 'Matapouri Bay'	Ranga Renga Lily	14cm pot	1.2 X 1	12
DRL	Dianella revoluta 'Little Rev'	Little Rev Flax Lily	14cm pot	.30 X .30	44
LM	Liriope muscari	Liriope	14cm pot	.75 × .75	12
LMJ	Liriope muscari 'Just Right'	Liriope	14cm pot	.50 X .50	21
LLT	Lomandra 'Lime Tuff'	Lomandra	14cm pot	.50 X .50	136

PROJECT PROPOSED DUAL OCCUPANCY DEVELOPMENT 6 LOMOND TERRACE MALVERN EAST

