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DRAWING REGISTER


No.	Revision	<u>Name</u>	<u>Scale</u>
PA-000	#	Drawing Register	N.T.S
PA-100	#	Existing Site Plan/Site Analysis	1:100 @ A1, 1:200 @ A3
PA-101	#	New Site Plan/Design Response	1:100 @ A1, 1:200 @ A3
PA-102	#	Landscape Plan	1:100 @ A1, 1:200 @ A3
PA-103	#	Landscape Specification and Detail	
PA-200	1	Basement Floor Plan	1:100 @ A1, 1:200 @ A3
PA-201	2	Ground Floor Plan	1:100 @ A1, 1:200 @ A3
PA-202	2	First Floor Plan	1:100 @ A1, 1:200 @ A3
PA-203	1	Second Floor Plan	1:100 @ A1, 1:200 @ A3
PA-204	#	Roof Plan	1:100 @ A1, 1:200 @ A3
PA-205	#	Shadow Diagrams	1:200 @ A1, 1:400 @ A3
PA-206	#	Shadow Diagrams	1:200 @ A1, 1:400 @ A3
PA-207	1	Shadow Diagrams	1:200 @ A1, 1:400 @ A3
PA-400	#	Proposed West Elevation	1:100 @ A1, 1:200 @ A3
PA-401	1	Proposed East Elevation	1:100 @ A1, 1:200 @ A3
PA-402	2	Proposed North Elevation	1:100 @ A1, 1:200 @ A3
PA-403	1	Proposed South Elevation	1:100 @ A1, 1:200 @ A3
PA-500	#	Section A-A	1:100 @ A1, 1:200 @ A3
PA-501	#	Section B-B	1:100 @ A1, 1:200 @ A3
PA-900	1	Material Schedule	N.T.S

REV 2

-Bathrooms adjusted to have 820MM openings as per design option B
-All bedrooms adjusted to have 850MM openings as per standard B41

-Storage calculations have been added -Apartment 9 balcony has been amended to achieve 13.5m²

-Apartment 5 balcony increased to 2M width as per standard B43

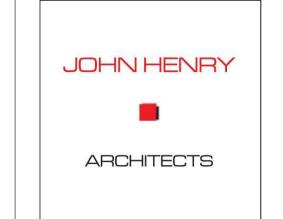


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03/03/2021 22/03/2021 27/04/2021	
27/04/2021	
7/05/2021	

No.	Description	Date

ect Title	Drawing Title			
405 Dandenong Road //alvern East		g Regis	ter	
	Print Date	7/05/2021	Page No.	Revision
	Project Date	23/04/2018	PA-000	2
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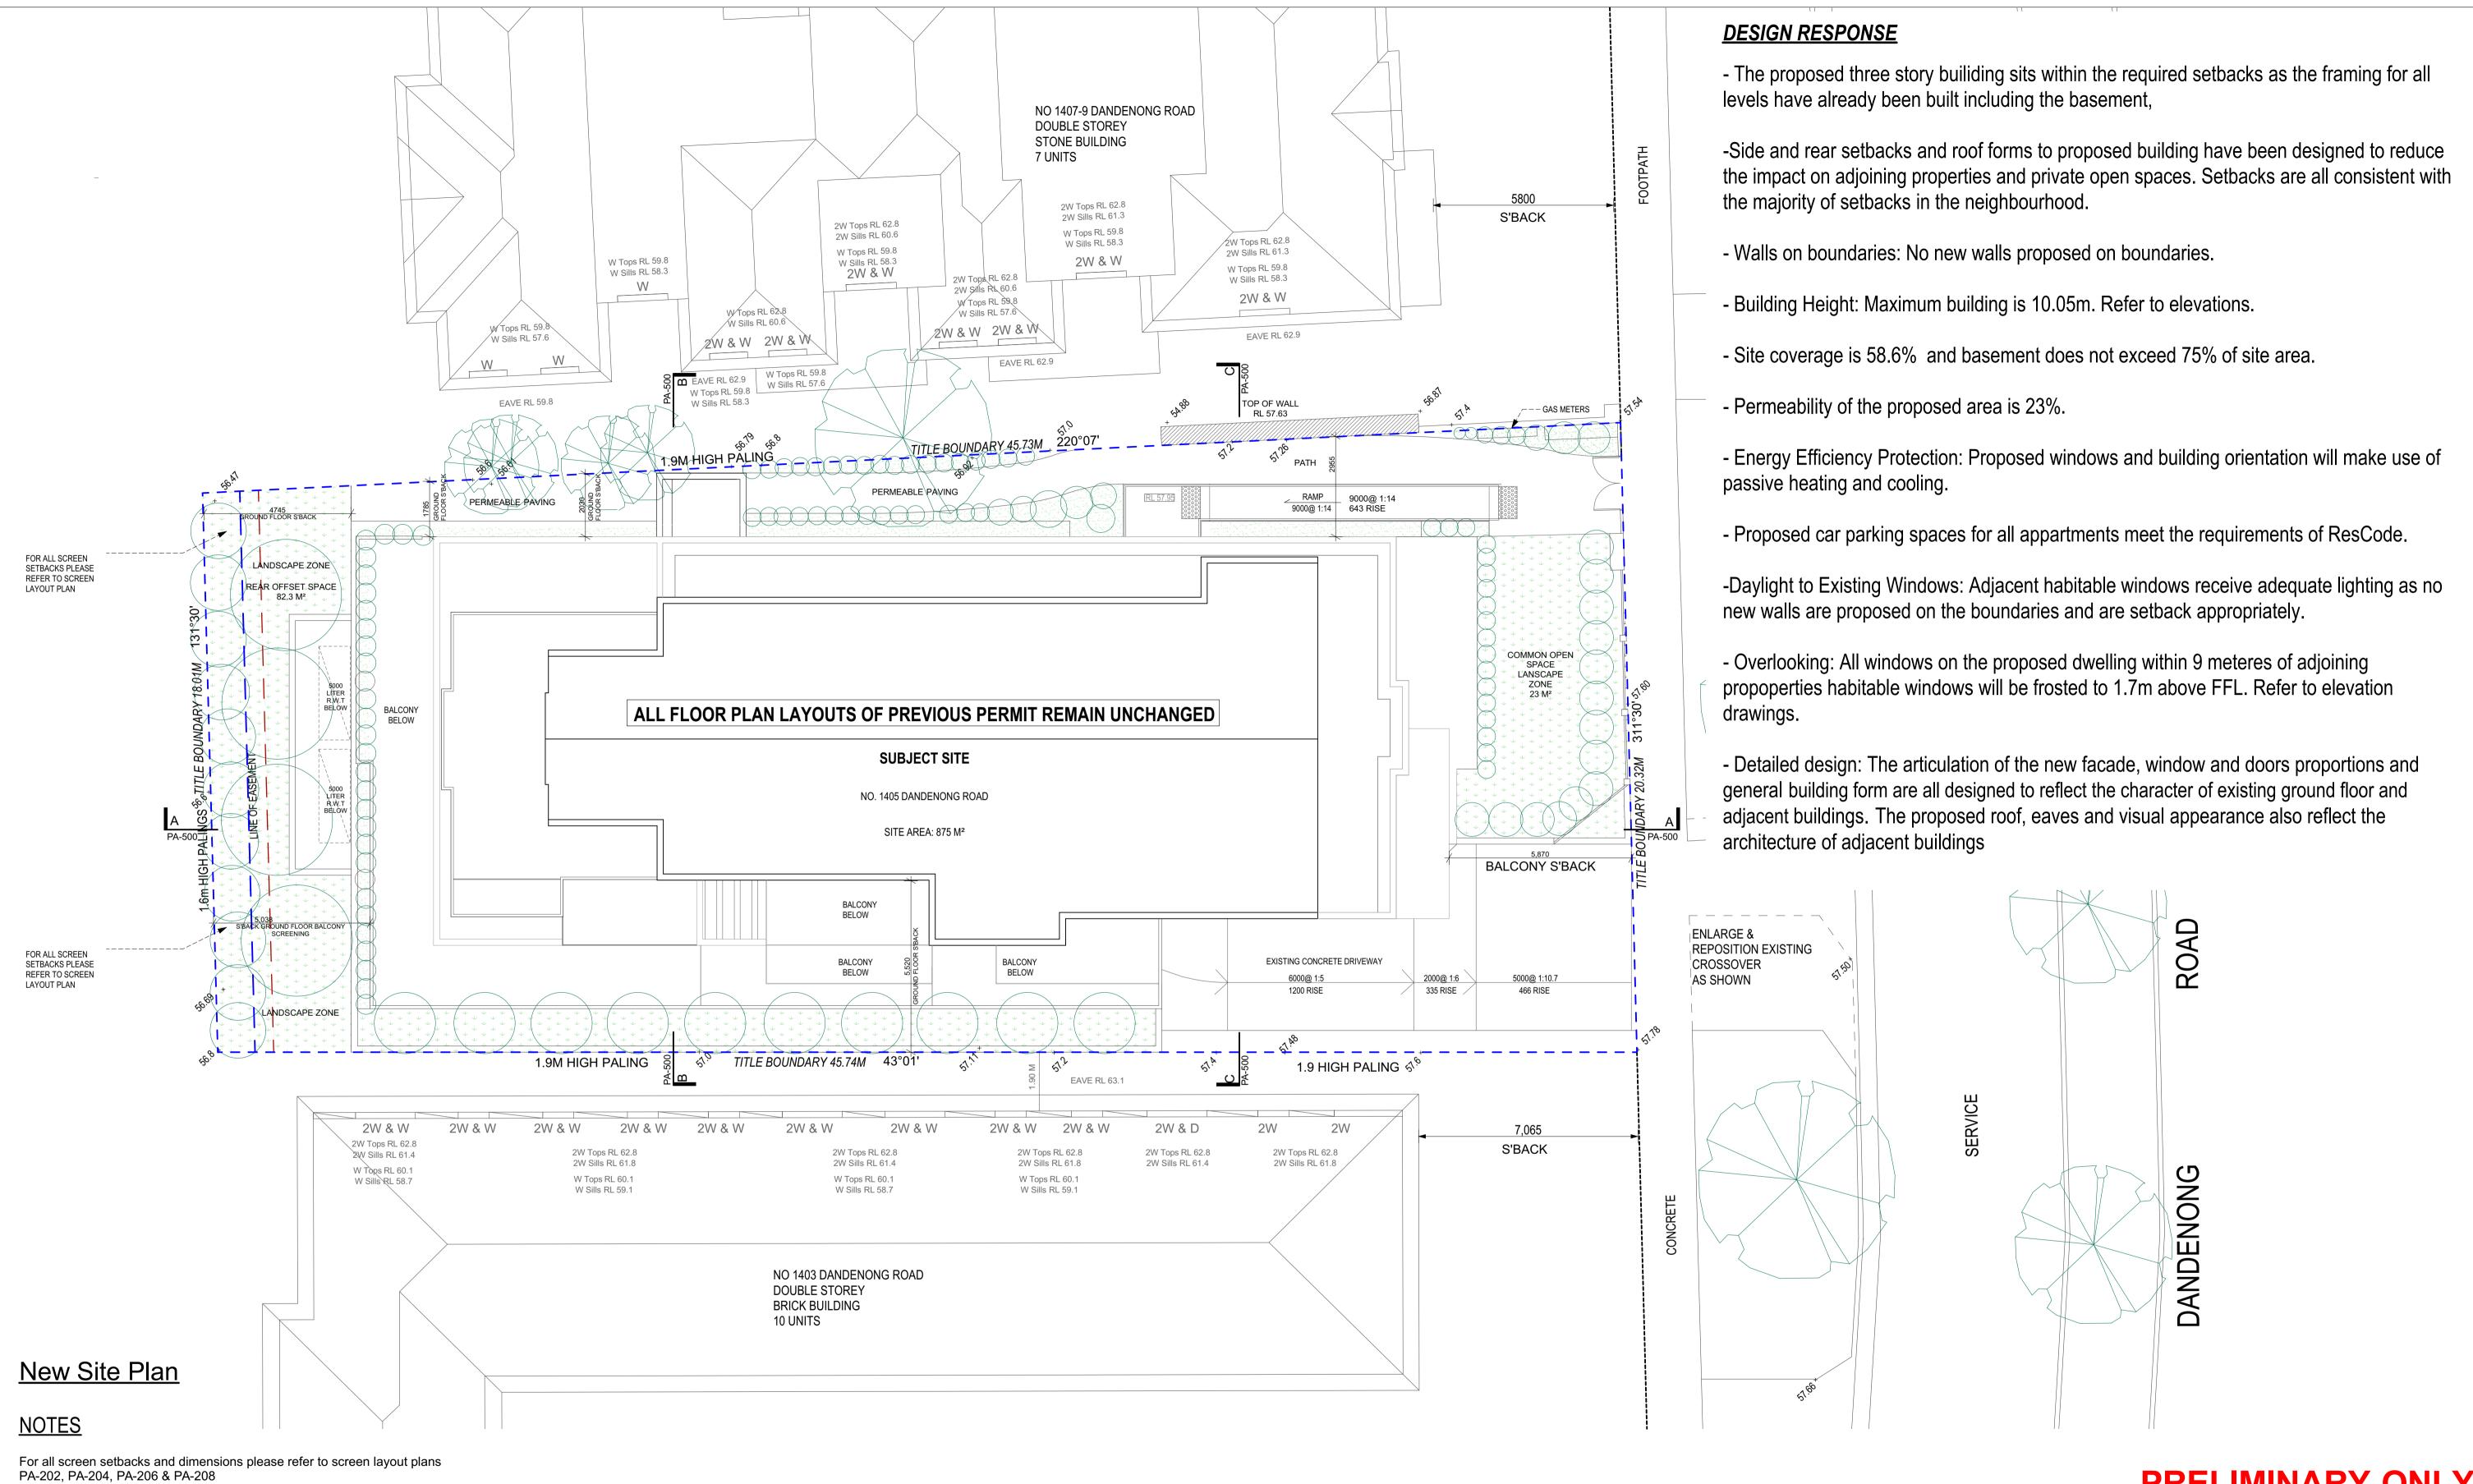
No.	Description	Date
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No.	Description	Date

1405 Dandenong Road Malvern East

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ng Title			
kisting	Site Pla	n/Site Analysis	Project North
t Date	7/05/2021	Page No.	Revision
ect Date	23/04/2018	PA-100	#
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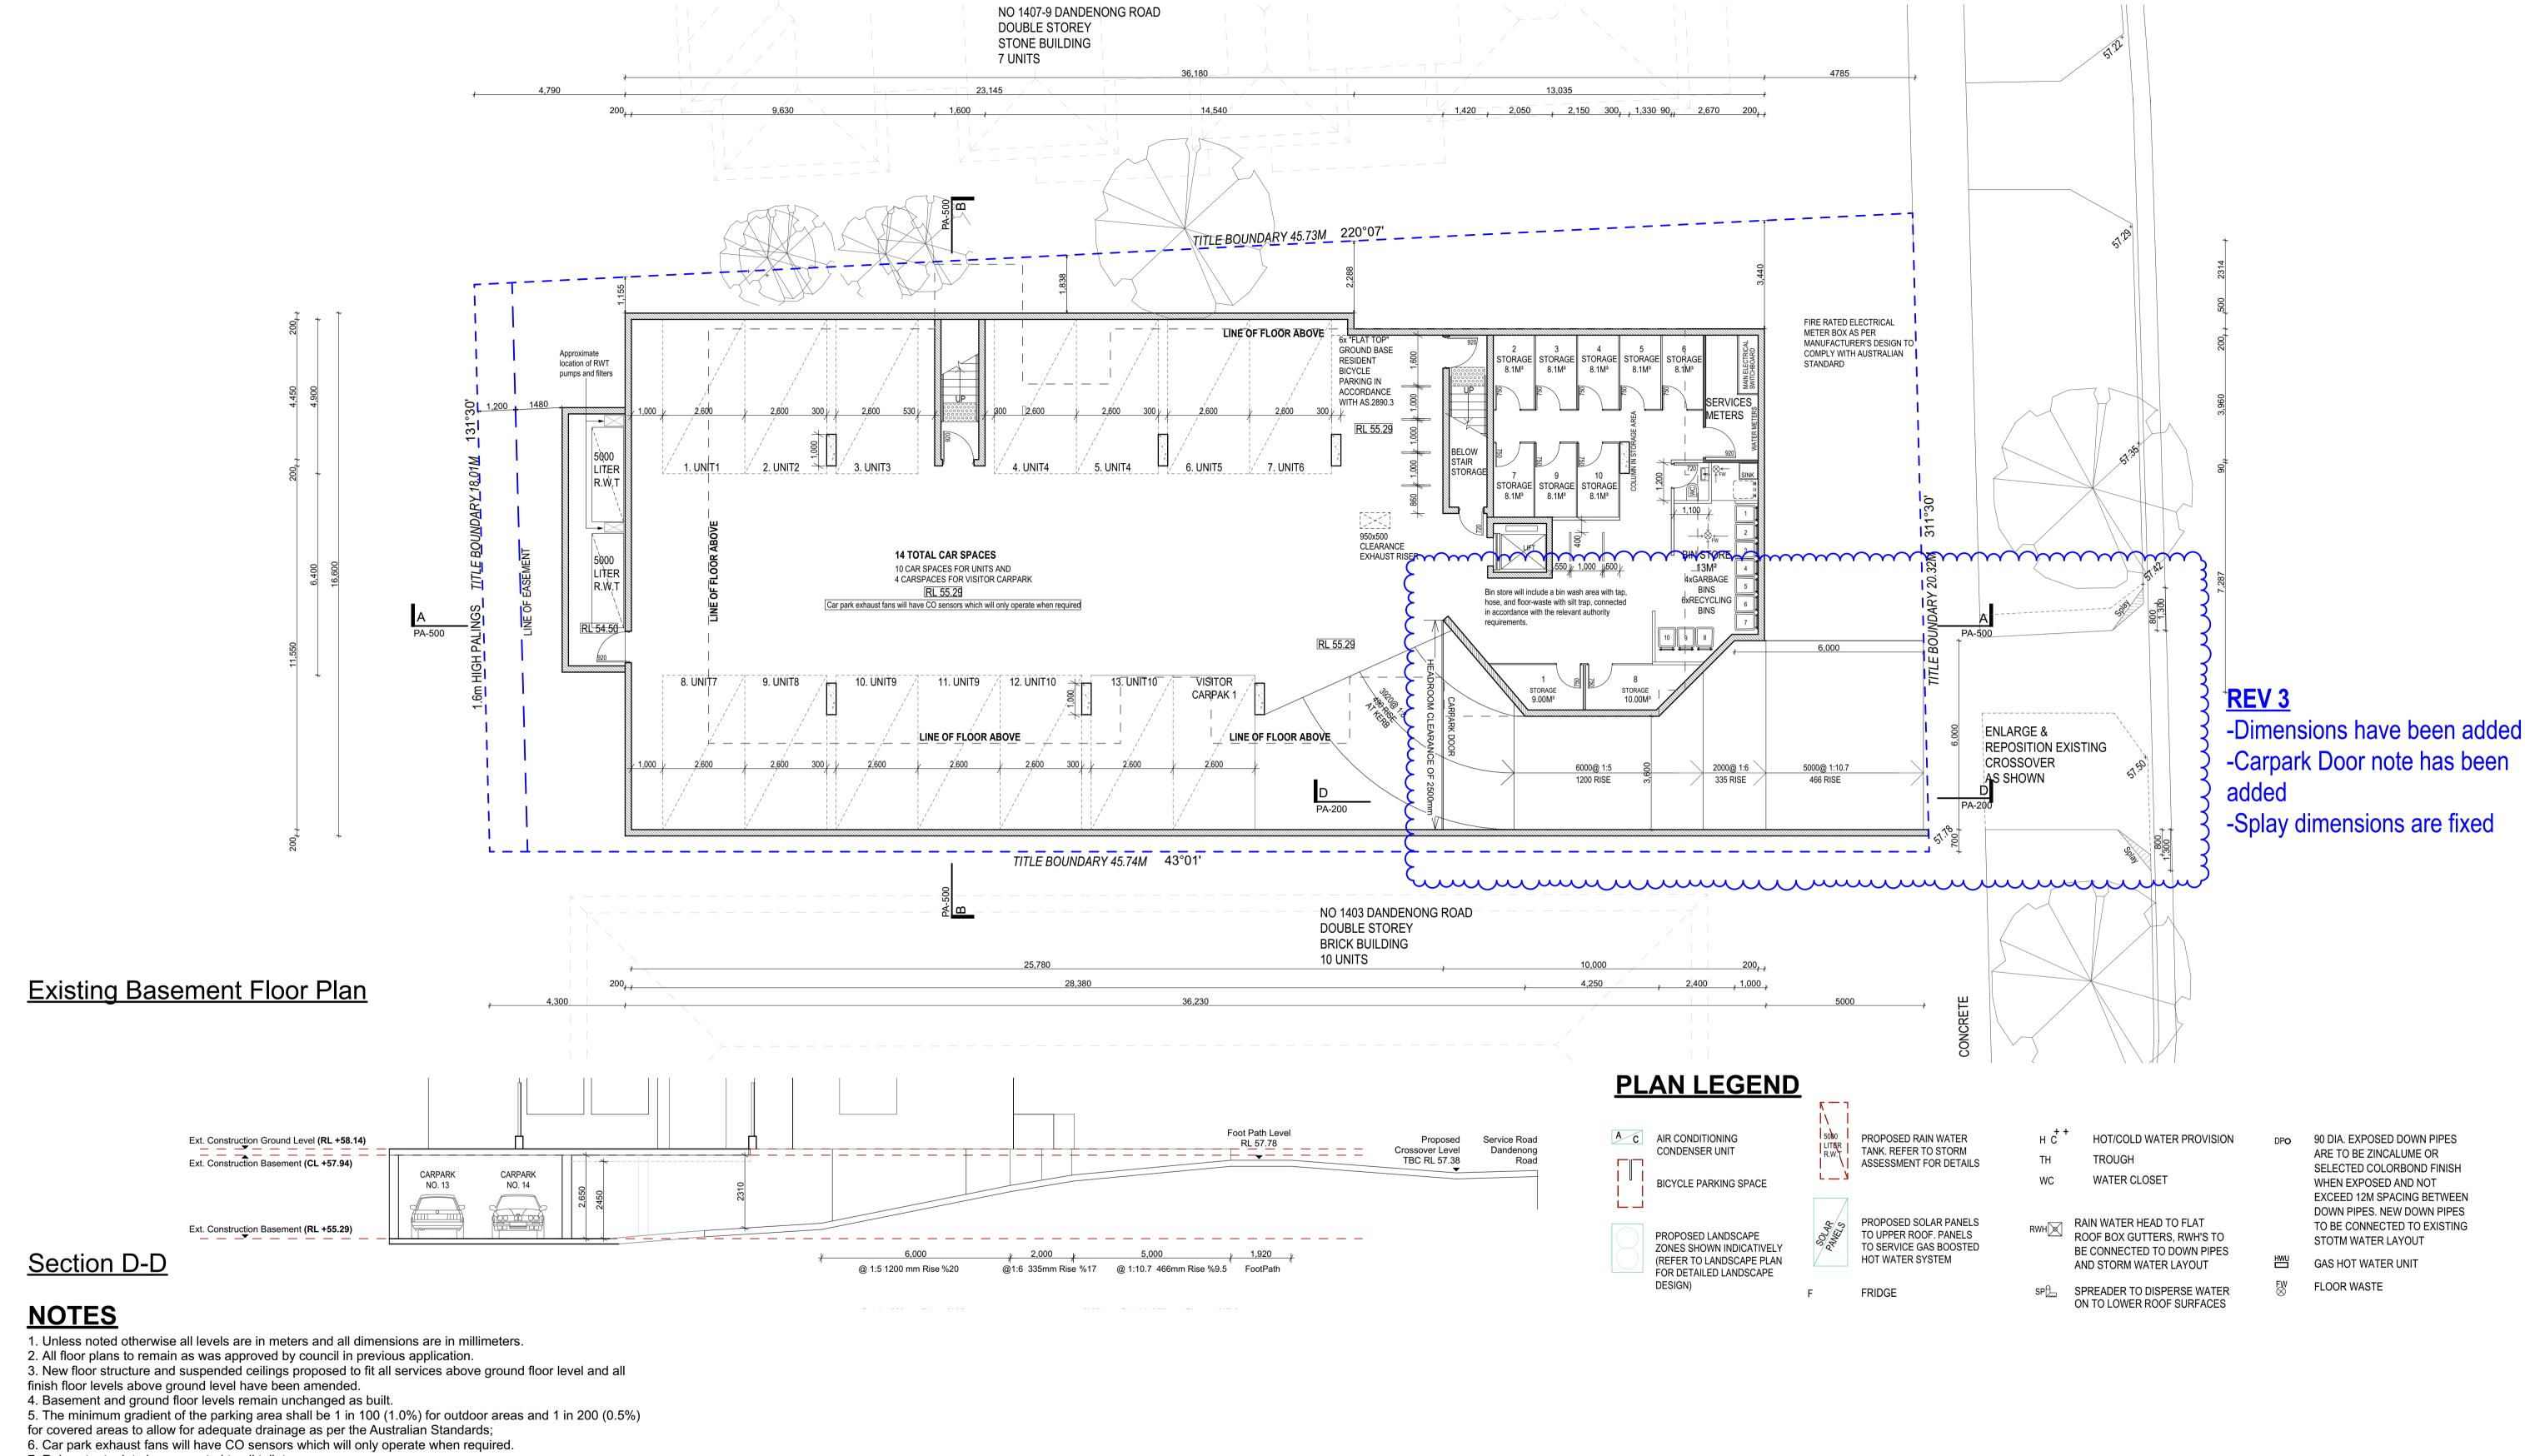
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No.	Description	Date

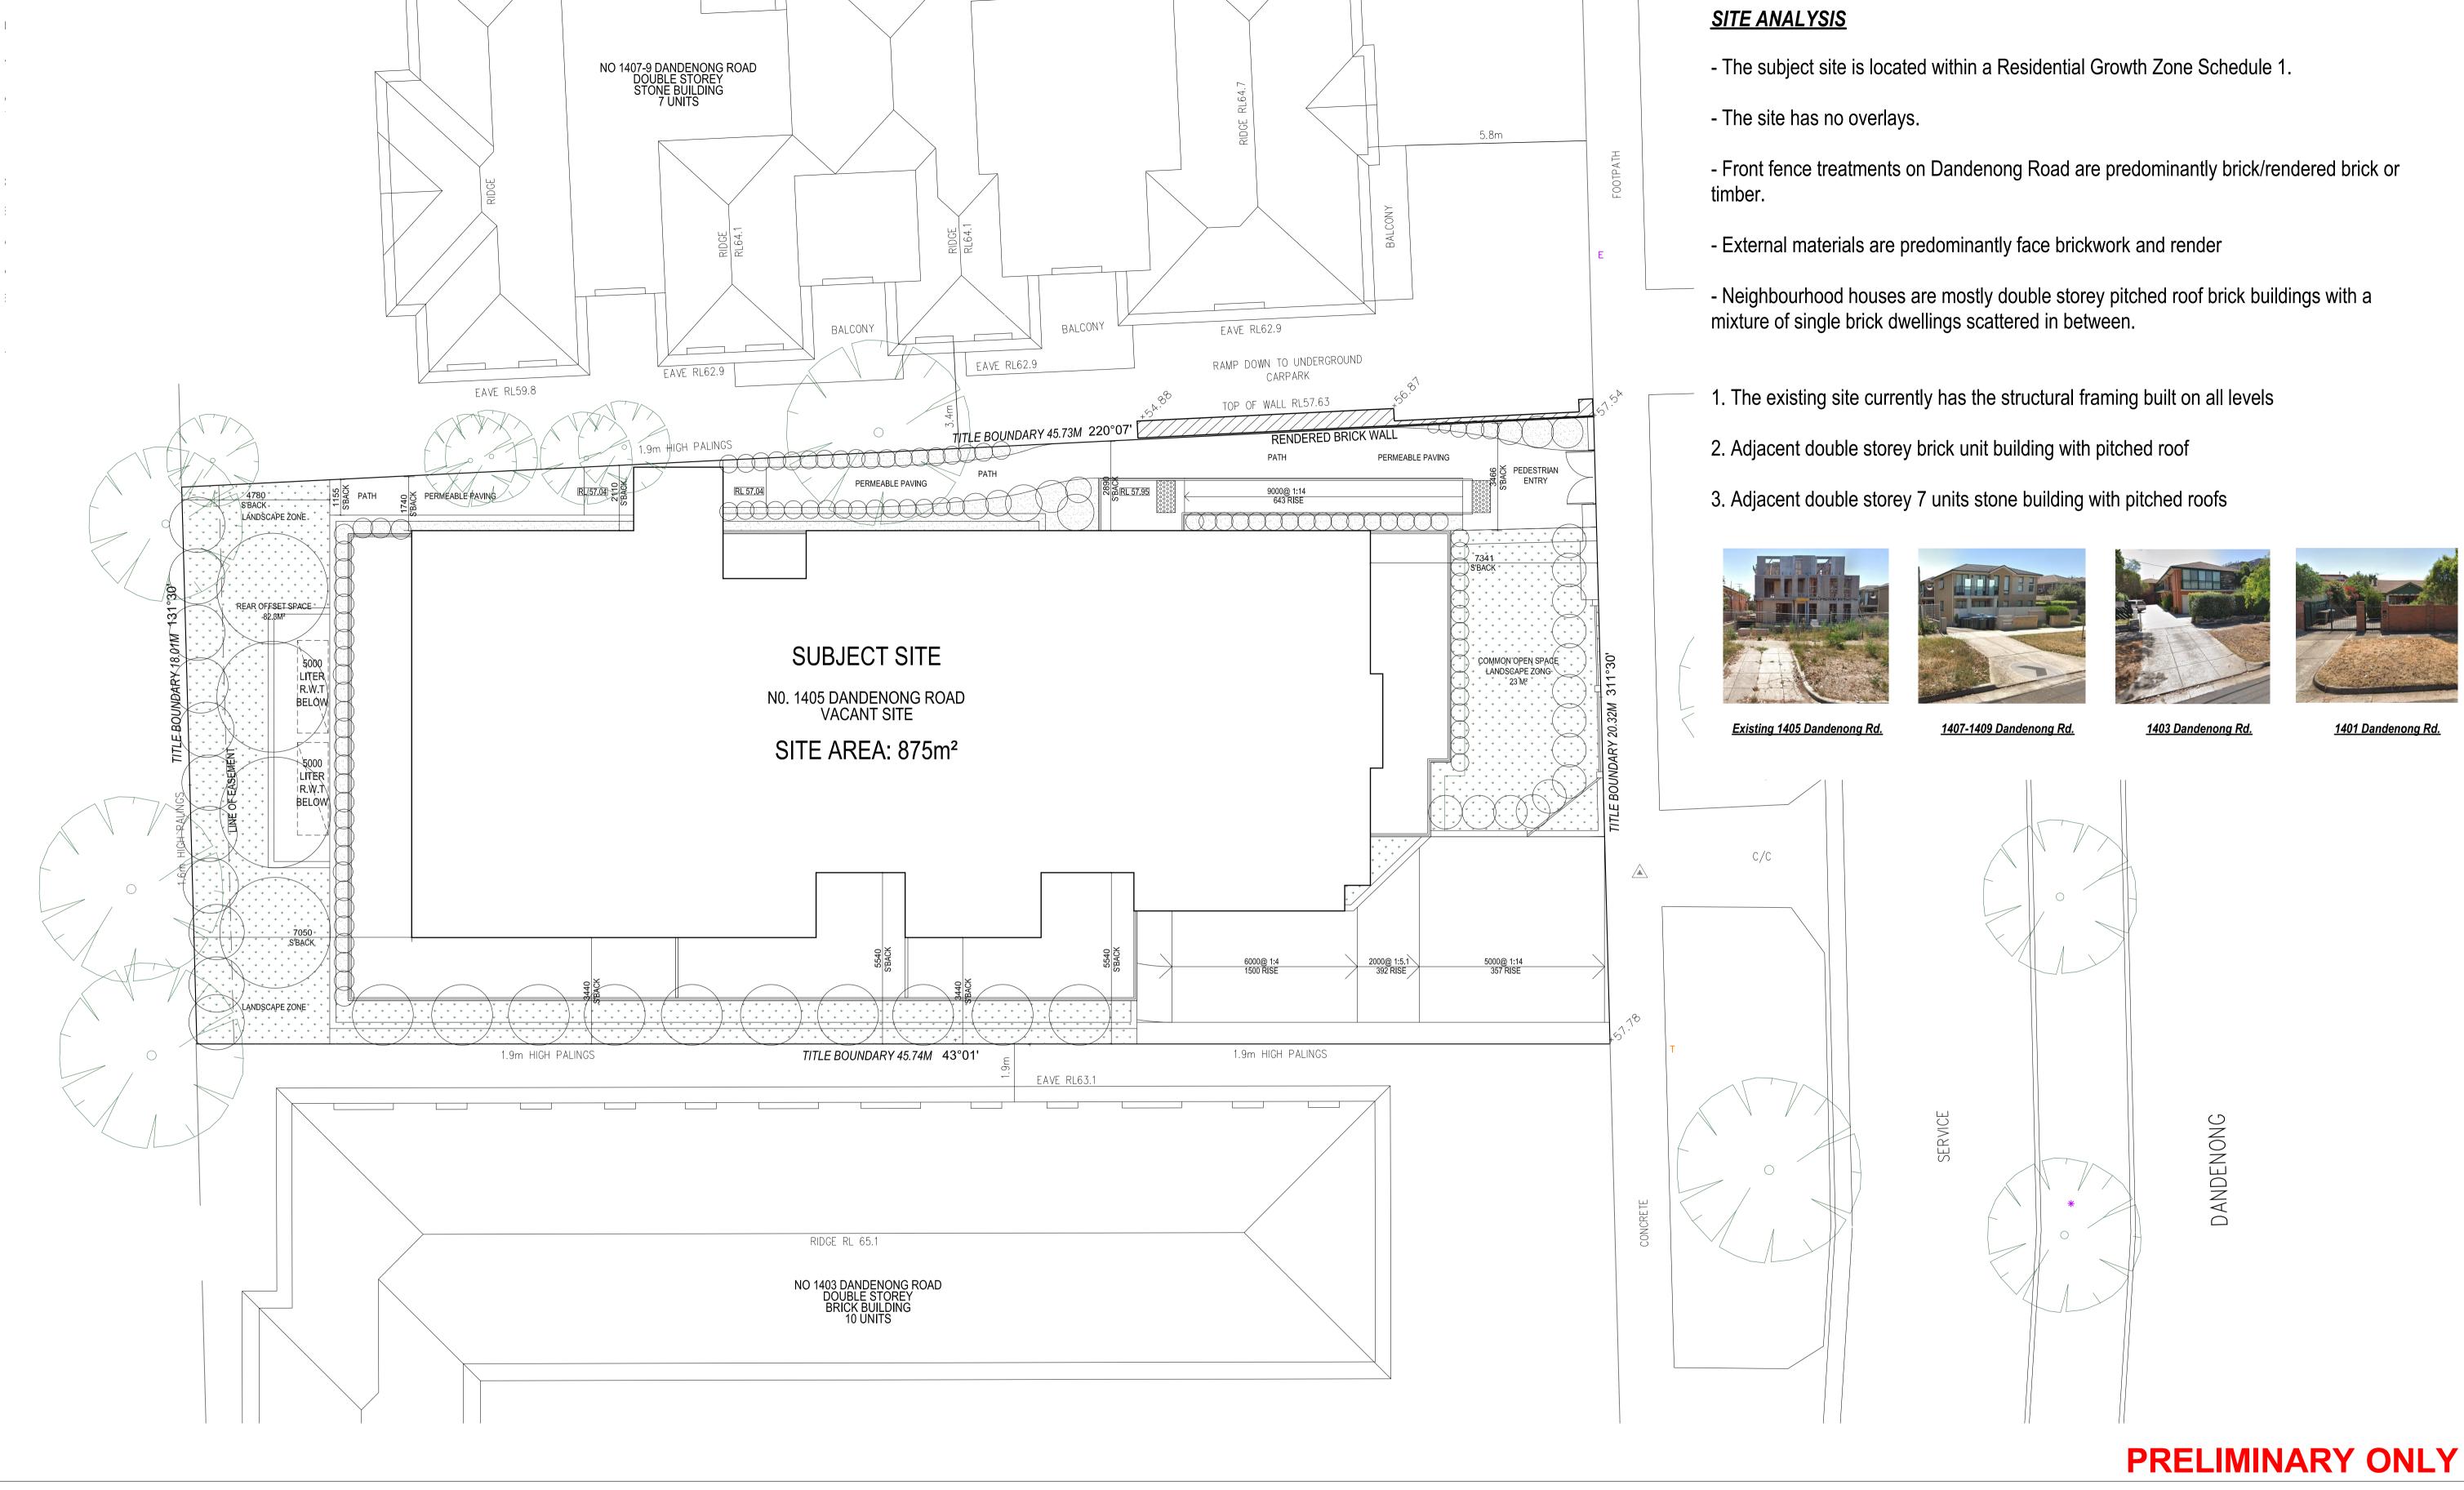1405 Dandenong Road Malvern East

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	Pr	KELIMINAKI	UNL
Drawing Title			
New Site	Plan/D	esign Response	770e Nony, Project North
Print Date	27/04/2021	Page No.	Revision
Project Date	23/04/2018	PA-101	#
Drawn by	YD/DM		
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- 7. Rainwater tank to be connected to all toilets8. 20% reduction in NCC2019 lighting is required

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2	Issued to Client & Council	23/06/2021
3	Issued to Council	13/07/2021

No.	Description	Date

405 Dandenong Road	Existing Basement Floor Plan			True North	
/lalvern East	Print Date	13/07/2021	Page No.	Revision	
	Project Date	23/04/2018	PA-200	3	
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3	Issued to Client & Council	23/06/2021
4	Issued to Council	13/07/2021

No.	Description	Date

1405 Dandenong Road Malvern East	Ground Floor Plan			True North Project North	
viaiveiii Last	Print Date	13/07/2021	Page No.	Revision	
	Project Date	23/04/2018	PA-201	4	
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WALK-IN ROBE WASHING MACHINE

FRIDGE

TROUGH

WATER CLOSET

SPREADER TO DISPERSE WATER ON TO LOWER ROOF SURFACES

SELECTED COLORBOND FINISH WHEN EXPOSED AND NOT **EXCEED 12M SPACING BETWEEN** DOWN PIPES. NEW DOWN PIPES TO BE CONNECTED TO EXISTING STOTM WATER LAYOUT

90 DIA. EXPOSED DOWN PIPES

ARE TO BE ZINCALUME OR

GAS HOT WATER UNIT FLOOR WASTE

DAND

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ct Title	Drawing Title				
405 Dandenong Road Ialvern East	First Flo	or Plan		Project North	
	Print Date	13/07/2021	Page No.	Revision	
	Droiget Date		PA-202	4	
	Project Date	23/04/2018		-	
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3	Issued to Council	13/07/2021

	No.	Description	Date
1			

1405 Dandenong Road	Drawing Title Second	Floor P	lan	
Malvern East				Project North
	Print Date	13/07/2021	Page No.	Revision
	Project Date	23/04/2018	PA-203	3
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ROAD

DANDENONG

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1	Issued to energy consultant	18/05/2021
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1	Issued to Client & Council	23/06/2021

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2	Issued to Council	13/07/2021

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oject Title	Drawing Title			
1405 Dandenong Road	Roof Pla	ın		- True A
Malvern East				,
	Print Date	13/07/2021	Page No.	Re
	Project Date	23/04/2018	PA-204	
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PLAN LEGEND

BICYCLE PARKING SPACE

PROPOSED LANDSCAPE

PROPOSED RAIN WATER TANK. REFER TO STORM
ASSESSMENT FOR DETAILS

PROPOSED SOLAR PANELS
TO UPPER ROOF. PANELS
TO SERVICE GAS BOOSTED

BE CONNECTED TO DOWN PIPES AND STORM WATER LAYOUT

WATER CLOSET

RAIN WATER HEAD TO FLAT ROOF BOX GUTTERS, RWH'S TO

SPREADER TO DISPERSE WATER ON TO LOWER ROOF SURFACES


STOTM WATER LAYOUT

GAS HOT WATER UNIT

FLOOR WASTE

90 DIA. EXPOSED DOWN PIPES ARE TO BE ZINCALUME OR SELECTED COLORBOND FINISH WHEN EXPOSED AND NOT EXCEED 12M SPACING BETWEEN DOWN PIPES. NEW DOWN PIPES TO BE CONNECTED TO EXISTING

ZONES SHOWN INDICATIVELY (REFER TO LANDSCAPE PLAN FOR DETAILED LANDSCAPE

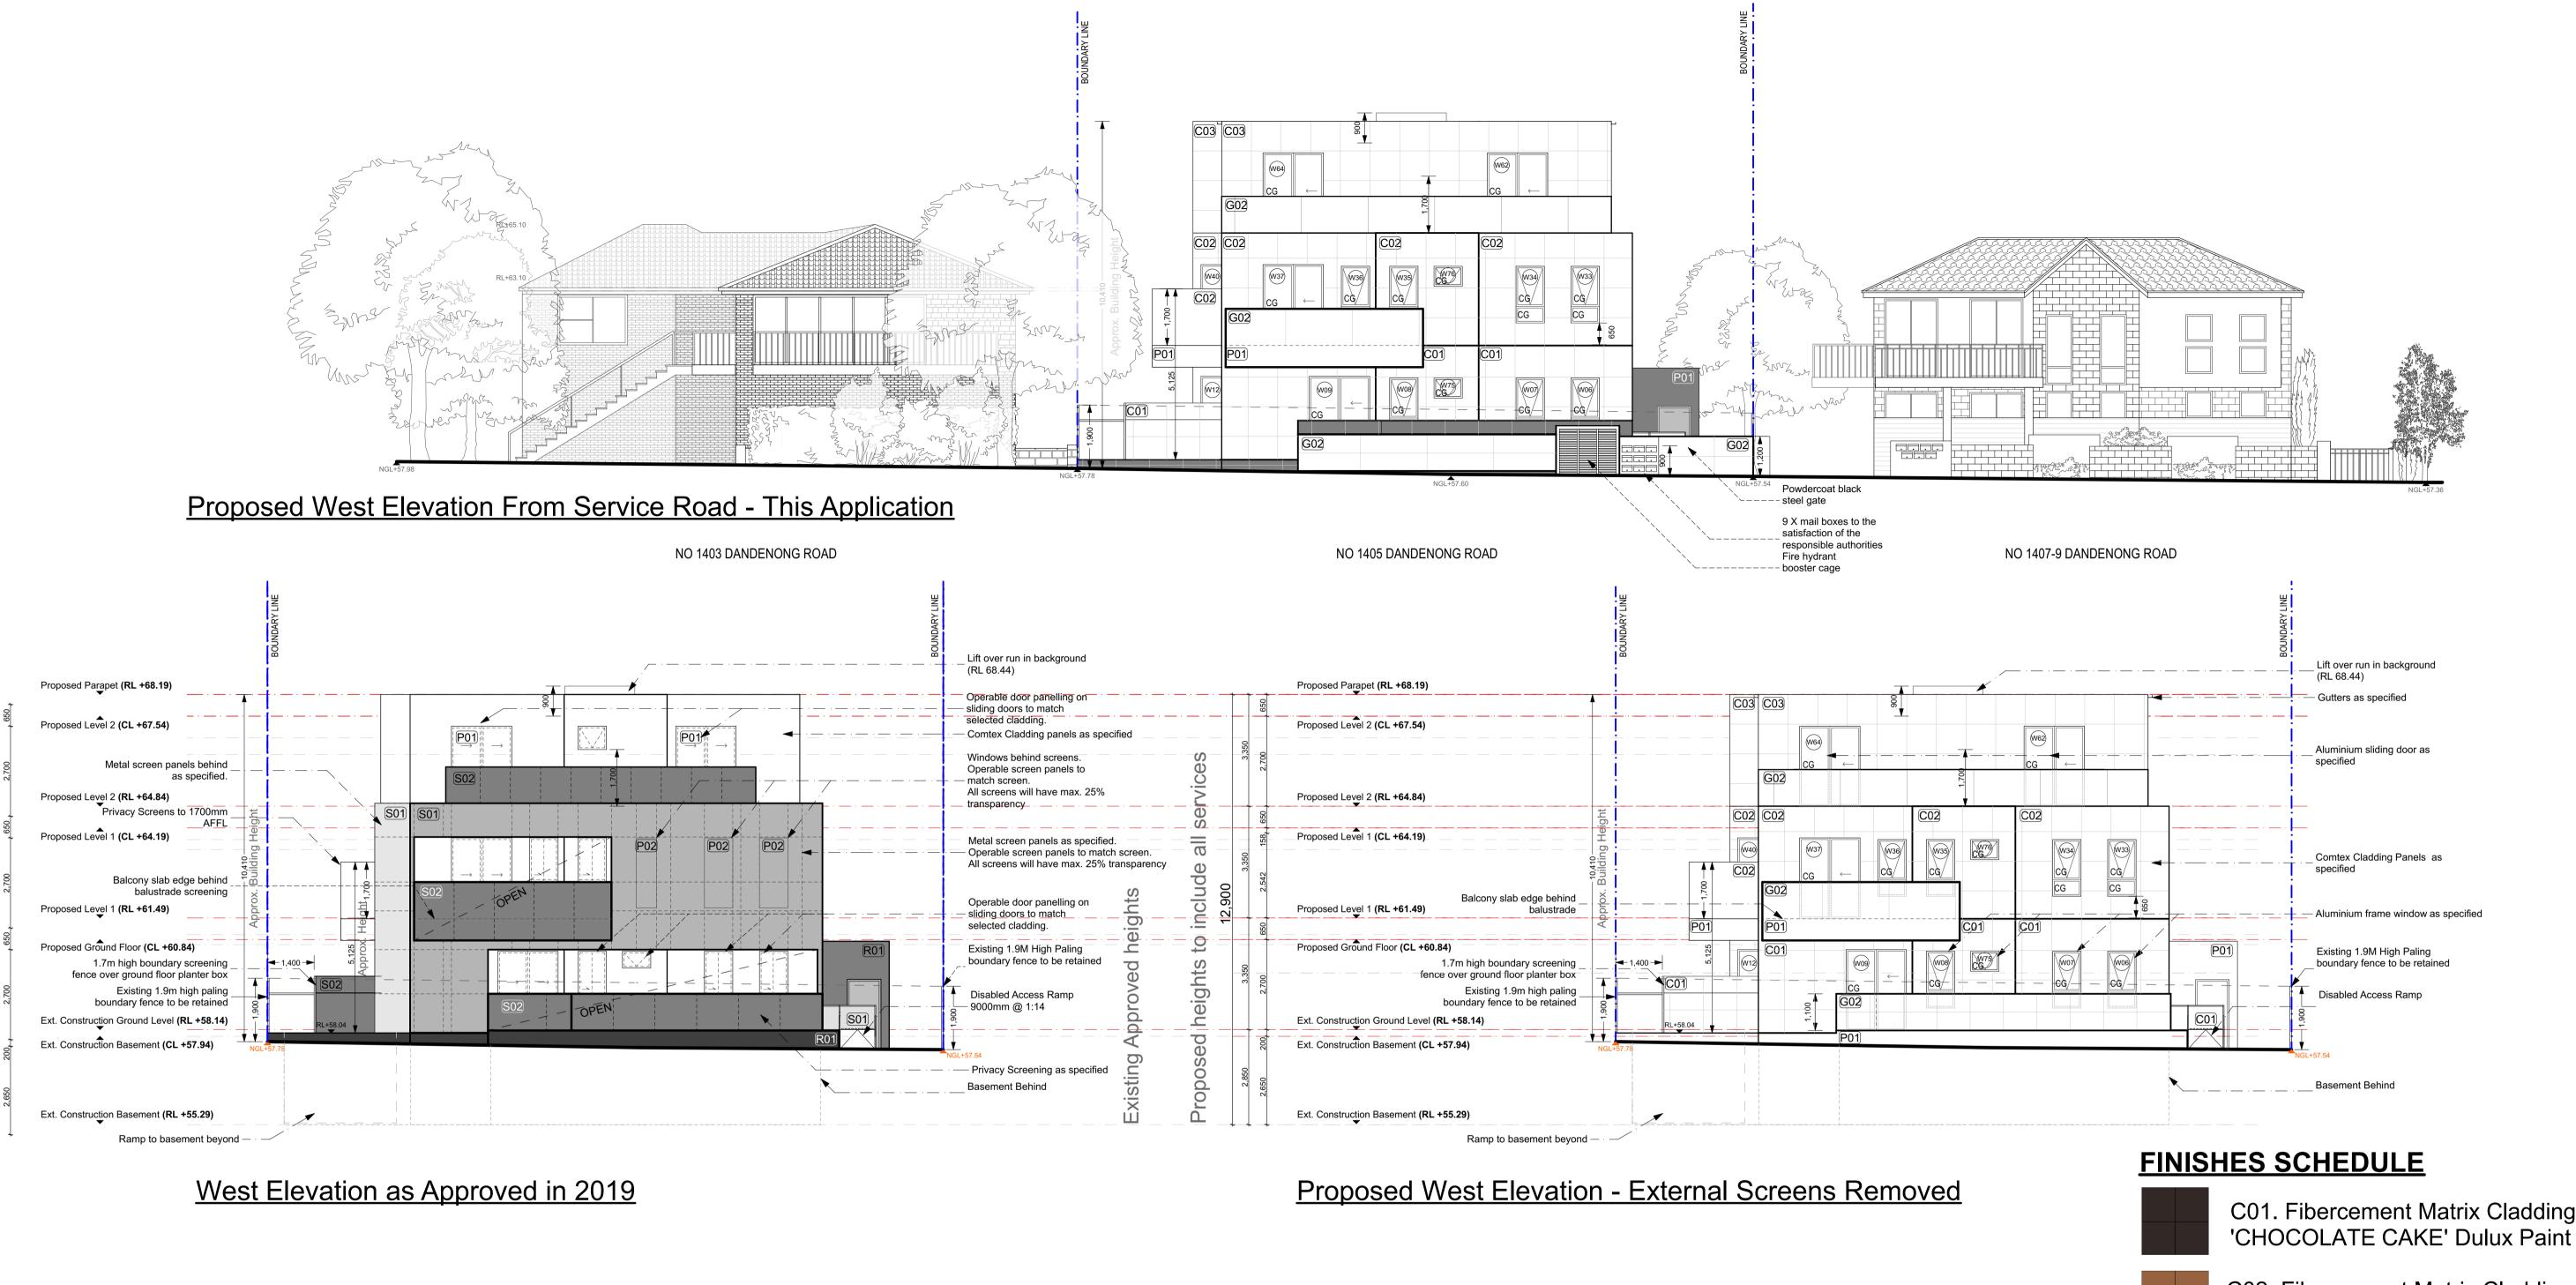

NOTES:

- 1. Unless noted otherwise all levels are in meters and all dimensions are in millimeters.
- 2. All floor plans to remain as was approved by council in previous
- 3. New perforated metal screening proposed.
- 4. For new screen patterns and colours refer to PA-900 Schedule.
- 5. New floor structure and suspended ceilings proposed to fit all services

above ground floor level.

- 6. Basement and ground floor levels remain unchanged as
- 7. Pedestrian visibility splay 2m wide x 2.5 m deep. All structures including fences and vegetation within the splay must not be more than 900mm height. Sight triangle to be atleast 50% clear of visual obstructions.

C01. Fibercement Matrix Cladding with



C02. Fibercement Matrix Cladding with 'AMBIT' Dulux Paint




C03. Fibercement Matrix Cladding with 'ZINC BLEND' Dulux Paint



P01. Dulux 'CHOCOLATE CAKE'




G02. Clear Glass
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Submitted to Council	7/05/2021
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No.	Description	Date
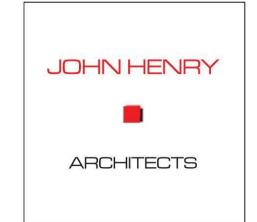
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	Print Date	7/05/2021	Page No.	Revision
	Project Date	23/04/2018	PA-400	7
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East Elevation As Approved in 2019

Proposed East Elevation - External Screens Removed

NOTES:

- 1. Unless noted otherwise all levels are in meters and all dimensions are in millimeters.
- 2. All floor plans to remain as was approved by council in previous application. 3. New floor structure and suspended ceilings proposed to fit all services
- above ground floor level.
- 6. Basement and ground floor levels remain unchanged as built.
- 7. Pedestrian visibility splay 2m wide x 2.5 m deep. All structures including fences and vegetation within the splay must not be more than
- 900mm height. Sight triangle to be atleast 50% clear of visual obstructions.
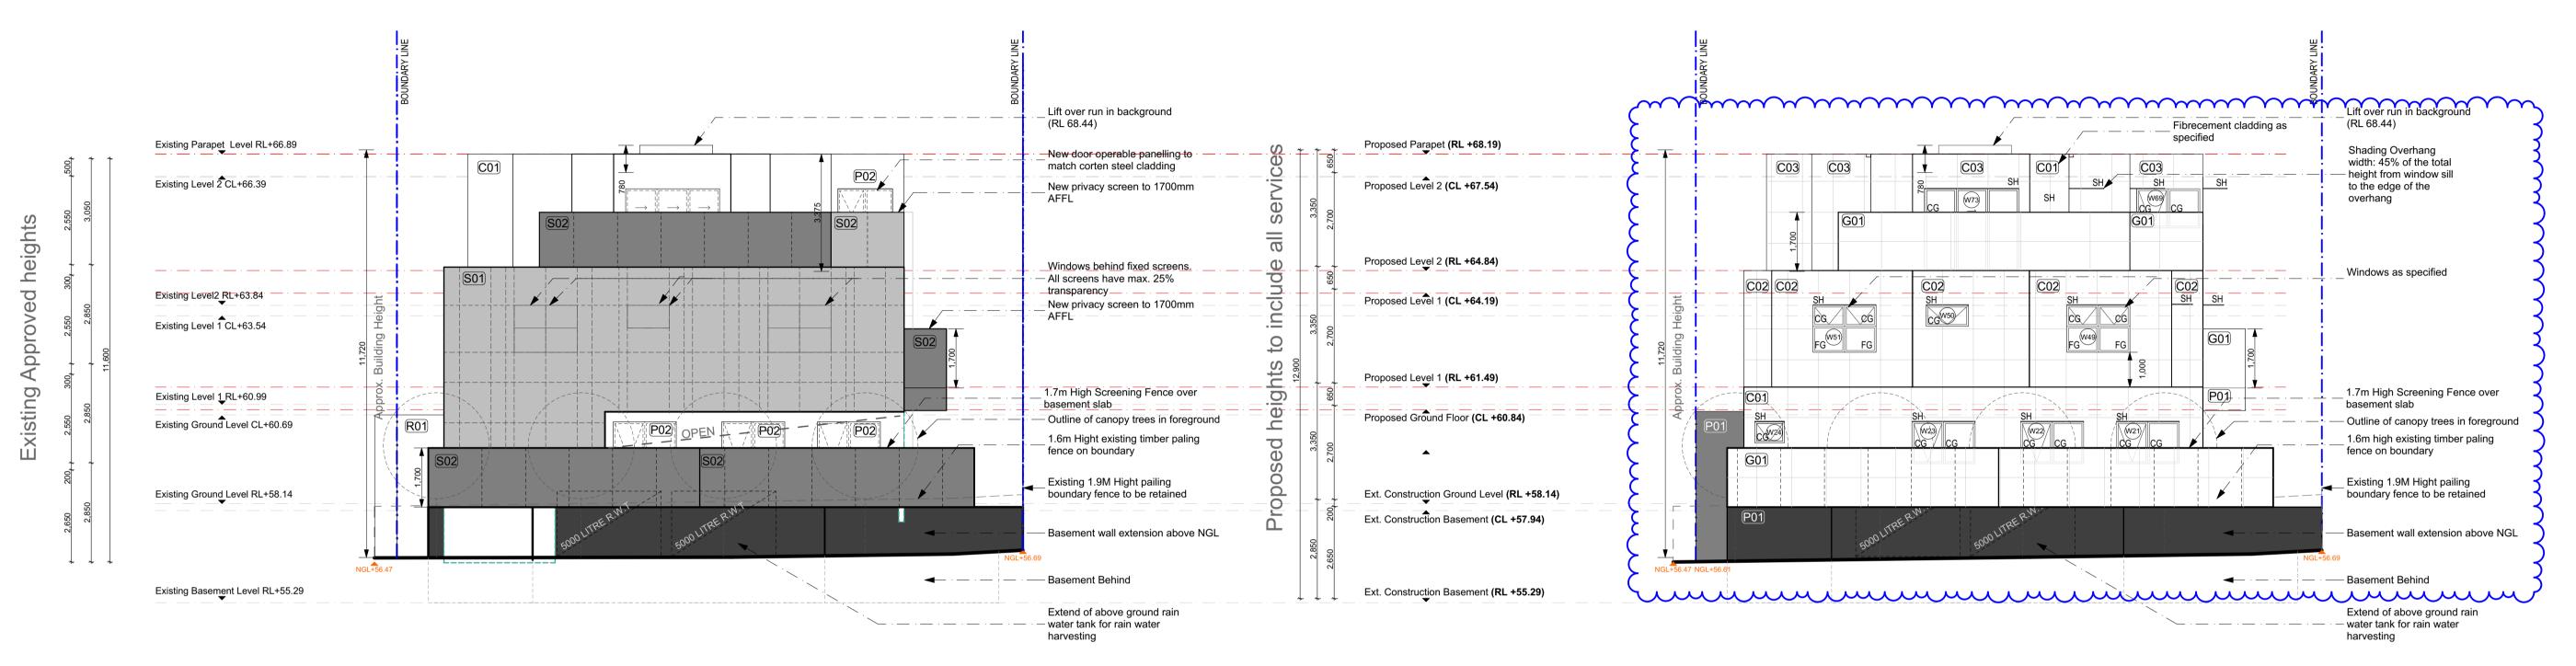
<u>Legend:</u>

Proposed Level Line (Red) Existing Level Line (Grey)

FG Frosted Glass

SH Shading Overhangs

FINISHES SCHEDULE

C01. Fibercement Matrix Cladding with 'CHOCOLATE CAKE' Dulux Paint



C02. Fibercement Matrix Cladding with 'AMBIT' Dulux **Paint**



Checked by

C03. Fibercement Matrix Cladding with 'ZINC BLEND' **Dulux Paint**




P01. Dulux 'CHOCOLATE CAKE'

william with the same of the s

G01. Bronze Frosted Glass (no more than 25% \nearrow transparency with visual light transmittance (VLT) \geq 70%.)

JH | Scale 1:100@A1, 1:200 @ A3

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3	Issued to Council	13/07/2021

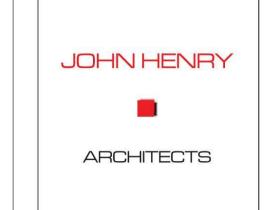No.	Description	Date

Project Title	Drawing Title		
1405 Dandenong Road	Propos	ed East	Elevation
Malvern East			
	Print Date	13/07/2021	Page No.
	Project Date	23/04/2018	PA-401
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-ESD Annotation has been added

REV 3

North Elevation As Approved in 2019 glazing to 1700mm above Proposed Level 2 (CL +67.54) to the edge of the Windows to have obscure glazing to 1700mm above FFL Shading Overhang width: 45% of the total Proposed Level 2 (RL +64.84) height from window sill to the edge of the Proposed Level 1 (CL +64.19) Outline of canopy trees in Existing 1.9M Hight pailing boundary fence to be retained Proposed Level 1 (RL +61.49) 1.7m High Screening Fence over Proposed Ground Floor (CL +60.84) C01 C01 CG (W13) CG (CG (W15) CG (W14) CG (W13) CO1 Existing 1.9M Hight pailing boundary fence to be retained ENEW WANT Ext. Construction Ground Level (RL +58.14) Ext. Construction Basement (CL +57.94) P01 - Basement Behind - Ramp to basement beyond Basement wall extension above Ext. Construction Basement (RL +55.29)

Proposed North Elevation - External Screens Removed

Basement Behind -

NOTES:

obstructions.

- 1. Unless noted otherwise all levels are in meters and all dimensions are in millimeters.
- 2. All floor plans to remain as was approved by council in previous application.3. New floor structure and suspended ceilings proposed to fit all services
- above ground floor level.
- 6. Basement and ground floor levels remain unchanged as built.
 7. Pedestrian visibility splay 2m wide x 2.5 m deep. All structures including fences and vegetation within the splay must not be more than 900mm height. Sight triangle to be atleast 50% clear of visual

Legend:

Proposed Level Line (Red) Existing Level Line (Grey)

FG Frosted Glass

SH Shading Overhangs

C03. Fibercement Matrix Cladding with 'ZINC BLEND' Dulux Paint

REV 4

-ESD annotation has been added

P01. Dulux 'CHOCOLATE CAKE'

FINISHES SCHEDULE

Dulux Paint


C01. Fibercement Matrix Cladding with

C02. Fibercement Matrix Cladding with 'AMBIT'

'CHOCOLATE CAKE' Dulux Paint


P02. Dulux 'AMBIT'

 \sim G01. Bronze Frosted Glass (no more than 25% . transparency with visual light transmittance (VLT) <u>≥ 70%.</u>)

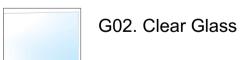


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4	Issued to Council	13/07/2021			

Project Title	Drawing Title			
1405 Dandenong Road	Propos	ed North	n Elevation	
Malvern East				
	Print Date	13/07/2021	Page No.	F
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REV 2

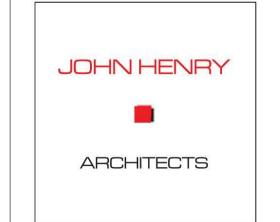Description

-ESD annotation has been added

Date

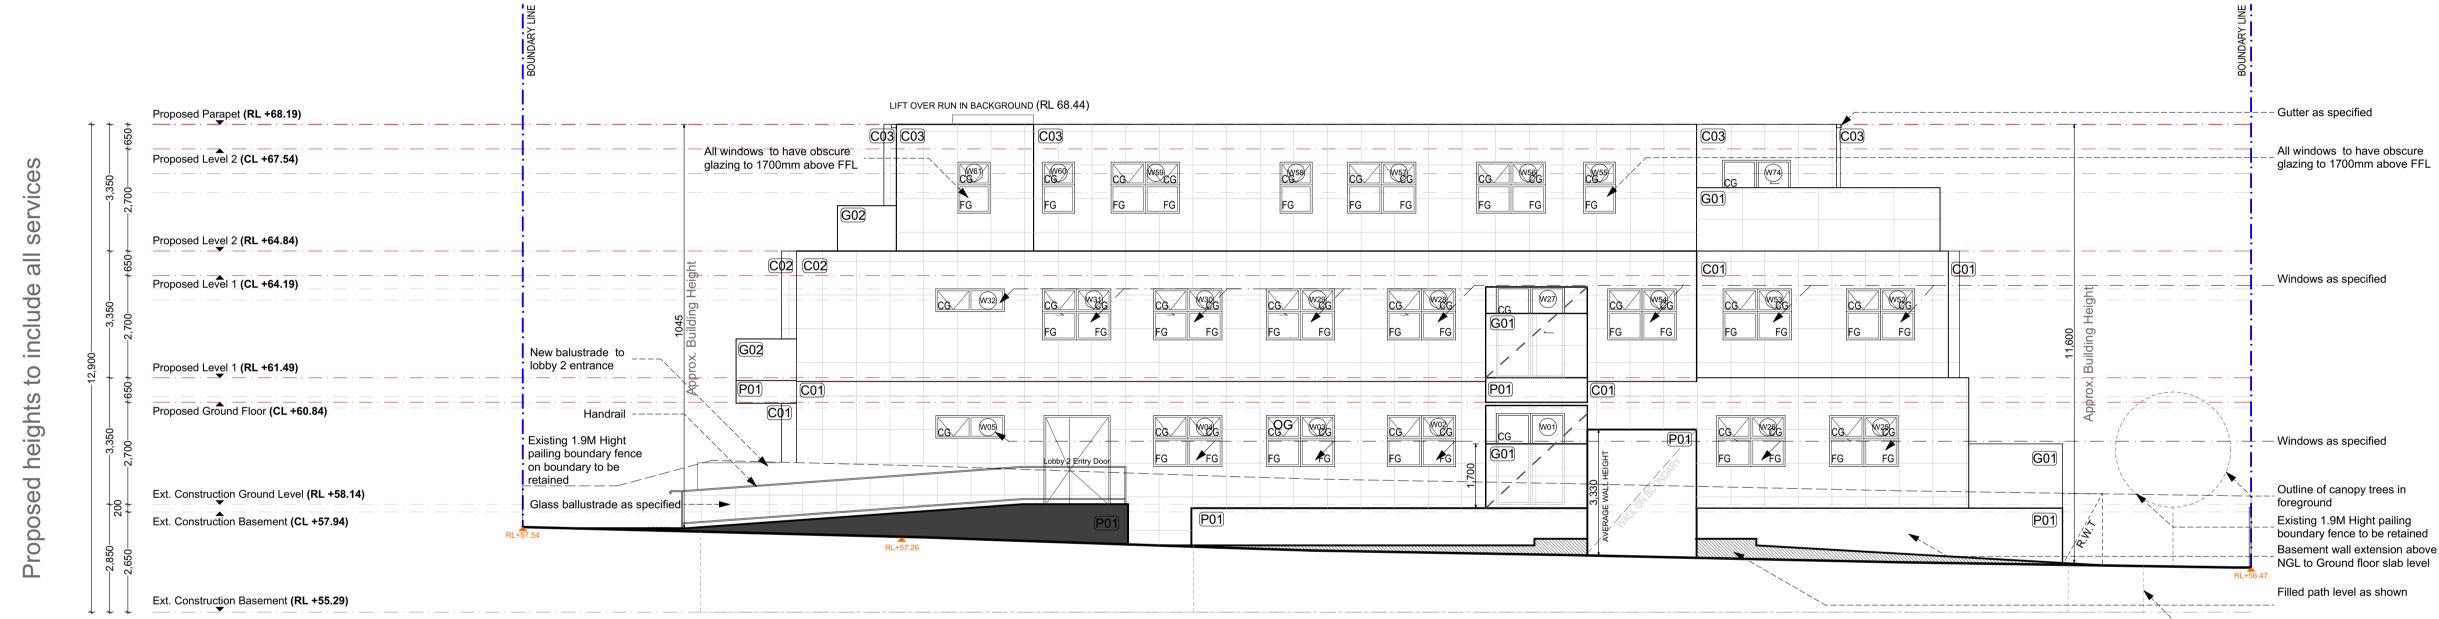Proposed South Elevation - External Screens Removed

NOTES:

- 1. Unless noted otherwise all levels are in meters and all dimensions are in millimeters.
- 2. All floor plans to remain as was approved by council in previous application. 3. New floor structure and suspended ceilings proposed to fit all services
- above ground floor level.
- 6. Basement and ground floor levels remain unchanged as built.
 7. Pedestrian visibility splay 2m wide x 2.5 m deep. All structures including fences and vegetation within the splay must not be more than 900mm height. Sight triangle to be atleast 50% clear of visual obstructions.

Legend:

Proposed Level Line (Red)

Existing Level Line (Grey)

FG Frosted Glass

FINISHES SCHEDULE

C01. Fibercement Matrix Cladding with 'CHOCOLATE CAKE' Dulux Paint

C02. Fibercement Matrix Cladding with 'AMBIT' **Dulux Paint**

C03. Fibercement Matrix Cladding with 'ZINC BLEND' Dulux Paint

P01. Dulux 'CHOCOLATE CAKE'


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m

G01. Bronze Frosted Glass (no more than 25% 🧸

<u>_> 70%.)</u>

transparency with visual light transmittance (VLT)

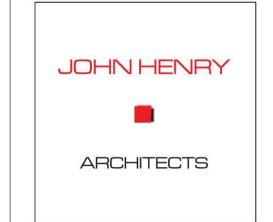

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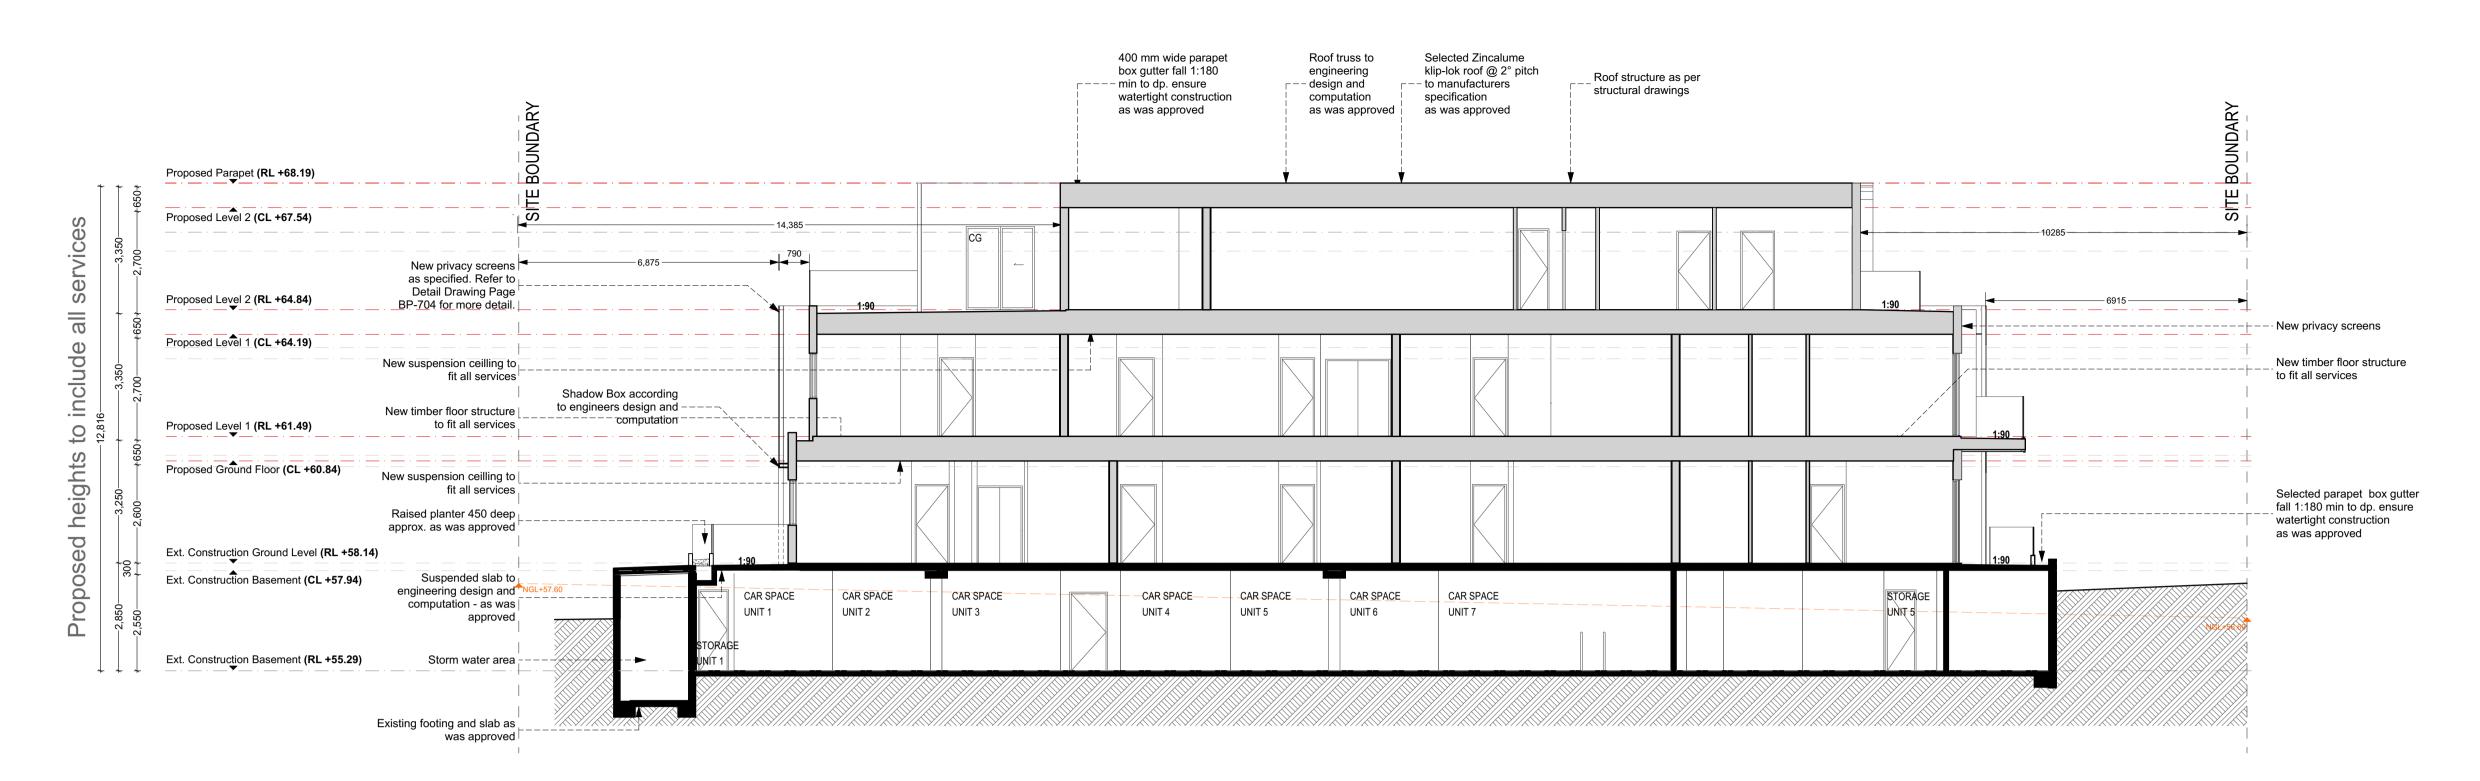
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1	Submitted to Council	7/05/2021		
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2	Issued to Council	13/07/2021		

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Project Title	Drawing Title			
1405 Dandenong Road	Propos	ed South	n Elevation	
Malvern East				_
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	Project Date	23/04/2018	PA-403	
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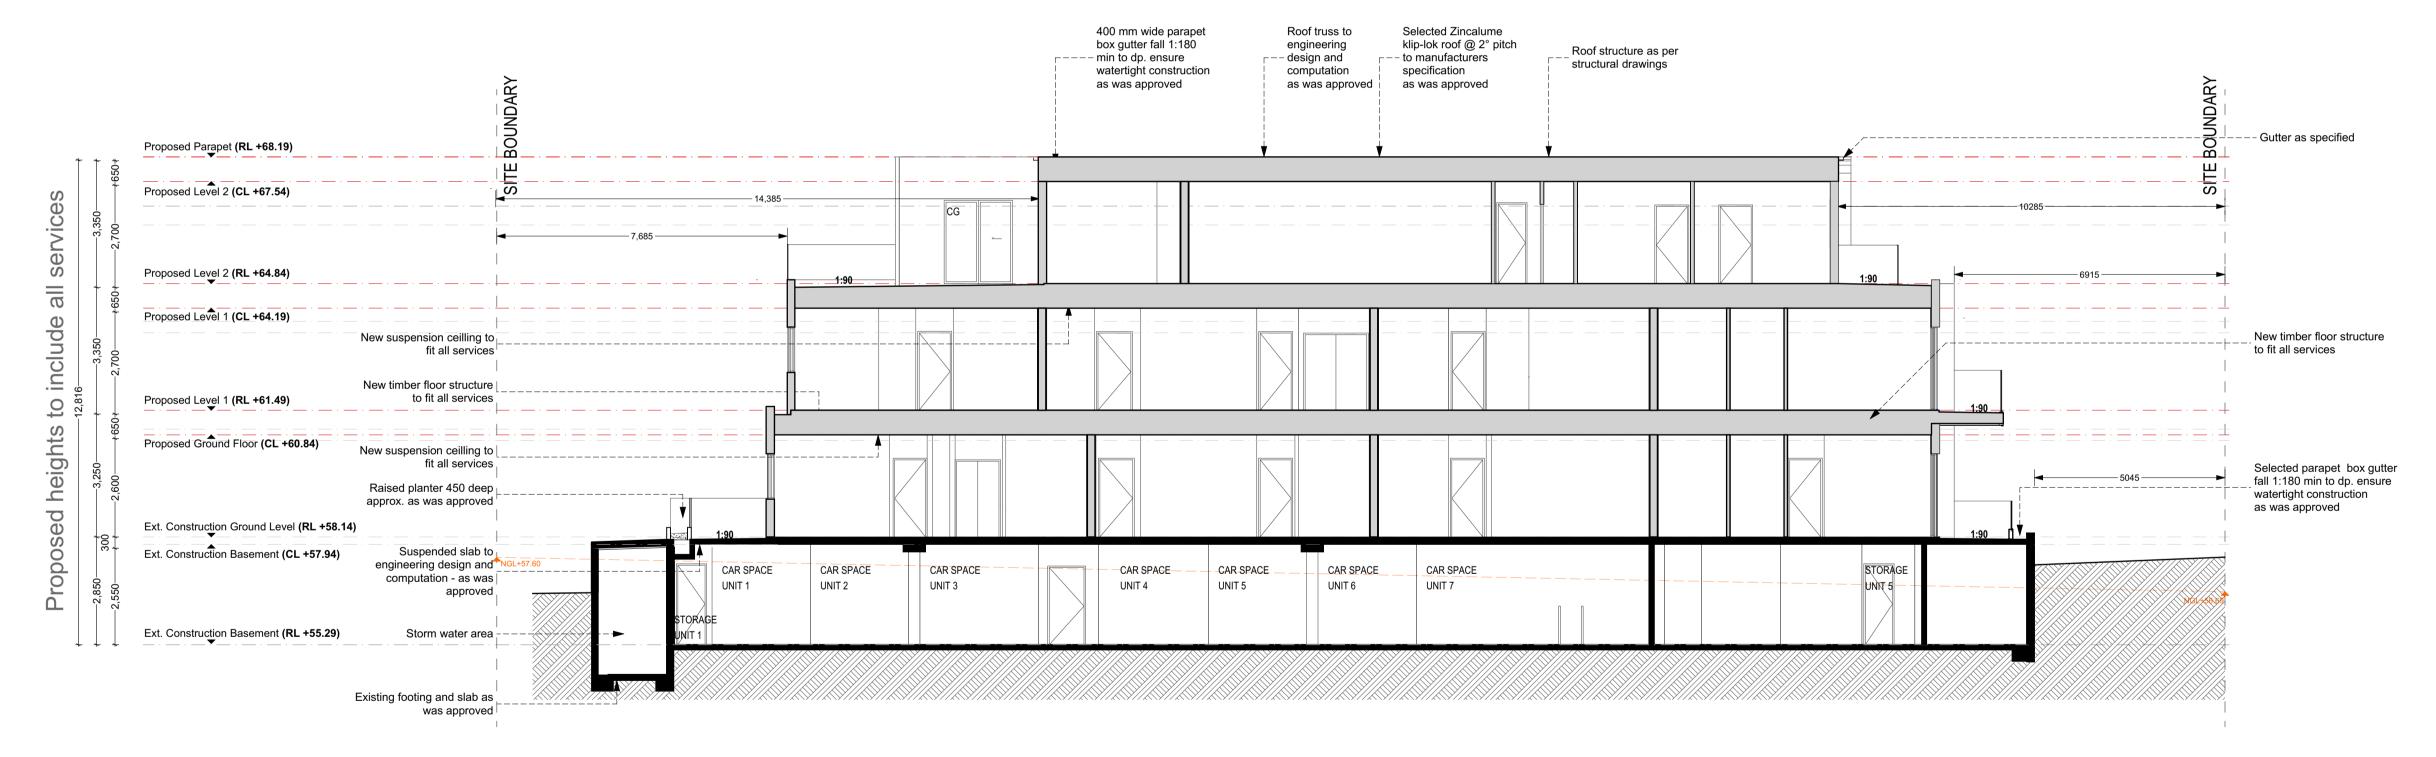
Basement Behind

P02. Dulux 'AMBIT'

G02. Clear Glass



Section A-A As Approved in 2019




New Section A-A - External Screens Removed

<u>Legend:</u>

Proposed Level Line (Red) ------Existing Level Line (Grey)


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No.	Description	Date

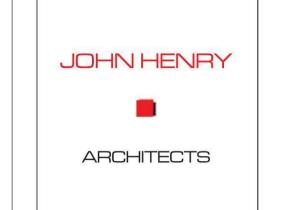oject Title	Drawing Title			
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Malvern East				
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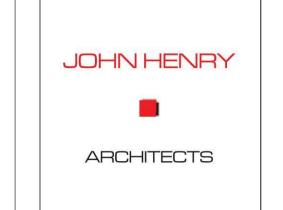
Section B-B As Approved in 2019

New Section B-B - External Screens Removed

<u>Legend:</u>

Proposed Level Line (Red) Existing Level Line (Grey)
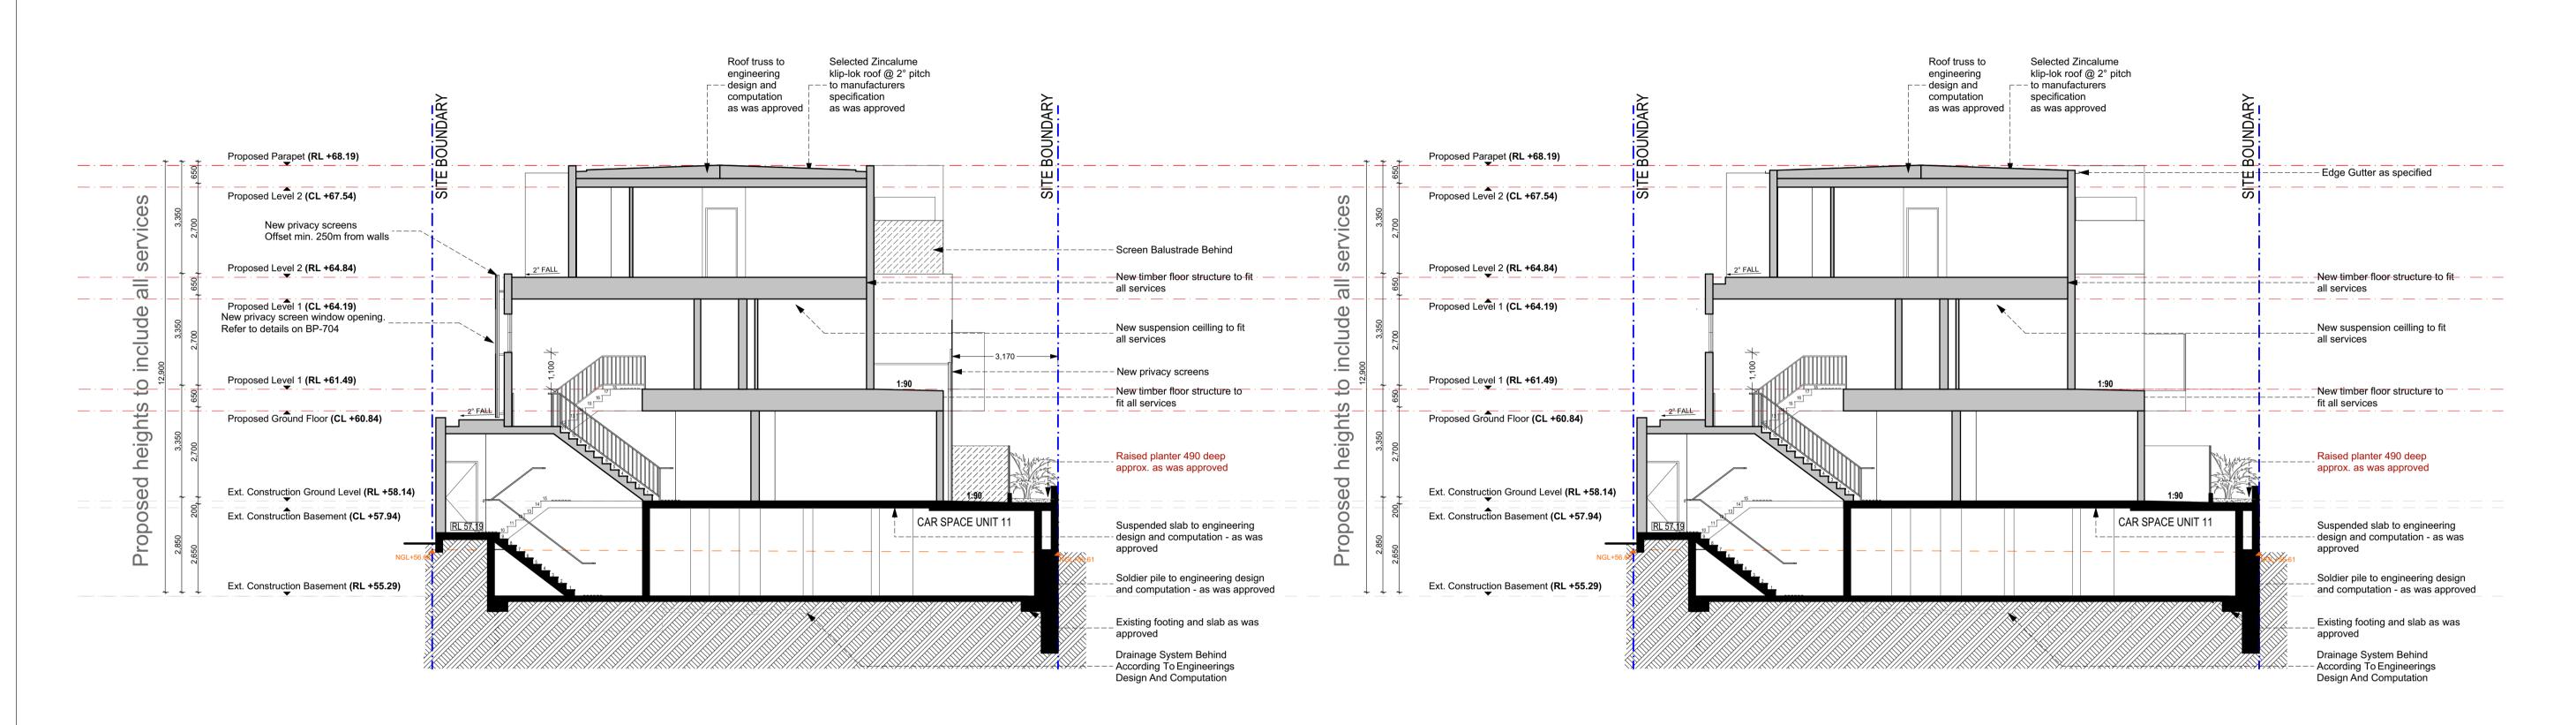
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#	Submitted to Council	22/03/2021	
#	Submitted to Council	27/04/2021	
#	Submitted to Council	7/05/2021	

9	No.	Description	Date	
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Project Title	Drawing Title	
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Section	B-B		
Print Date	7/05/2021	Page No.	Revision
Project Date	23/04/2018	PA-501	#
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10 A.M. 22 SEPTEMBER

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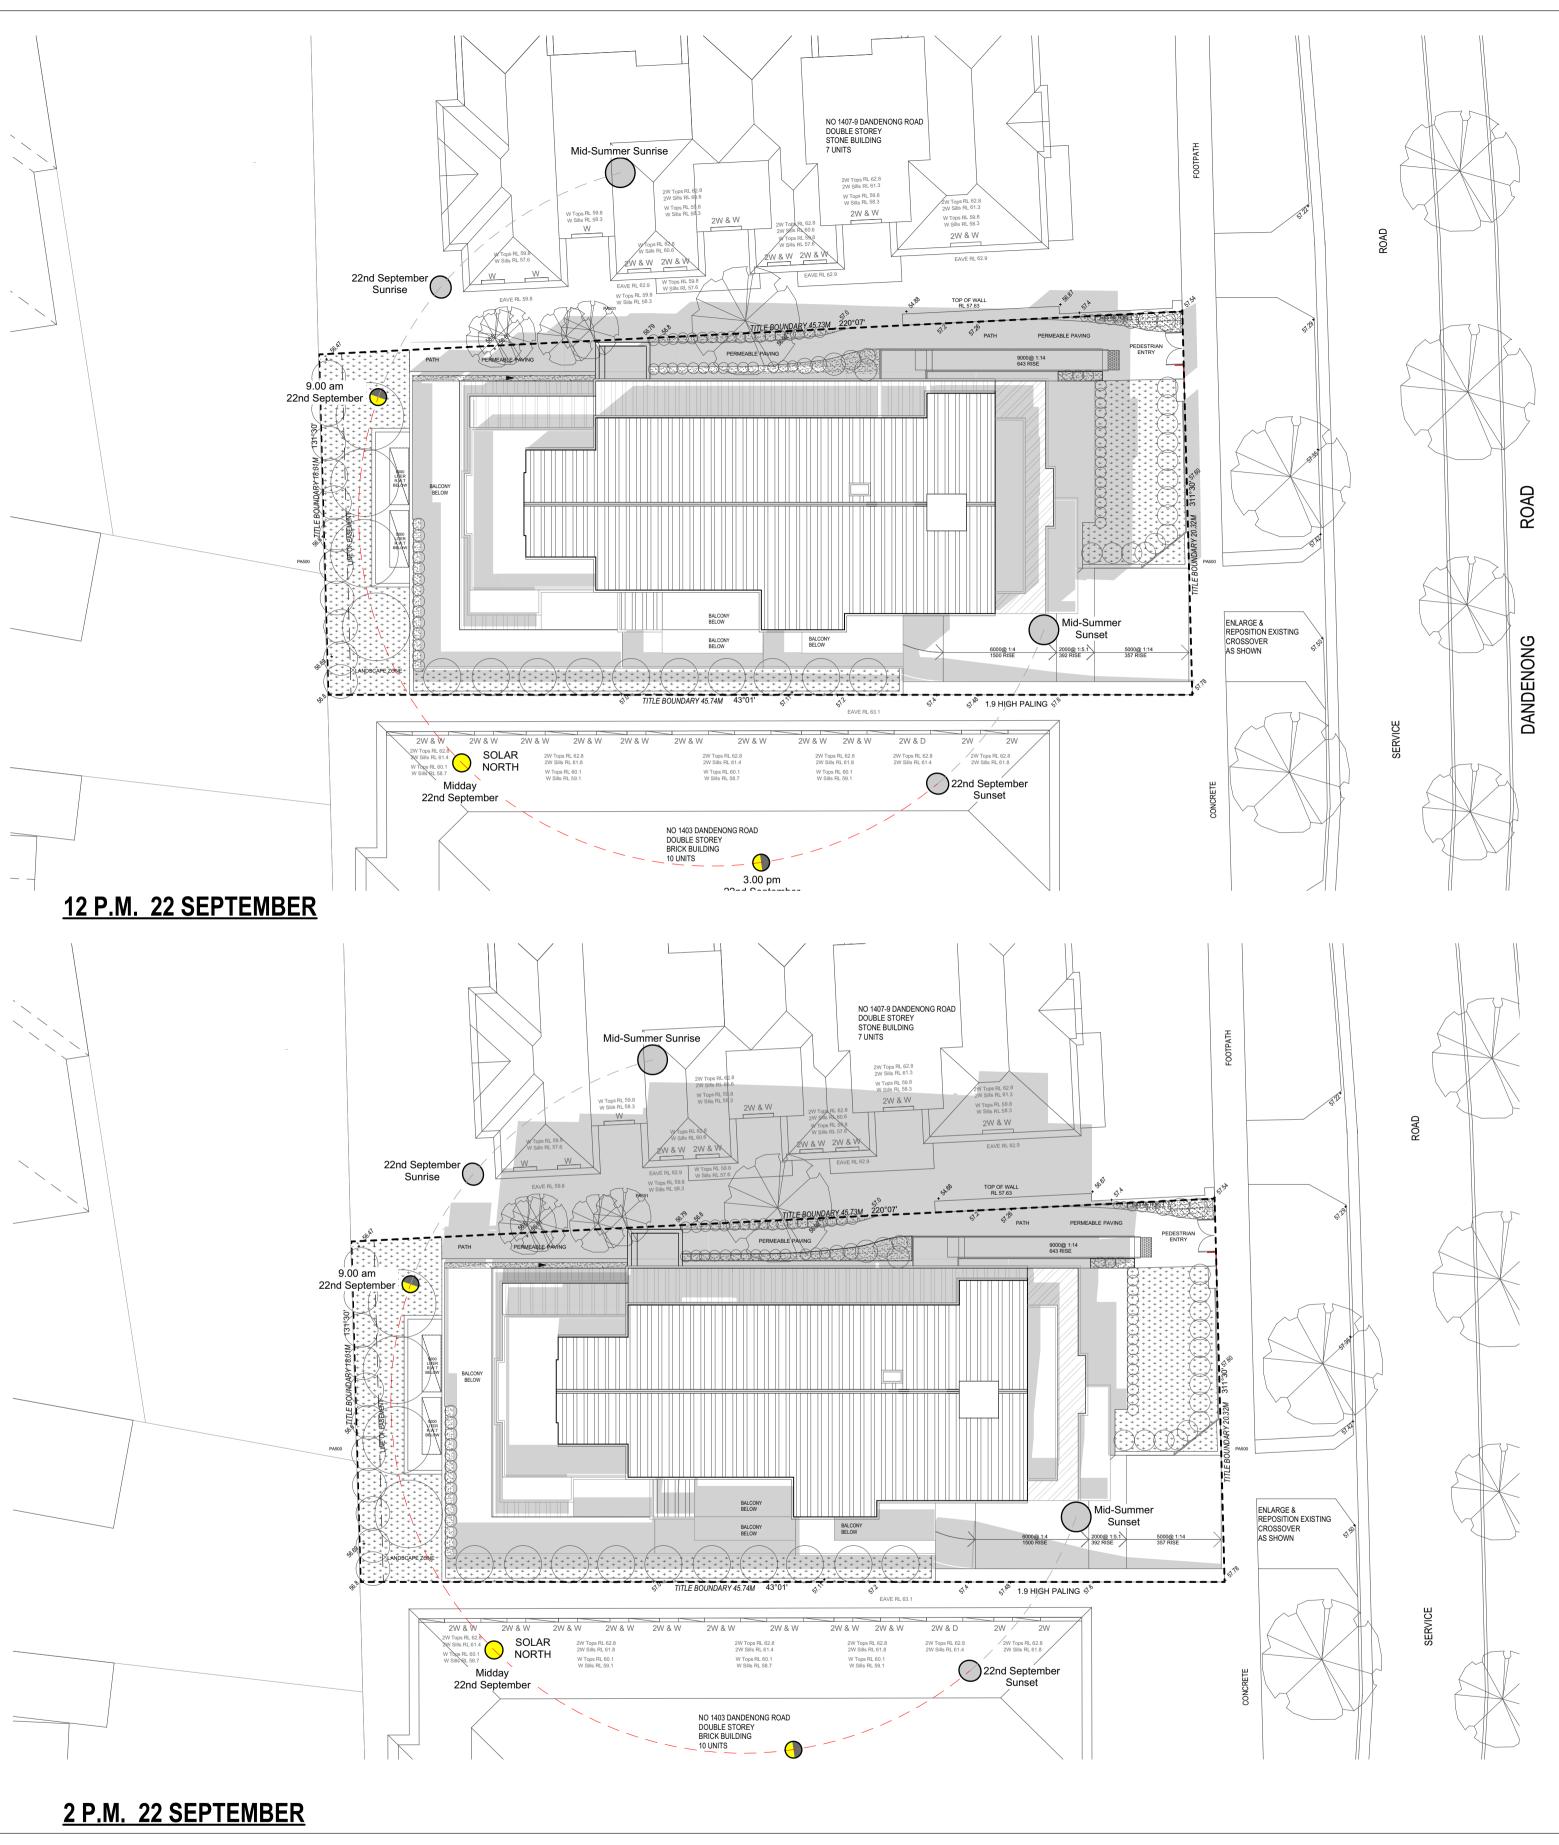
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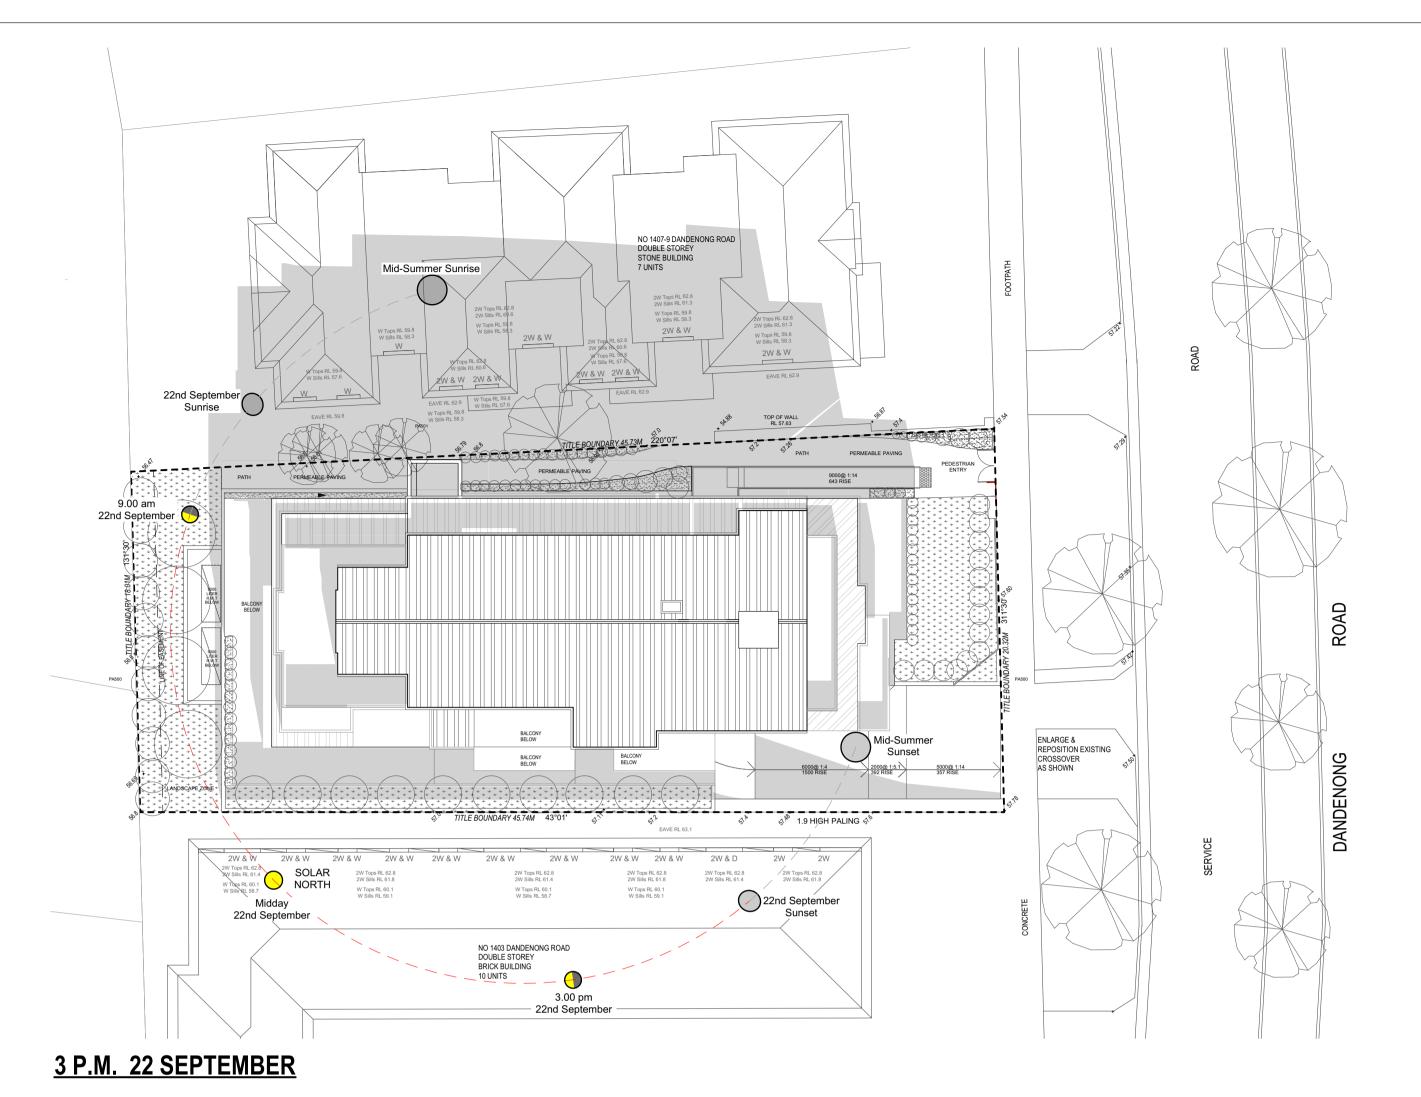
1405 Dandenong Road Malvern East

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Drawing Title			
Shadow	Diagrar	m	Project North
Print Date	7/05/2021	Page No.	Revision
Project Date	23/04/2018	PA-205	#
Drawn by	YD/DM		
Checked by	JH	Scale 1:200@A1, 1:500 @ A3	

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Suite 6, 83-87 Main St. Greensborough Vic 3088 JOHN HENRY Australia ph - 03 9432 0648 ARCHITECTS Fax- 03 9432 0649

No.	Description	Date
#	Issued to client	03/03/2021
#	Submitted to Council	22/03/2021
#	Submitted to Council	27/04/2021
#	Submitted to Council	7/05/2021

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1405 Dandenong Road Malvern East

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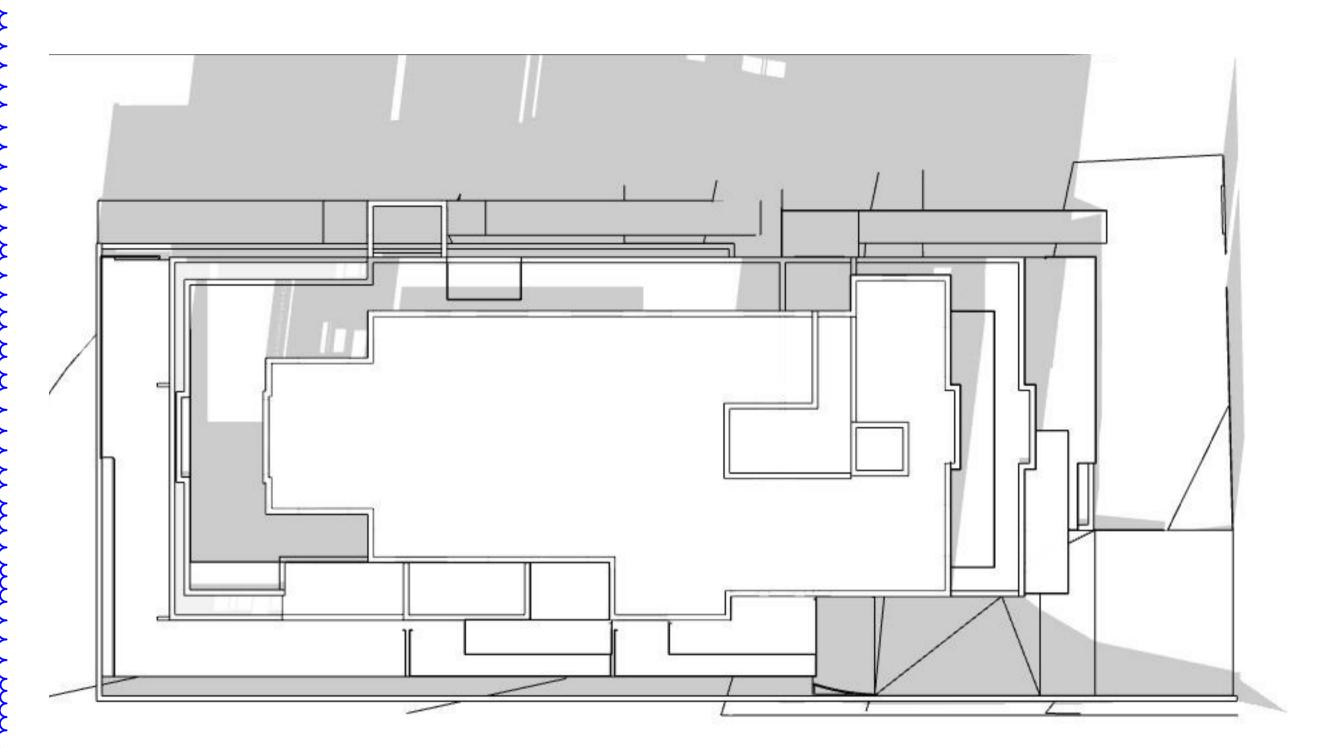
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Print Date	7/05/2021	Page No.	Project North Revision
Project Date	23/04/2018	PA-206	#
Drawn by	YD/DM		
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<u>3PM. 21 JUNE</u>

REV 1


-New shadow diagrams added to show communal open space receiving a minimum of two hours of sunlight as per Standard B37



<u>12PM. 21 JUNE</u>

<u>9AM. 21 JUNE</u>

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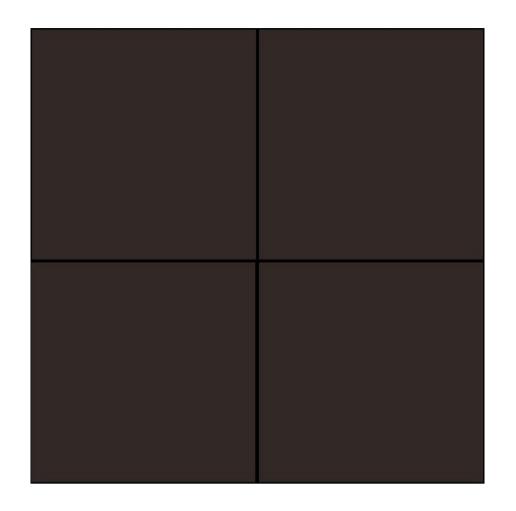
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Project Title
1405 Dandenong Road
Malvern East
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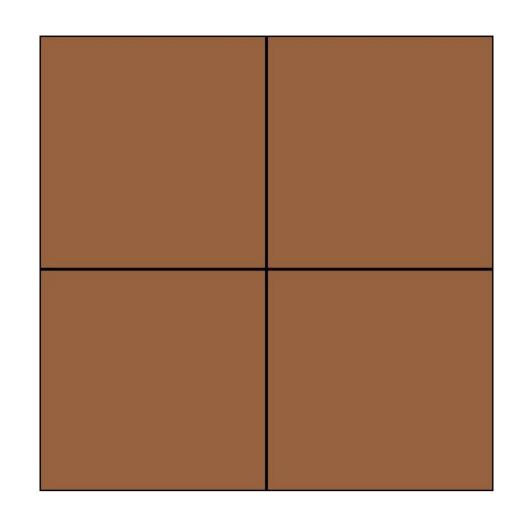
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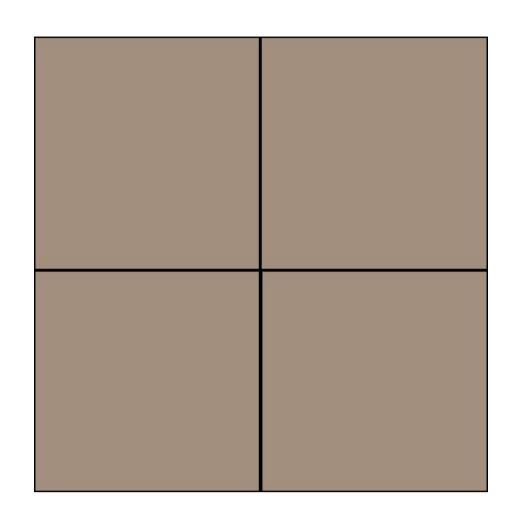
CLADDING

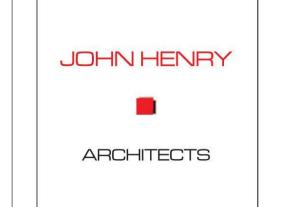

C01. Fibercement Matrix Cladding with 'CHOCOLATE CAKE' Dulux Paint




C02. Fibercement Matrix Cladding with 'AMBIT' Dulux Paint



C03. Fibercement Matrix Cladding with 'ZINC BLEND' Dulux Paint



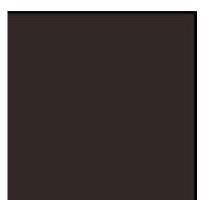

P01. Dulux 'CHOCOLATE CAKE'



P02. Dulux 'AMBIT'

BALLUSTRADE



 \sim G01. Bronze Frosted Glass (no more than 25% transparency with visual light transmittance (VLT) \geq 70%.)

minimum.

REV 2

-ESD annotation has been added



G02. Clear Glass

Construction Materials:




Timber framing for all floor plans except basement



Concrete wall and floor systems for basement floor

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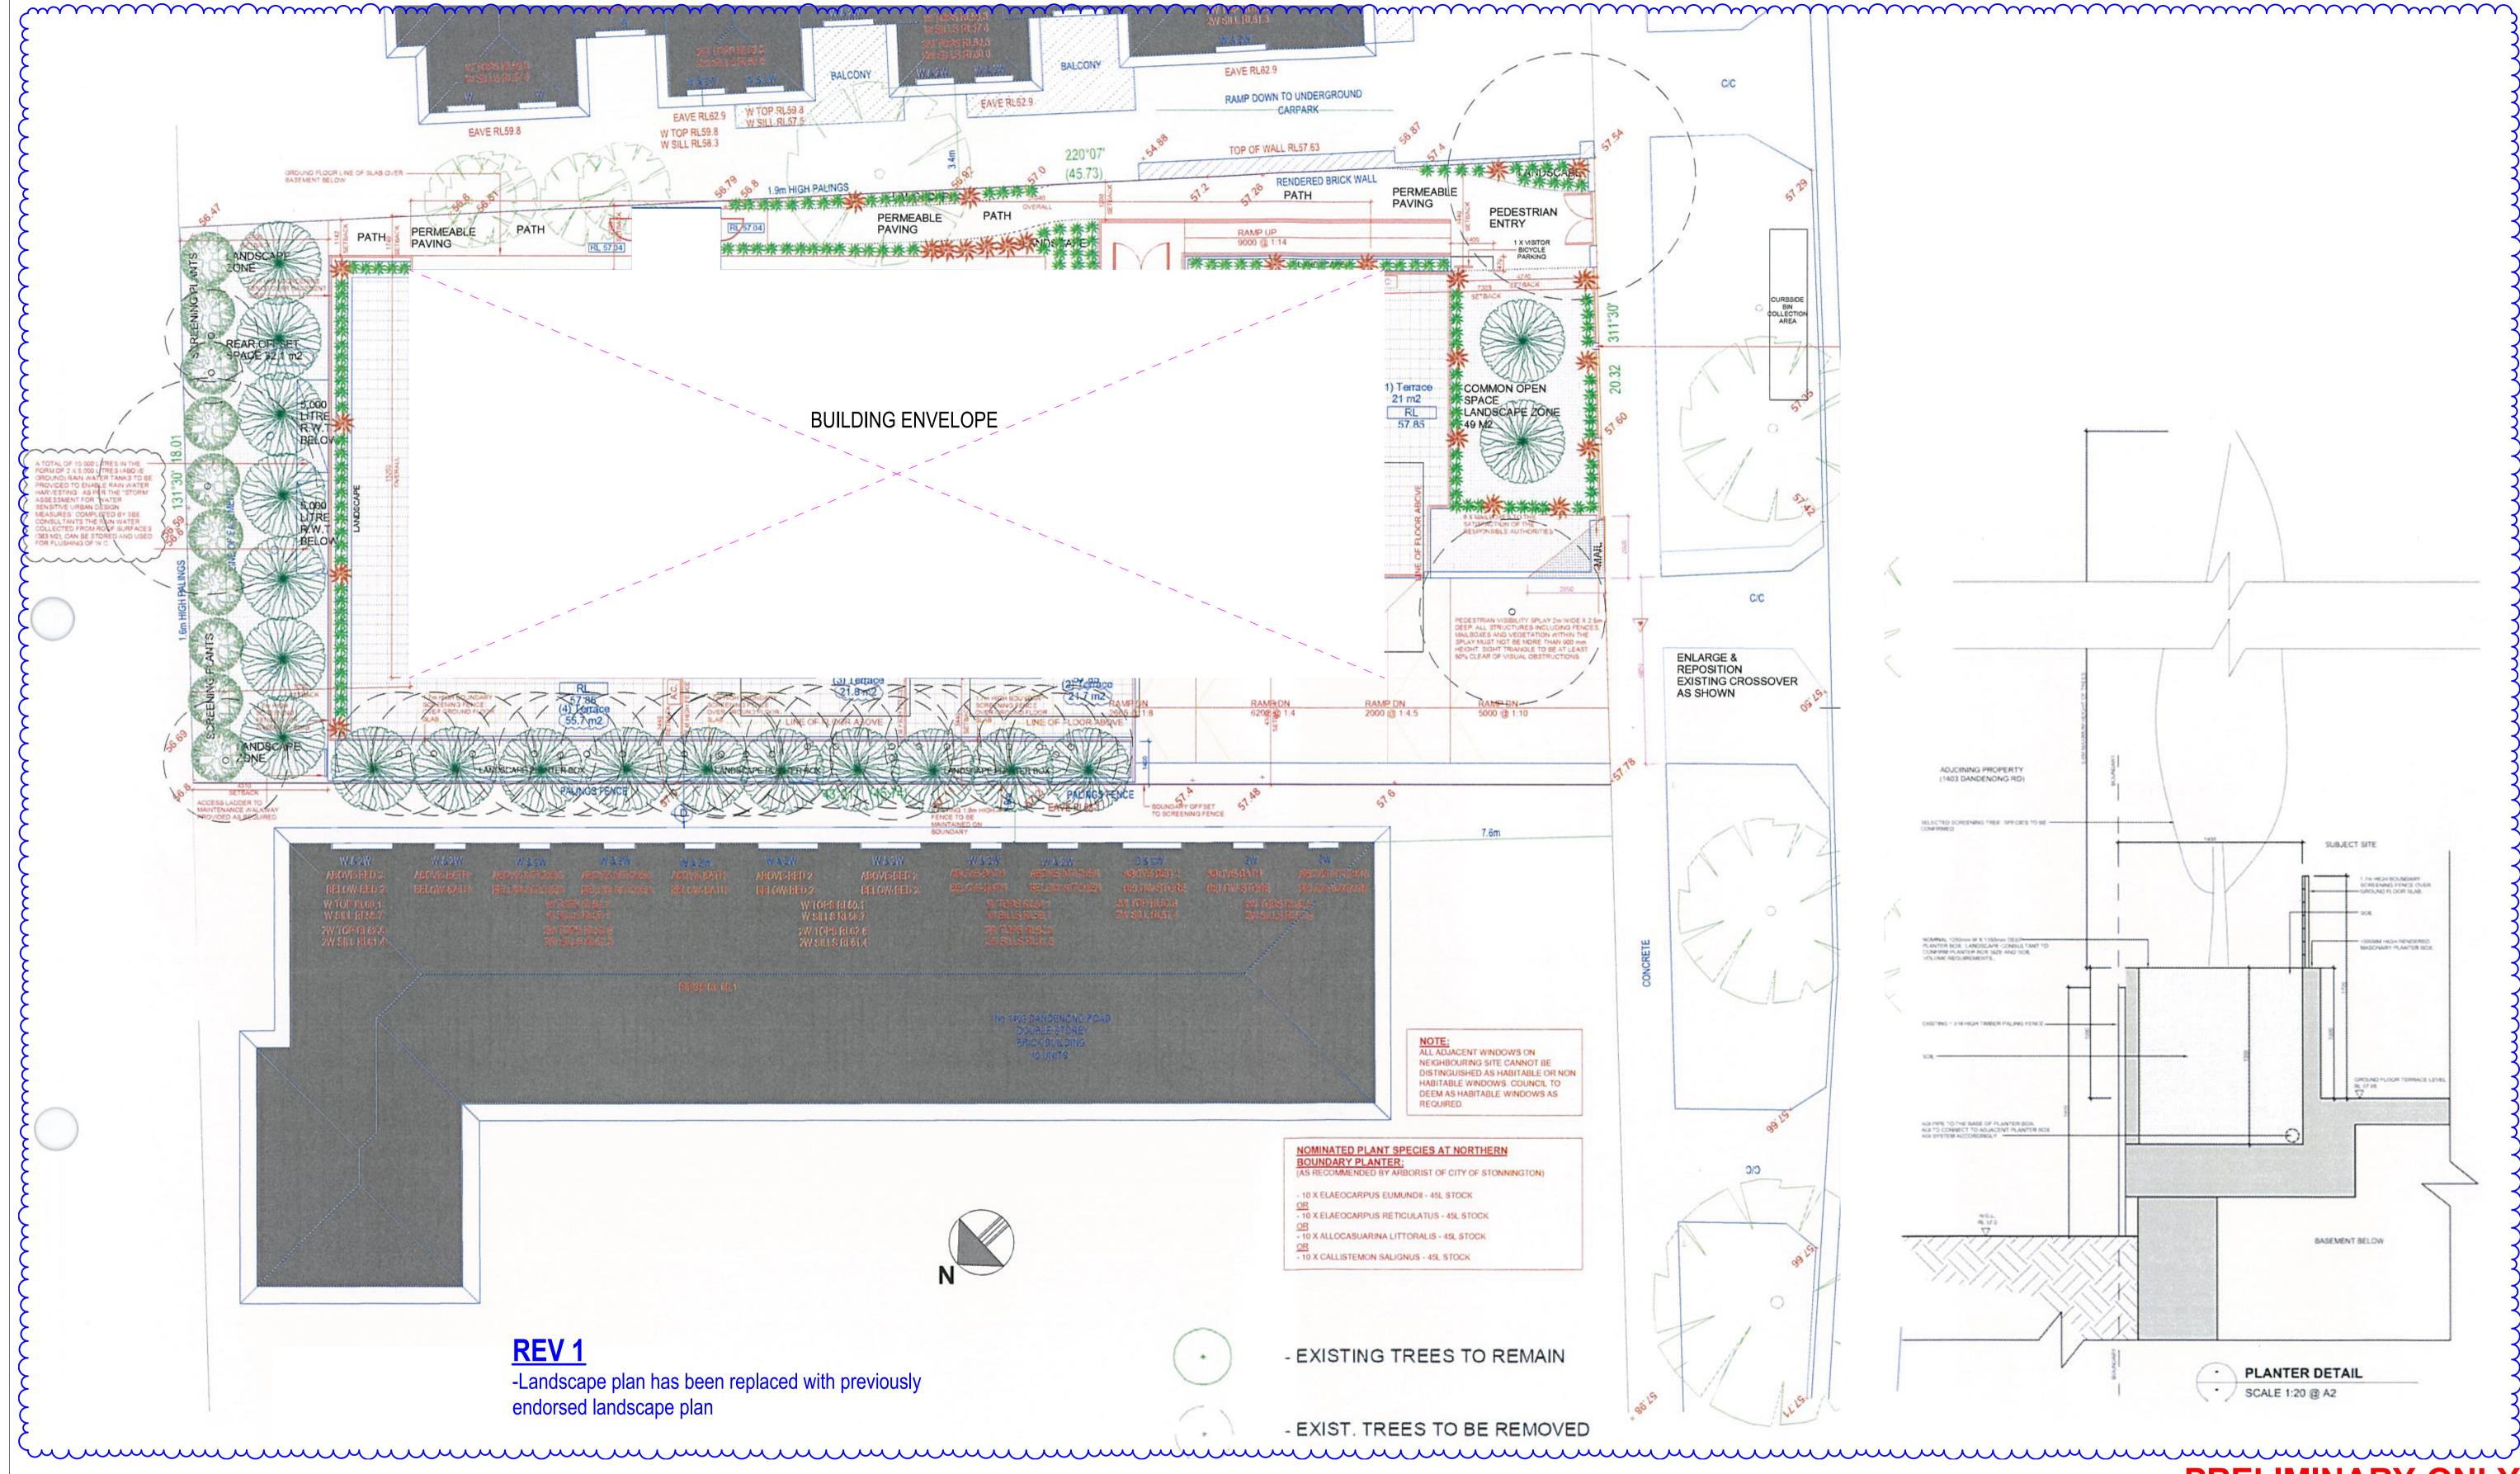


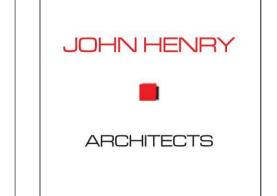No.	Description	Date
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1	Submitted to Council	27/04/2021
1	Submitted to Council	7/05/2021
1	Issued to energy consultant	18/05/2021
2	Issued to Council	13/07/2021

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Project Title	Drawing Title		
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Malvern East			
	Print Date	13/07/2021	Page No.
	Project Date	23/04/2018	PA-
	Drawn by	YD/DM	

Malvern East			
	Print Date	13/07/2021	Page No.
	Project Date	23/04/2018	PA-900
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Project Title	
1405 Dandenong Road	
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Drawing Title Landsca	ape Plar	1	Project North
Print Date	7/05/2021	Page No.	Revision
Project Date	23/04/2018	PA-102	1
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-ESD Report anotation has been

ADDITIONAL NOTES


REV 2

	TREE SCHEDULE					
	NO.	BOTANICAL NAME	COMMON NAME	POT SIZE	HEIGHT	COUNT
*	1	Lomanda tanika	Lomandra	150mm	400mm	148
	2	Lavandula Demtata	French lavender	150mm	500mm	24
	3	Eucalyptus pauciflora	Eucalyptus 'Little Snowman'	400mm	2000mm	10
	4	Elaeocarpus Eumundi	Eumundi Quandong	400mm / Planter Box	8000mm	19






Lomanda tanika

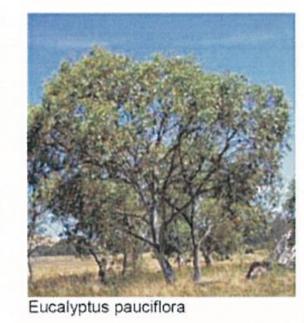




Elaeocarpus Eumundi

HARD SURFACE DETAILS					
	1	Driveway	Concrete as per Engineers Design		
	2	Pathways	Pavers similar to Boral Adobe 400x400 in Latte colour or Similar		
	3	Patios/Balconies	Pavers similar to Boral Stoneworks 400x400 in Limestone colour or similar		
4	4	Pearmeable Paving	Pavers similar to Boral Hydrapave 80mm Thick		

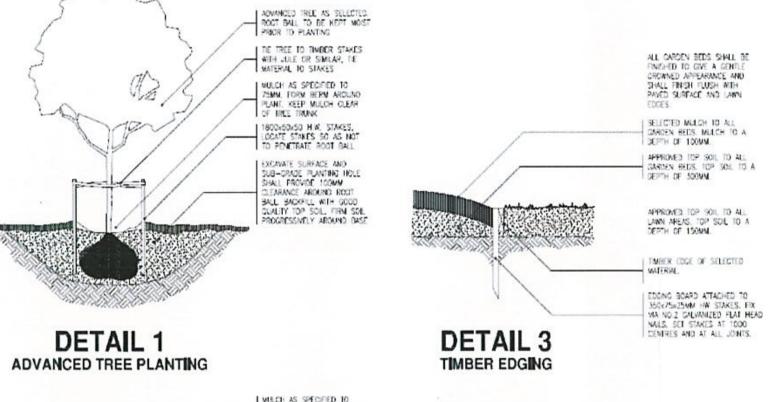

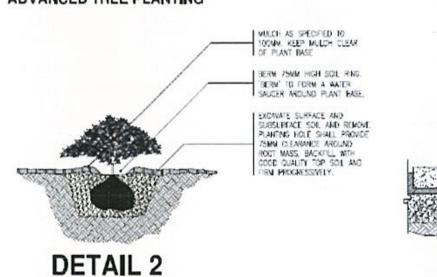

STANDARD PLANTING

DETAIL 4 SELECTED PAVERS

TREE PROTECTION ZONE NOTES

- Water efficient landscaping is required, The tree protection zone (TPZ) is either within in drip line of the tree or at a distance of half the height of the tree from including low water use planting and drip irrigation connected to rainwater tanks the trunk, whichever distance is greater.

An immovable protective fence must be constructed at this distance from the tree trunk and this area is to be kept free from the vehicles, equipments, tools, side buildings, building materials etc.

Tree trunks previously standing in shade should be shaded the side facing the sun, if exposed during the construction.

The base of the tree to be retained is to be decompacted and provided with a 75mm layer of organic mulch and a dtrip watering system for the duration pf constructions.

The following activities are not permitted within in a TPZ Alteration of existing soil level;

Storage of equipments or msaterials;

TMBER EDGE OF SELECTED

FINE CRUSHED ROCK BASE TOOMM DEPTH COMPACTED AND SET ABOVE STABLIZED BASE, PAND SURFACES TO DEAR AT 2% AWAY FROM BURDING TOWARD LAWN

-1 SAND BED

SIND IN JON'S

Storage or dispersal of fuel, oil or chemicals;

A local law permit must be obtained before any earth work o pruning of more than 1/3 of outer canopy of any tree with trur circumference of 110cm or greater at ground level.

Any constructions or excavation that involves encroachment within any tree protection zone must first be approved by a qualified arborist and local authority. Alternative construction methods must be employed such as screw pile footings. Stripe footing must not be used. Paving within the CRZ of all trees must be porous in nature. Excavation must be undertaken by hand after root inspection and pruning by a drip line and CRZ of any existing trees on site or adjoining properties.

NOTES

- Contractor to verify location of all underground services prior to commencement of work.
- Plant selection shall be as per the plant schedule in locations shown on the drawing. All plants are to be true to species and the best of their respective kinds. Plants are to have well developed root systems and shall be free of pests
- and disease. Water plants well before and after planting. Spray all areas shown on the drawings as garden bed and Lawn with an approved non -residual contract herbiside(Glyphosate) following manufacturers specification. The herbiside shall be dyed red ti identify exposed areas. Leave sprayed areas for a period of 10 days prior to being worked. Respray and
- weed still alive after 10 days. Determine PH of soil using PH kit available at most nurseries. PH should be slightly acidie to neutral -PH - 5.5 to 7.0. if PH is outside of this range contact your local nursery to obtain advice on how to improve the PH level. Some plants tolerate high or low PH level.
- If soil is mainly clay based, add gypsum to aid in breaking up the soil at the rate of 1.5kg/m2 to lawn areas and 2kg/ m2 for garden bed areas. Install sub-surface draingewhich discharge to strom
- water or soakage pits in areas with poor drainage (where moisture -loving plants are not specified). Cultivate soil for garden bed areas to 300mm depth and lawn areas to 100mm depth. Deep rip in areas of harding-panning or compaction.
- Use on-site topsoil where possible and improve with organic material as required. Imported topsoil shall be fertile, farible soil contaning organic matter and free from perennial weeds and their roots, stone or rubble, clods of topsoil and other extraneous
- Spread good quality topsoil containing compost to 100mm depth for garden bed areas and 75mm depth for lawn areas. To improve drainage in clay soils, raise soil level by
- 200mm in garden beds. Spread 75mm compacted depth organic mulch over all garden bed areas. Top of mulch shall be level with
- adjacent surface. Plant shurbs as per detail in holes of the same depth as the root ball and tawice the diameter of the root ball. Water plants prior to and after backfilling. Do not treadin plants.
- Plant root ball in the soil and never in the mulch. Apply fertiliser specific to indvidual plants's requirement. Plants with specialist fertiliser requirements include. Camellia, Azalea, Rhododendron. Protea Family, Citrus, Aquatic Plants, and Daphane. Consult your local
- nursery for advice. Trees should be staked for the first one to two years as
- per detail. All climber will require a wire or trellis climbing frame to
- be attached to adjacent surface.
 - Install timber edging between all lawn areas and garden

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Drawing Title
Landscape Specifications and Details

Print Date	13/07/2021	Page No.	Revision
Project Date	23/04/2018	PA-103	2
Drawn by	YD		
Checked by	JH	Scale 1:100@A1, 1:200 @ A3	