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727-729 Toorak Road, Kooyong

= Objector Property

Date printed: 26/05/2021 Scale: 1:1672





# **TOWN PLANNING APPLICATION**


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# 727-729 TOORAK ROAD, **KOOYONG, VIC**

# PROPOSED MULTI - RESIDENTIAL DEVELOPMENT

# August 2020



## SITE DESCRIPTION

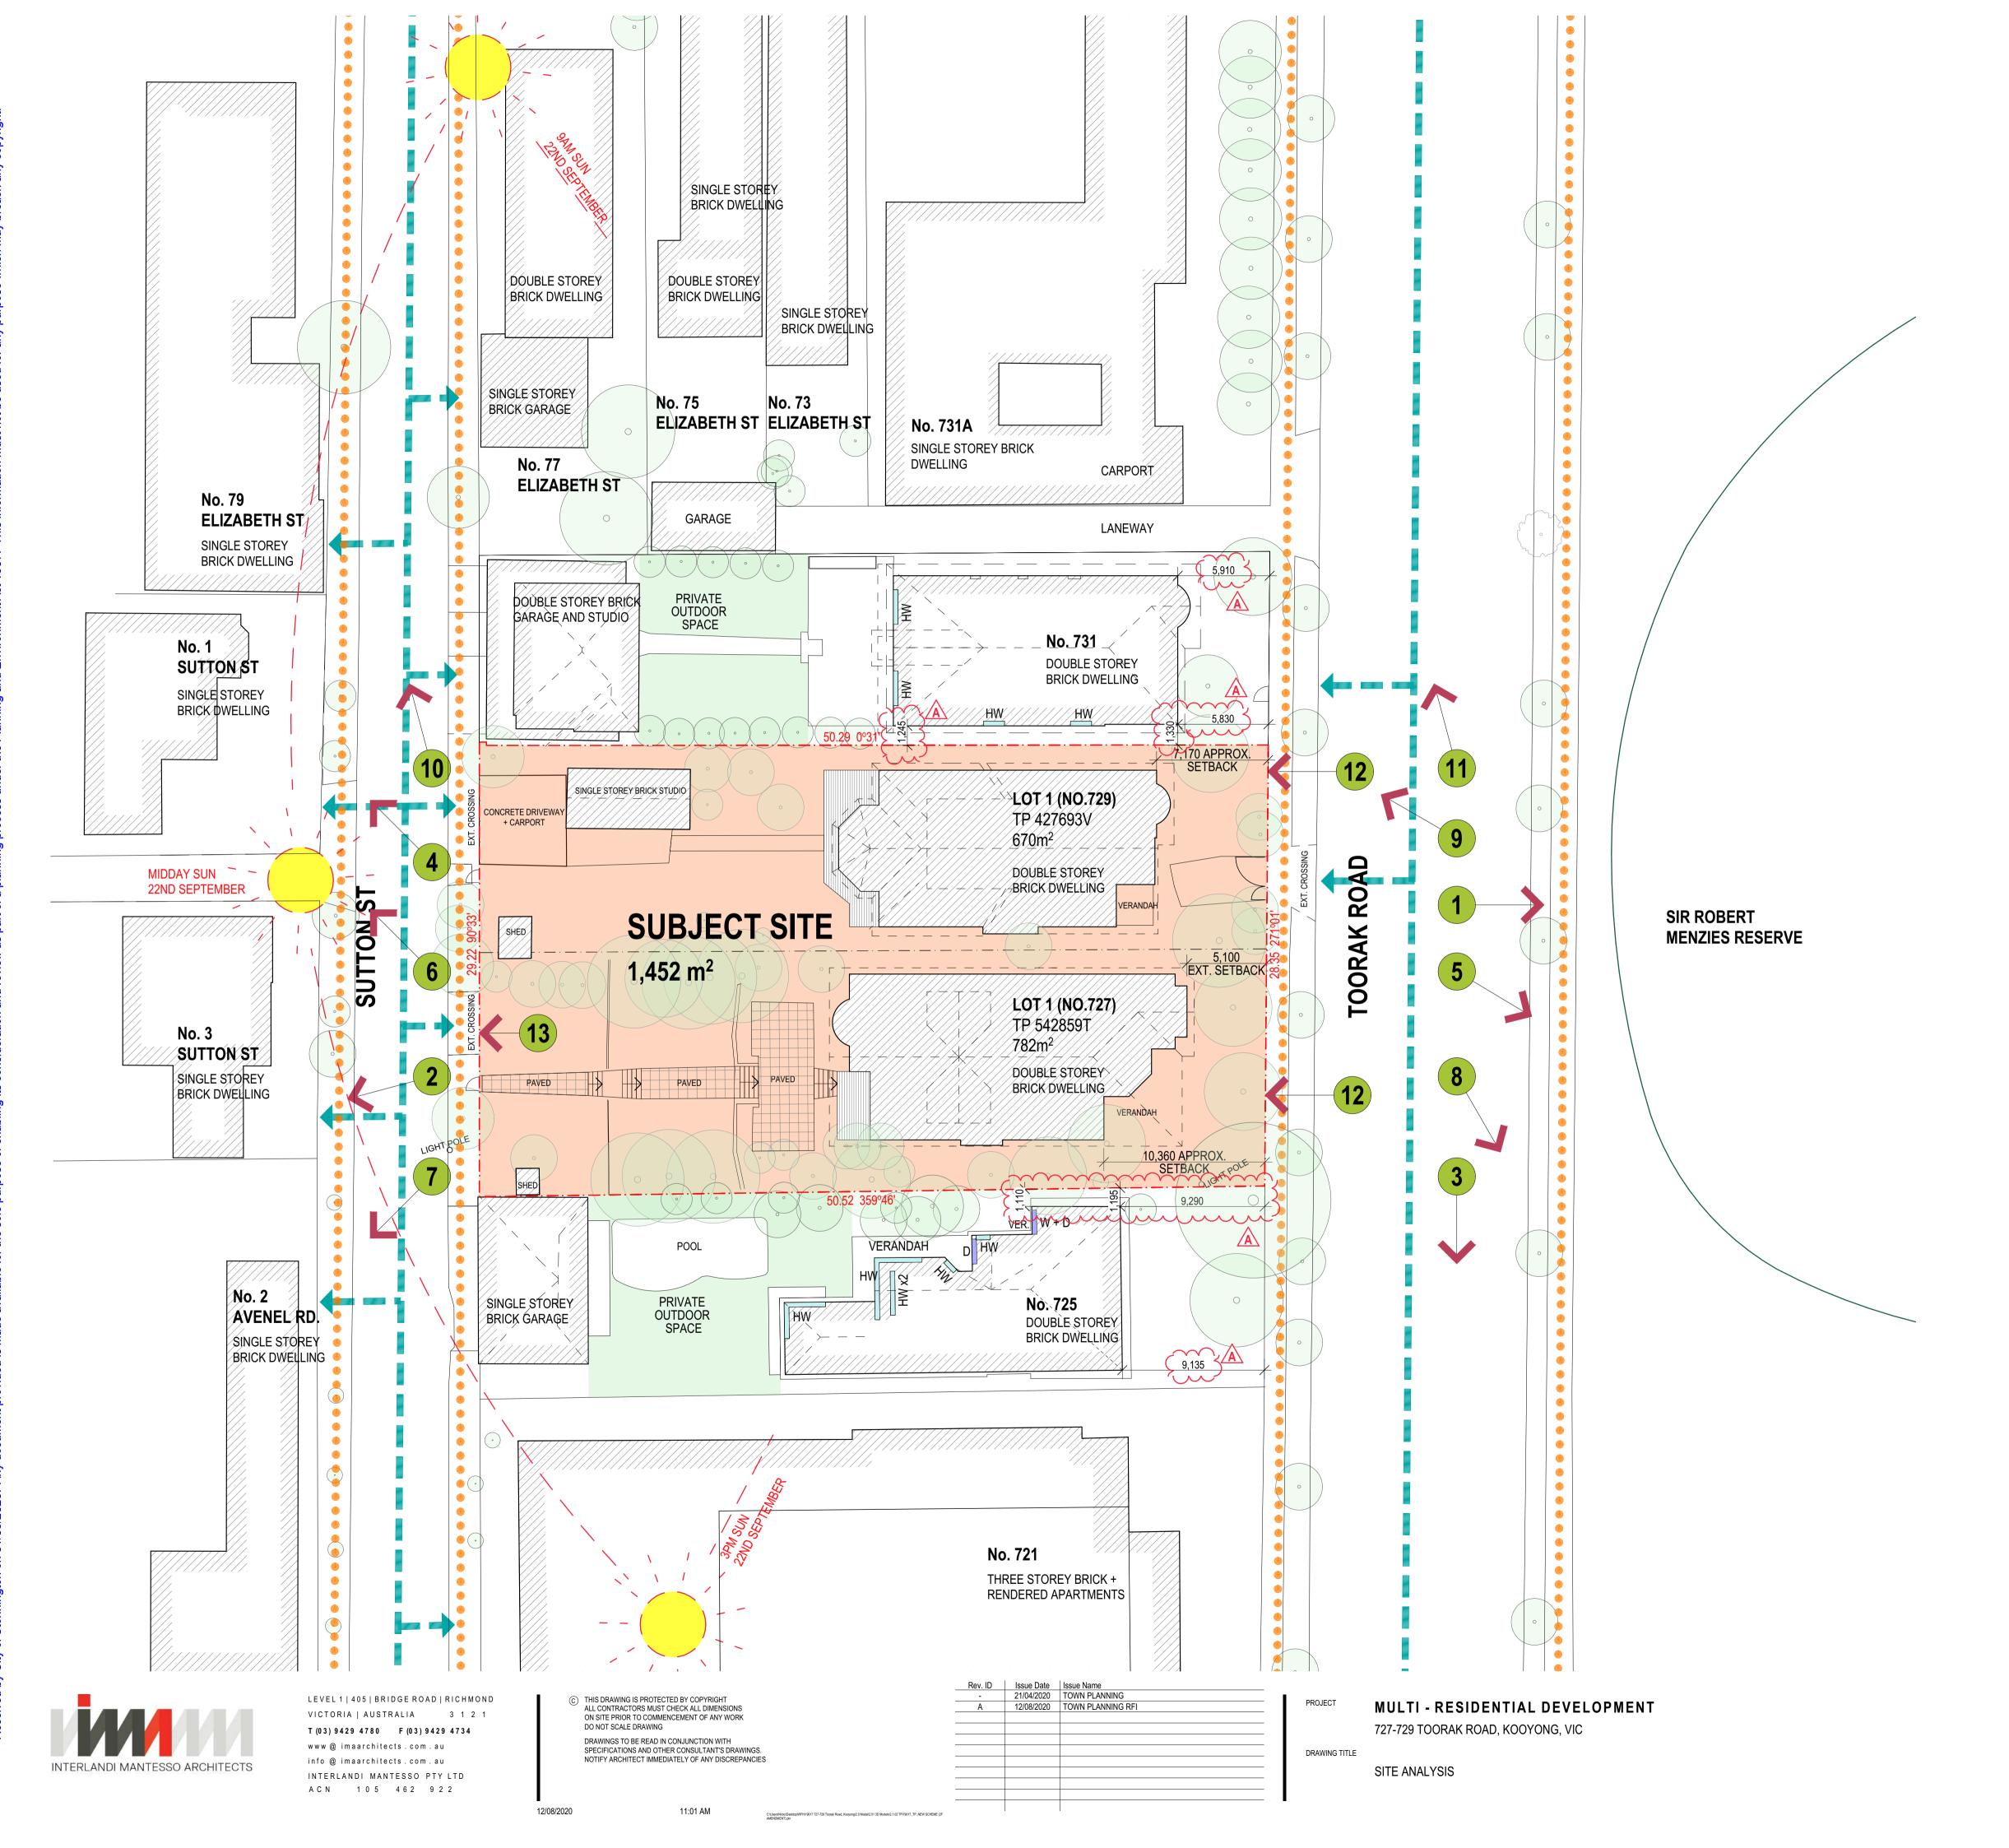THE SUBJECT SITE IS KNOWN AS 727-729 TOORAK ROAD, KOOYONG.

THE SITE IS A COMBINATION OF TWO ROUGHLY RECTANGULAR LOTS WITH DUAL ACCESS FROM SUTTON STREET AND TOORAK ROAD.

OVERALL SITE DIMENSIONS ARE:

- NORTHERN BOUNDARY	28.35m
- SOUTHERN BOUNDARY	29.22m
- WESTERN BOUNDARY	50.52m
- EASTERN BOUNDARY	50.29m

THESE DIMENSIONS ARE OVERALL; REFER TO SITE SURVEY FOR PARTICULARS.

THE LAND IS CURRENTLY OCCUPIED BY TWO DOUBLE STOREY BRICK DWELLINGS. THE SITE AREA IS 1,452m<sup>2</sup>.

THE SITE IS LOCATED IN THE KOOYONG GENERAL RESIDENTIAL ZONE AND HERITAGE OVERLAY, WITH HIGH LEVELS OF AMENITY AND STREET ACTIVITY IN THE IMMEDIATE URBAN CONTEXT.

## LEGEND

EXISTIING BUILDING /STRUCTURE


HABITABLE WINDOW


- WINDOW /DOOR
- EXISTING TREE
- 🗧 🗧 🗧 PEDESTRIAN ACCESS

VEHICULAR ACCESS

1	SIR ROBERT MENZIES RESERVE 51m
---	--------------------------------

- 2 SIR ZELMAN COWEN PARK 700m
- 3 TOORAK ROAD STOP No63 450m
- 4 BIALIK COLLEGE 750m
- 5 LAURISTON GIRLS' SCHOOL 1,8km
- 6 AUBURN SOUTH PRIMARY SHOOL 1,4km
- 7 KOOYONG STATION 1km
- 8 MARGARET'S KINDERGARTEN 450m
- 9 MONASH FREEWAY 600m
- (10) ALIA COLLEGE 1km
- (1) STOCKLAND TOORONGA SHOPPING CENTRE 800m
- 12 EXTISTING 2M HIGH BRICK FENCE ALONG TOORAK RD.
- (13) EXTISTING 2M HIGH TIMBER FENCE

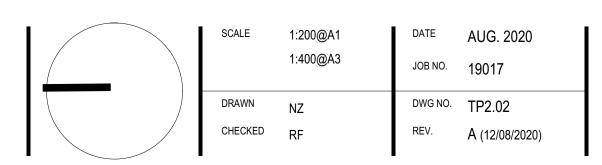

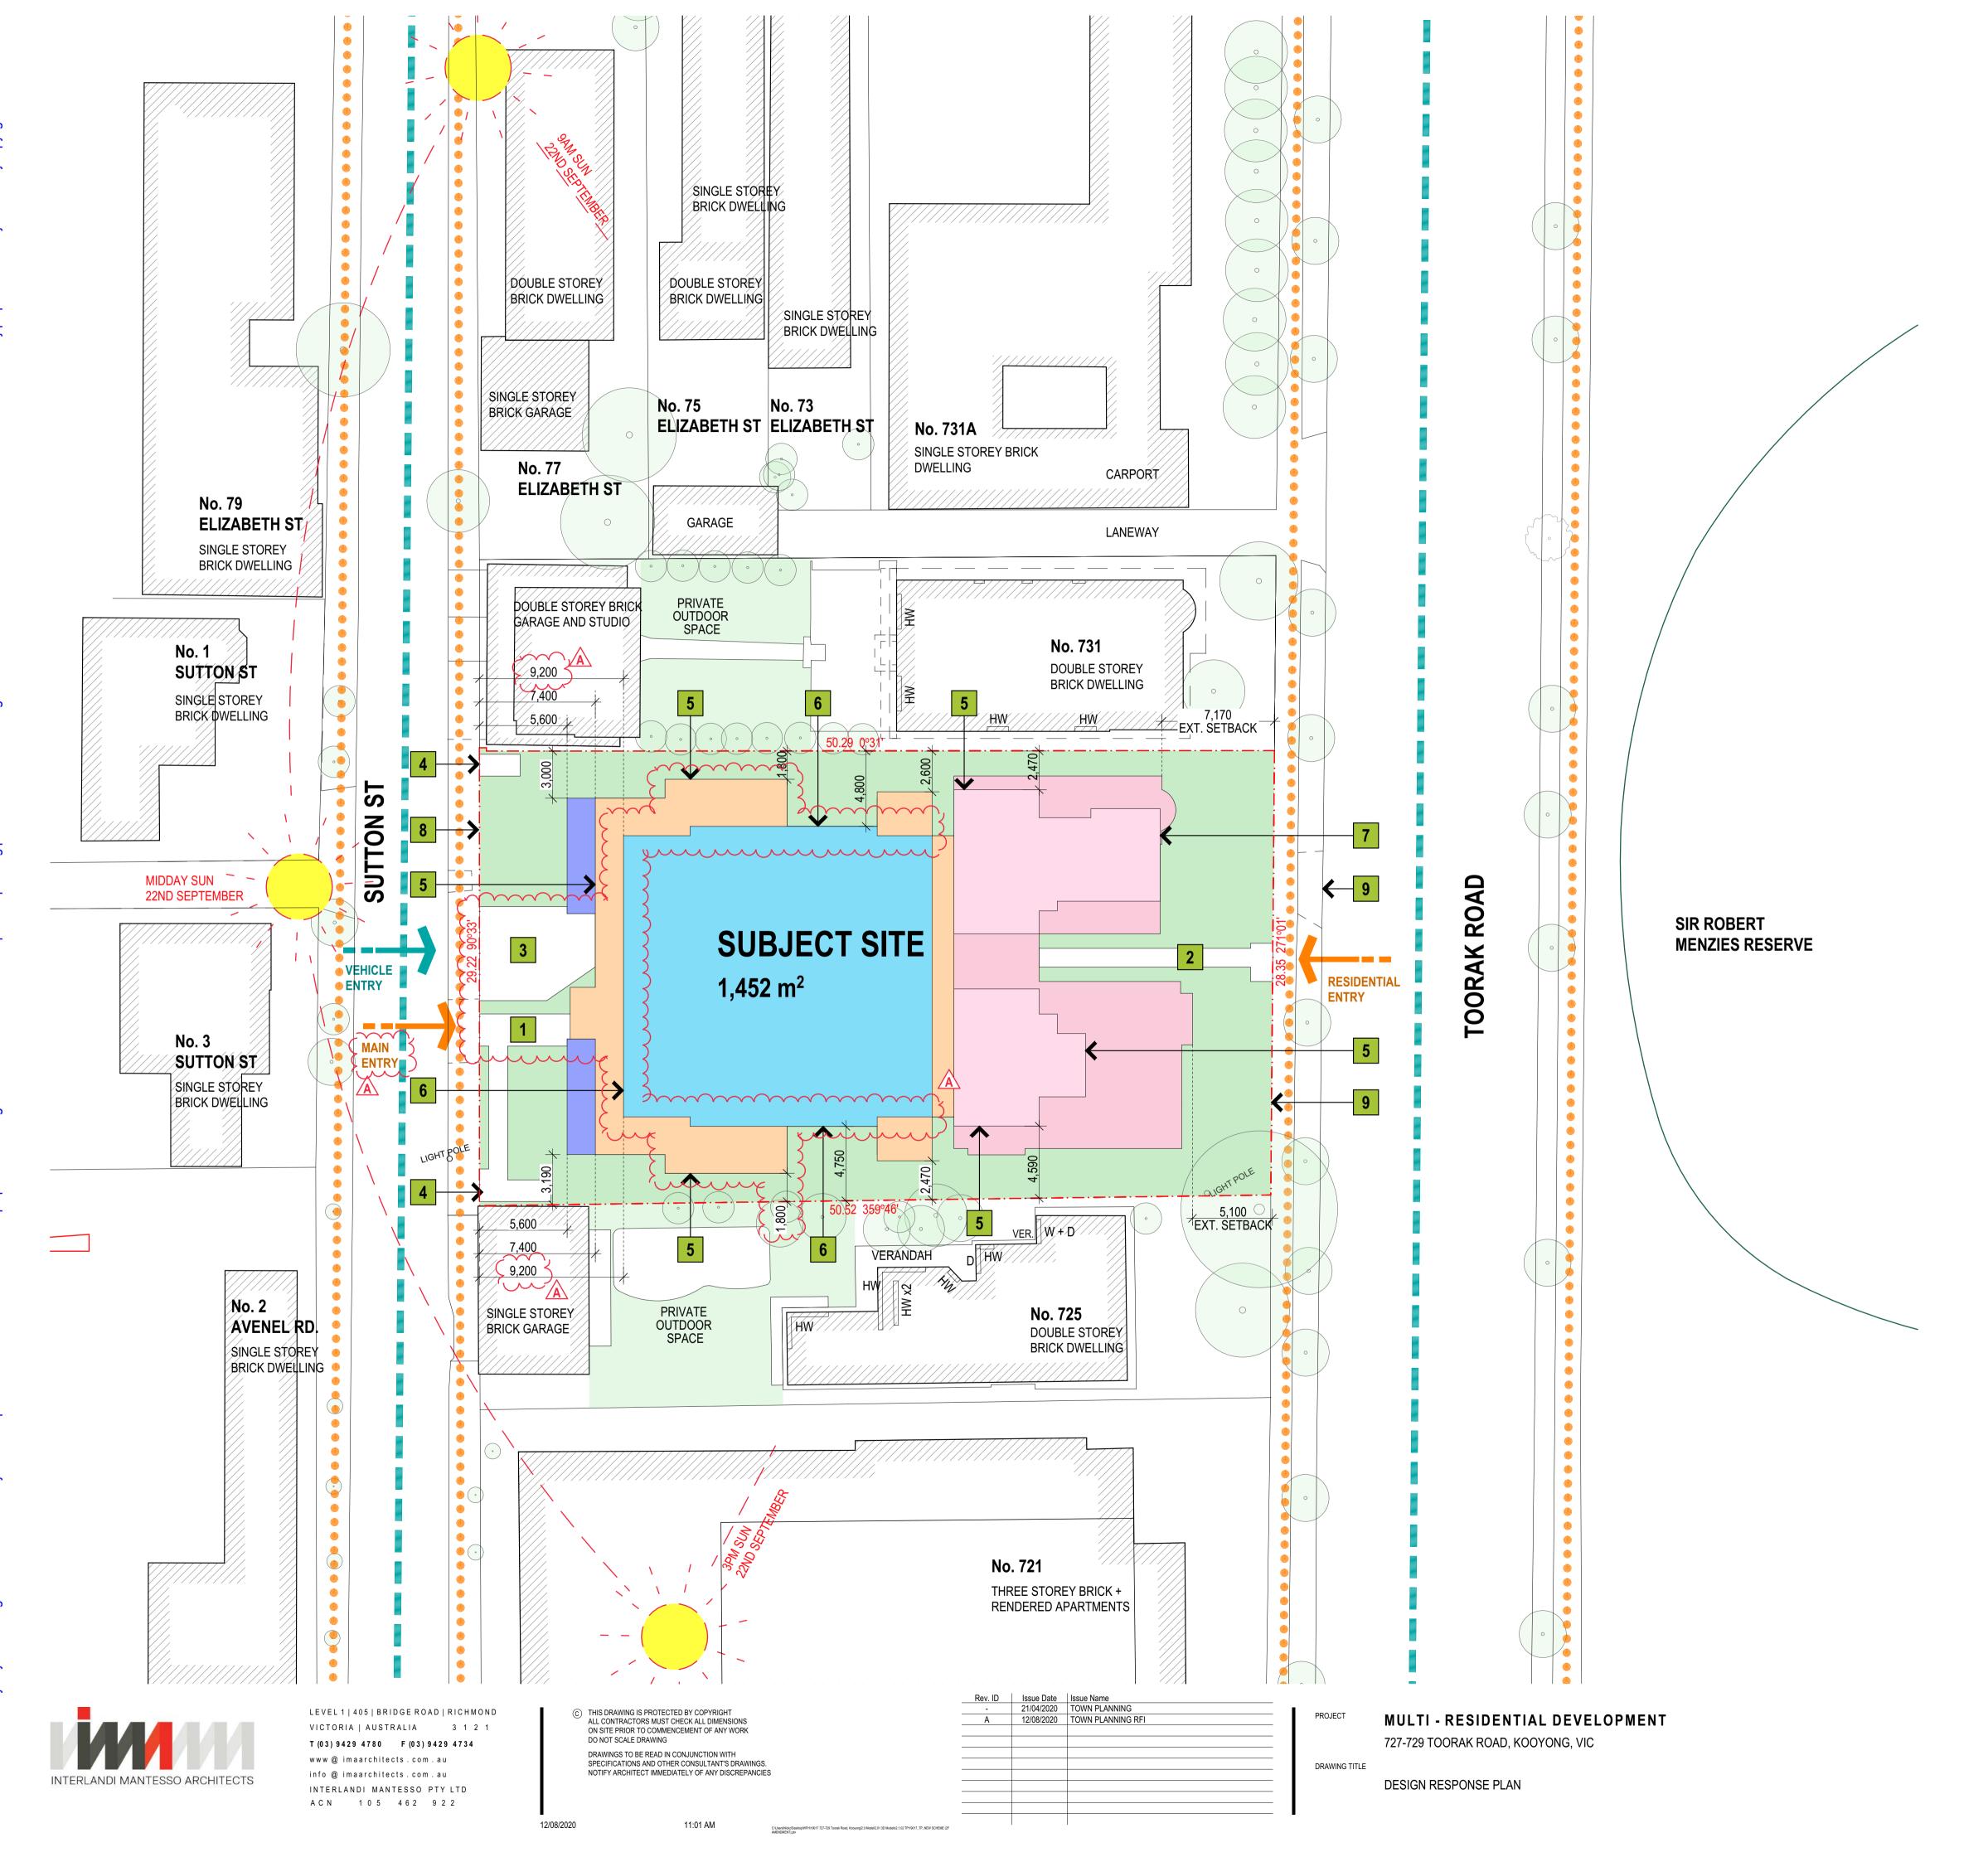


## LEGEND


	HABITABLE WINDOW
	WINDOW
o	EXISTING TREE
	PEDESTRIAN ACCESS
	VEHICULAR ACCESS
1	MAIN ENTRY OFF SUTTON STREET
2	SECONDARY ENTRY OFF TOORAK ROAD
3	VEHICULAR ACCESS VIA. SUTTON STREET
4	PRIVATE ENTRY TO GROUND FLOOR UNITS
5	UPPER LEVEL SETBACK TO REDUCE READING OF BUILT FORM AND LIMIT OVERSHADOWING
6	TOP LEVEL SETBACK AT SUTTON STREET TO REDUCE READING OF BUILT FORM AND LIMIT OVERSHADOWING
7	EXISTING UPPER LEVEL SETBACK TO RETAIN EXISTING FABRIC
8	EXISTING CROSSOVER TO BE REMOVED AND REINSTATED
9	EXISTING CROSSOVER TO BE
10	EXISTING 2M HIGH BRICK FENCE TO BE RETAINED ALONG TOORAK RD.



### NOTE:

EXTERIOR BUILDING OUTLINE ONLY. BALCONY EXCLUDED.

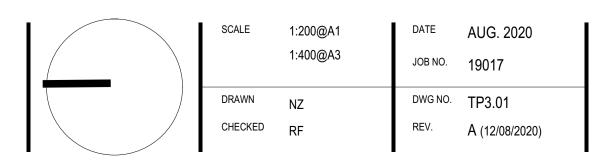

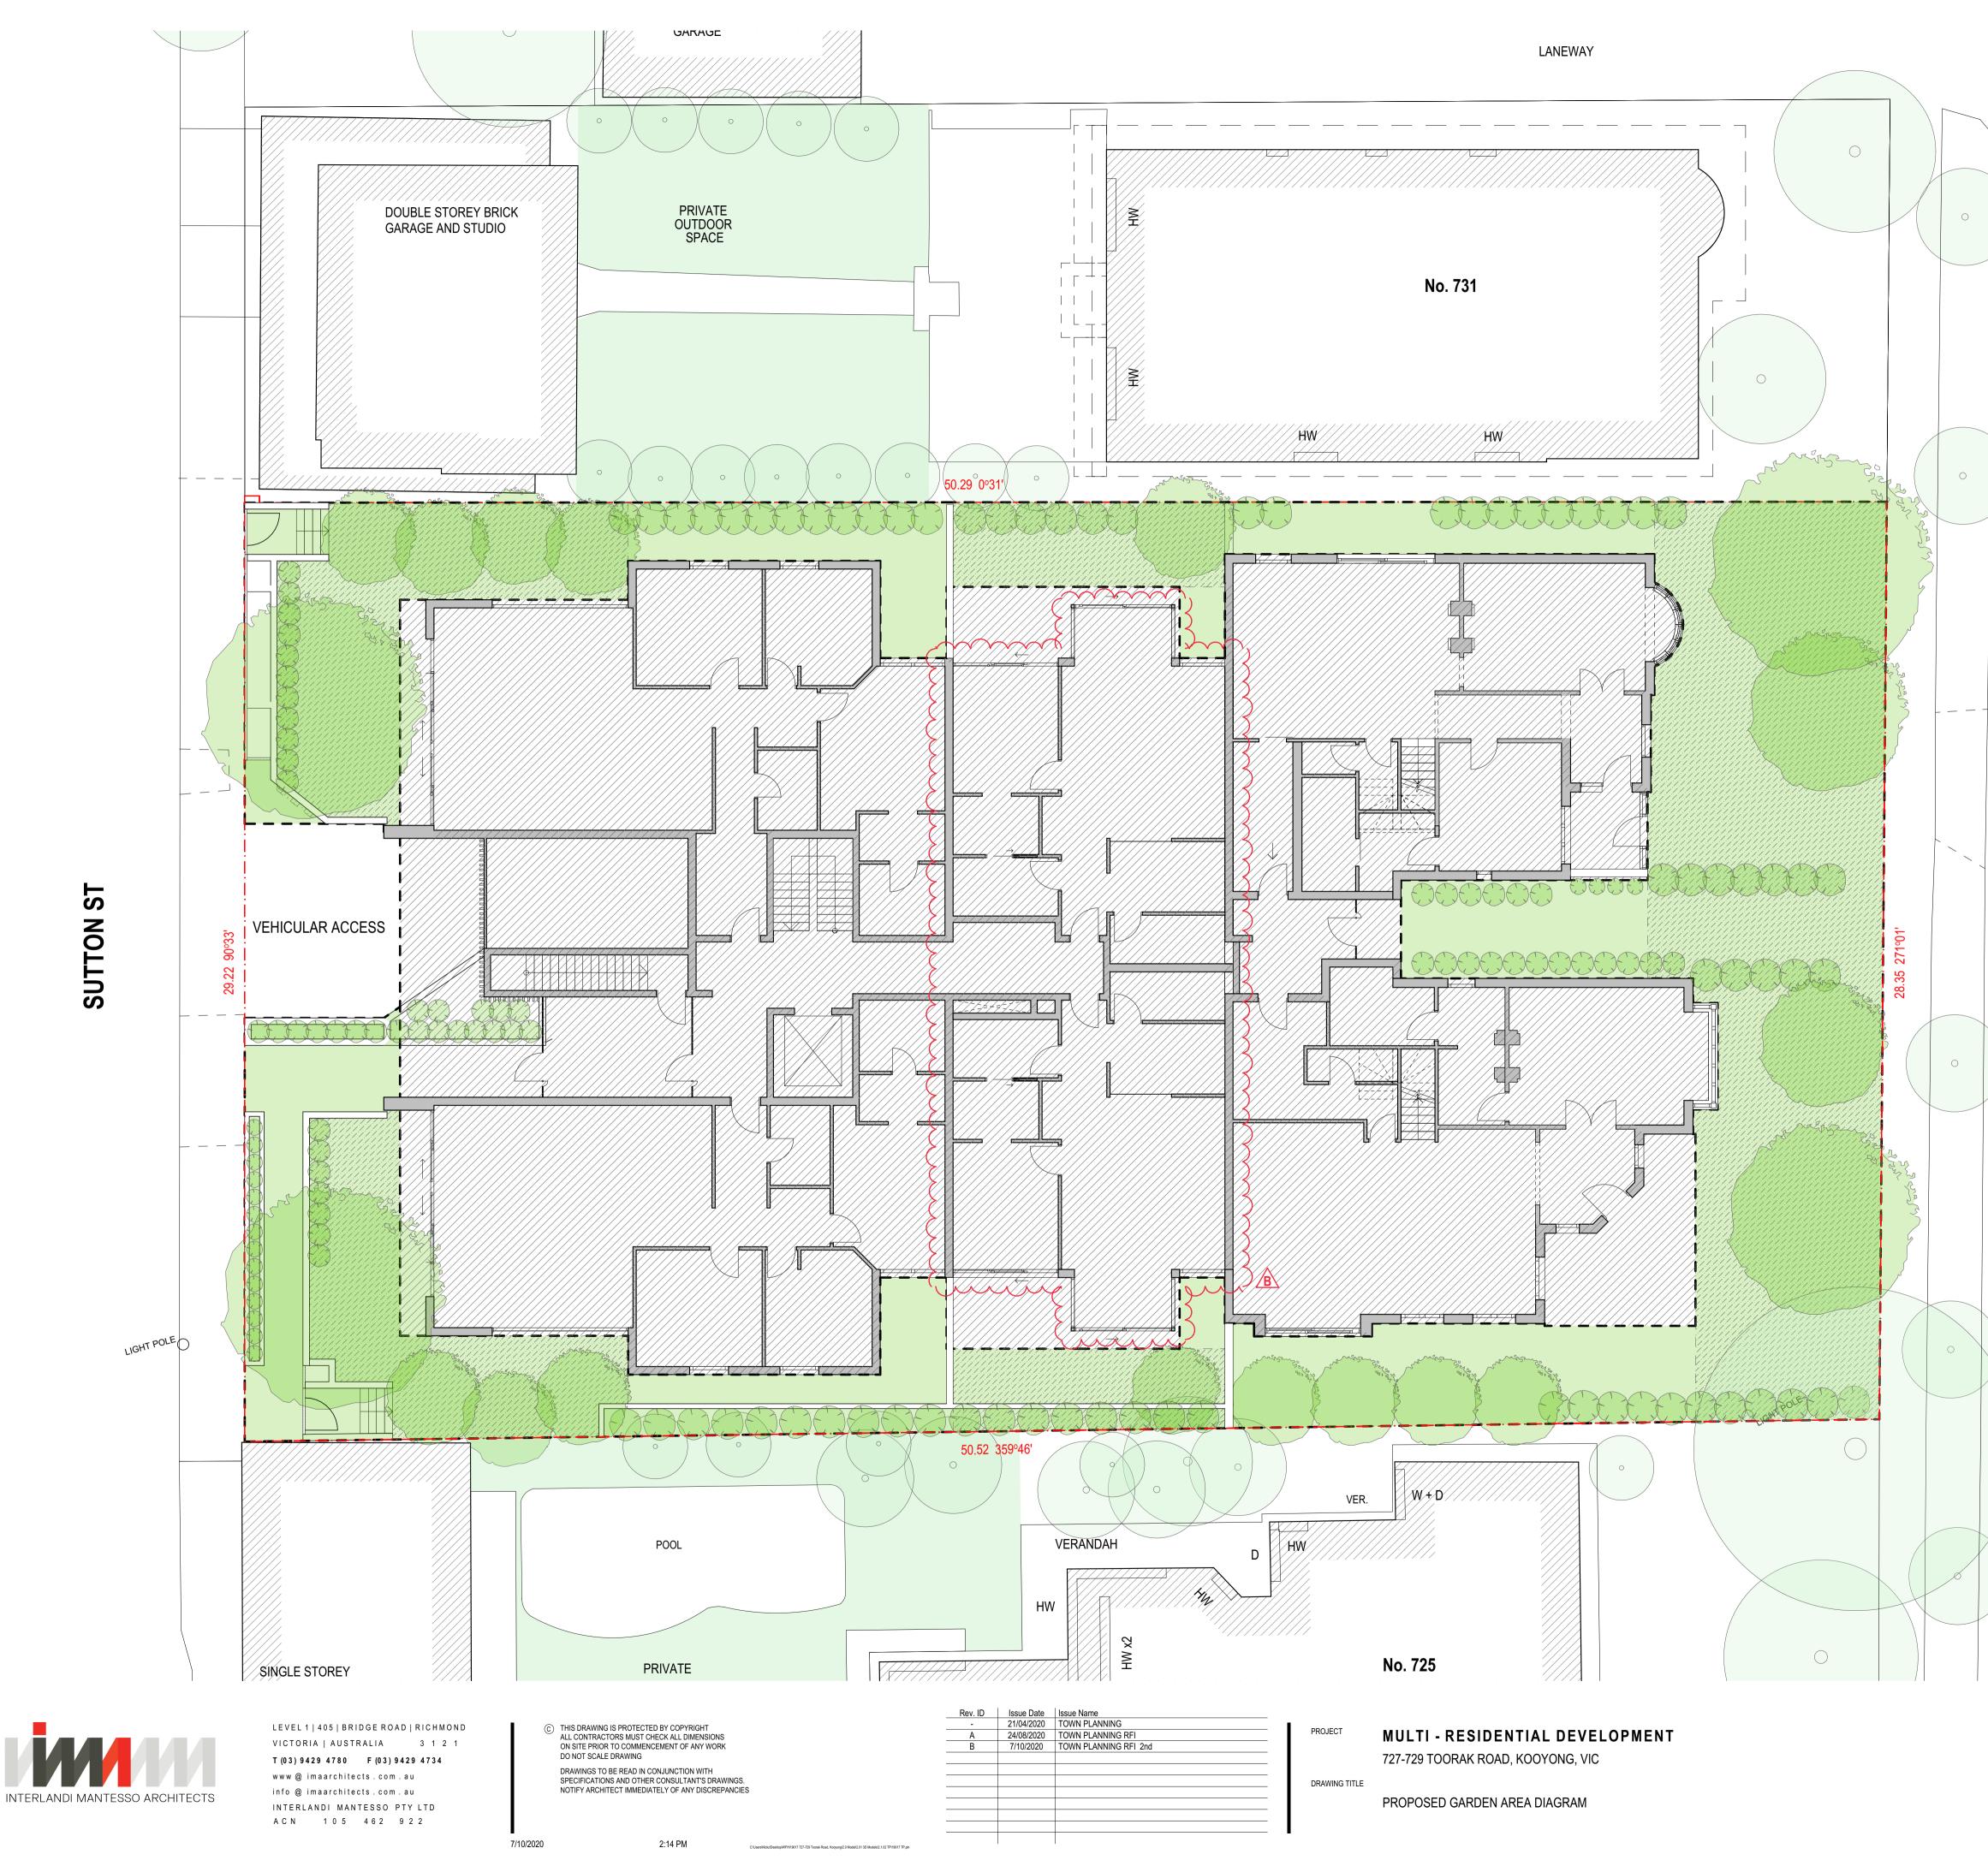

SITE INFORMATION SITE AREA: SITE COVERAGE: PERMEABLE AREA: GARDEN AREA:

1,452m<sup>2</sup> 880.8m<sup>2</sup> (60.7%) 439.8m<sup>2</sup> (30.3%) 521.7m<sup>2</sup> (35.9%) <u>B</u>

## LEGEND

PROPOSED GARDEN AREA



PROPOSED COVER AREA

DEEP SOIL AREA (DEEP SOIL AREA =329.7m<sup>2</sup> (22.7% > 7.5% OF SITE)



EXISTING TREE



PROPOSED NEW TREE




PROPOSED NEW SHRUB


NOTE:

REFER TO LANDSCAPE PLAN FOR DETAILS.




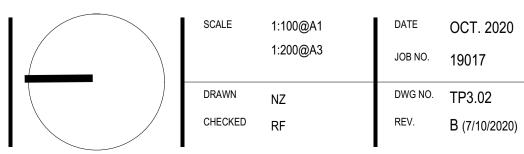

B (7/10/2020)

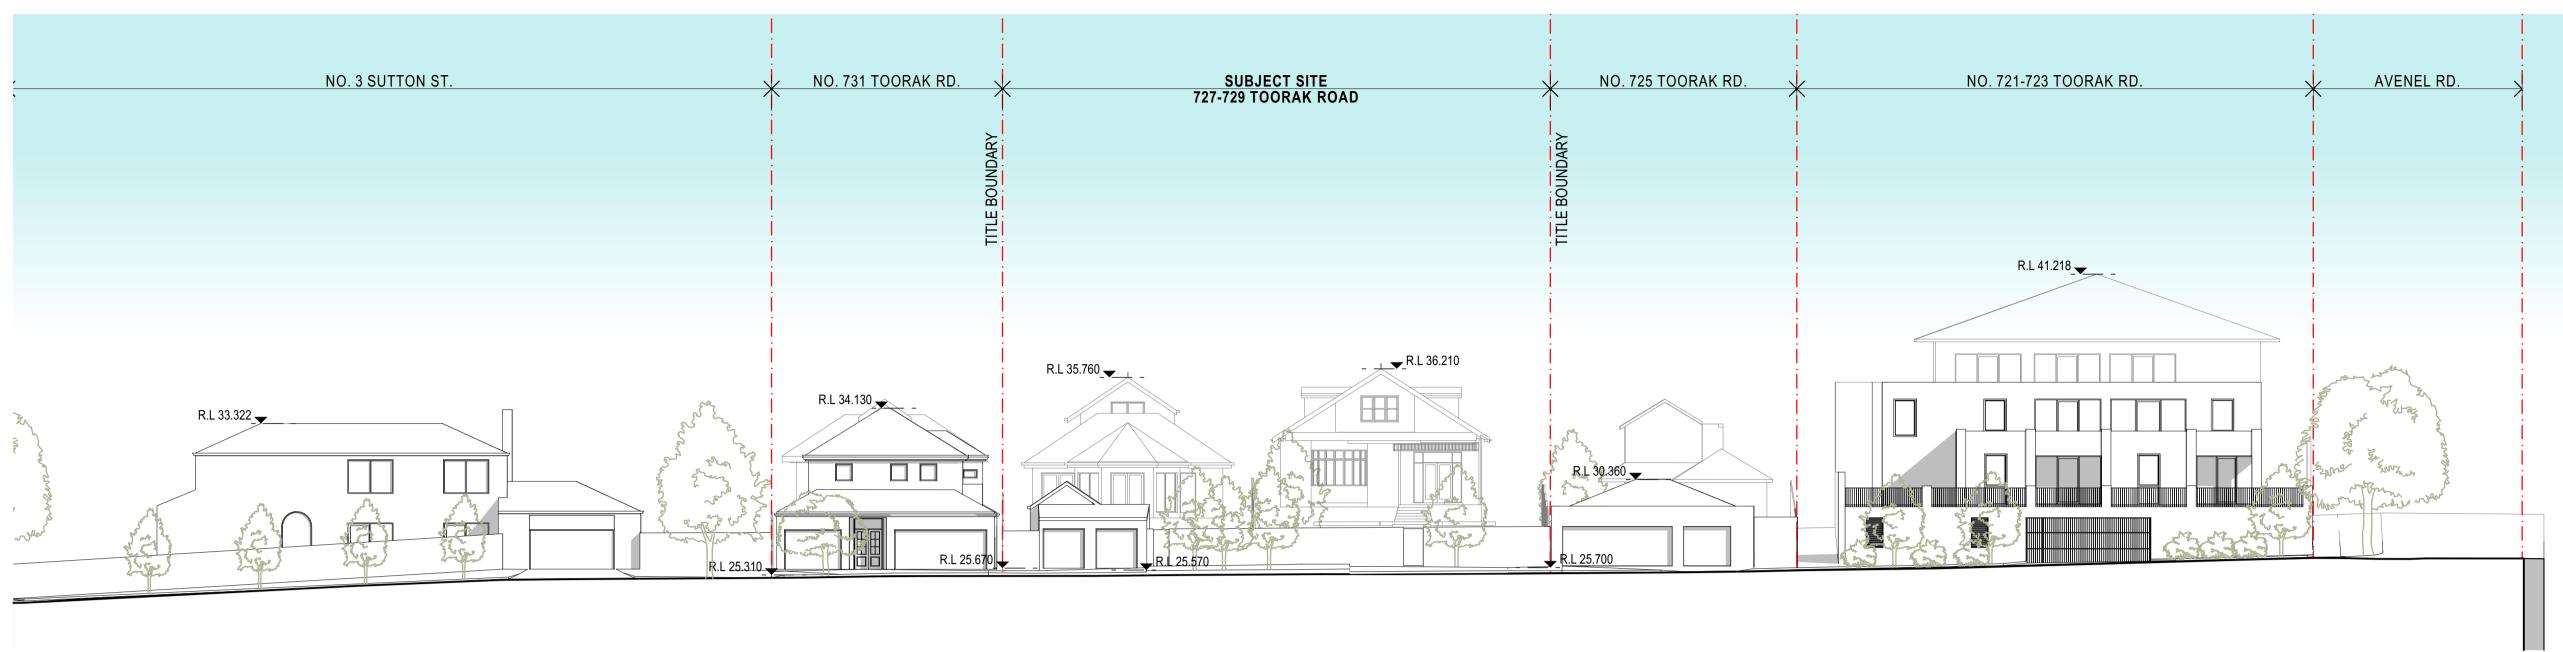

**EXISTING STREETSCAPE ELEVATION - SUTTON STREET** 

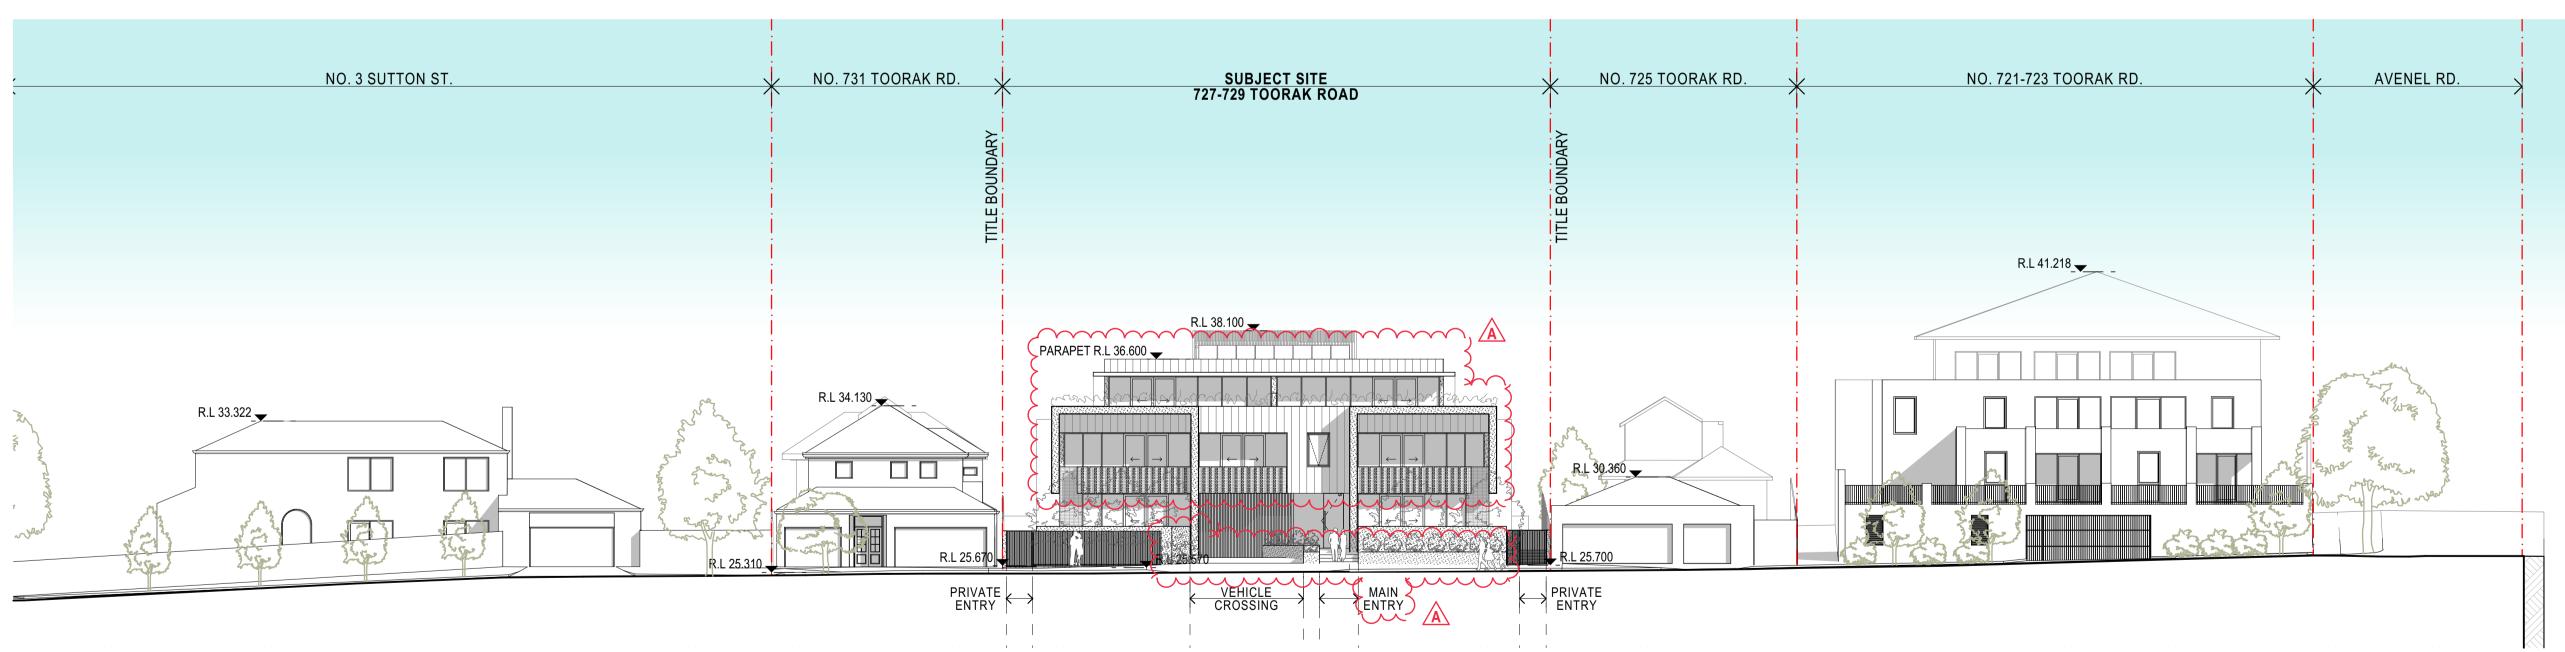

**PROPOSED STREETSCAPE ELEVATION - SUTTON STREET** 

12/08/2020



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-	21/04/2020	TOWN PLANNING
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PROJECT MULTI - RESIDENTIAL DEVELOPMENT 727-729 TOORAK ROAD, KOOYONG, VIC

DRAWING TITLE STREETSCAPE ELEVATIONS

SCALE	1:200@A1 1:400@A3	DATE JOB NO.	AUG. 2020 19017
DRAWN	NZ	DWG NO.	TP3.04
CHECKED	RF	REV.	A (12/08/2020)

# **CONCEPT + FORM**

The architecture is an aggregated intersection of verticality, floating planes, punctuated projections and negative spaces. These elements are dispersed through functions of privacy, identity and amenity whilst held together by a minimalistic formalism. Lush landscaping elements bind the architecture in a tapestry of growth and life.

These new insertions sit sedately behind the existing structures along Toorak Road - subservient but lending a glimpse of modernity.







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-	21/04/2020	TOWN PLANNING
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PROJECT MULTI - RESIDENTIAL DEVELOPMENT 727-729 TOORAK ROAD, KOOYONG, VIC

DESIGN: CONCEPT + FORM

SCALE		DATE	AUG. 2020
		JOB NO.	19017
DRAWN	NZ	DWG NO.	TP3.05
CHECKED	RF	REV.	A (12/08/2020)

# SUSTAINABILITY + MATERIALITY






FACEBRICK TYPE 1



FACEBRICK TYPE 2 "TESSELLATED"

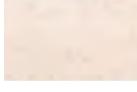

**RENDER FINISH** 




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 21/04/2020
 TOWN PLANNING

 A
 24/08/2020
 TOWN PLANNING RFI

 B
 7/10/2020
 TOWN PLANNING RFI 2nd

PROJECT

DRAWING TITLE

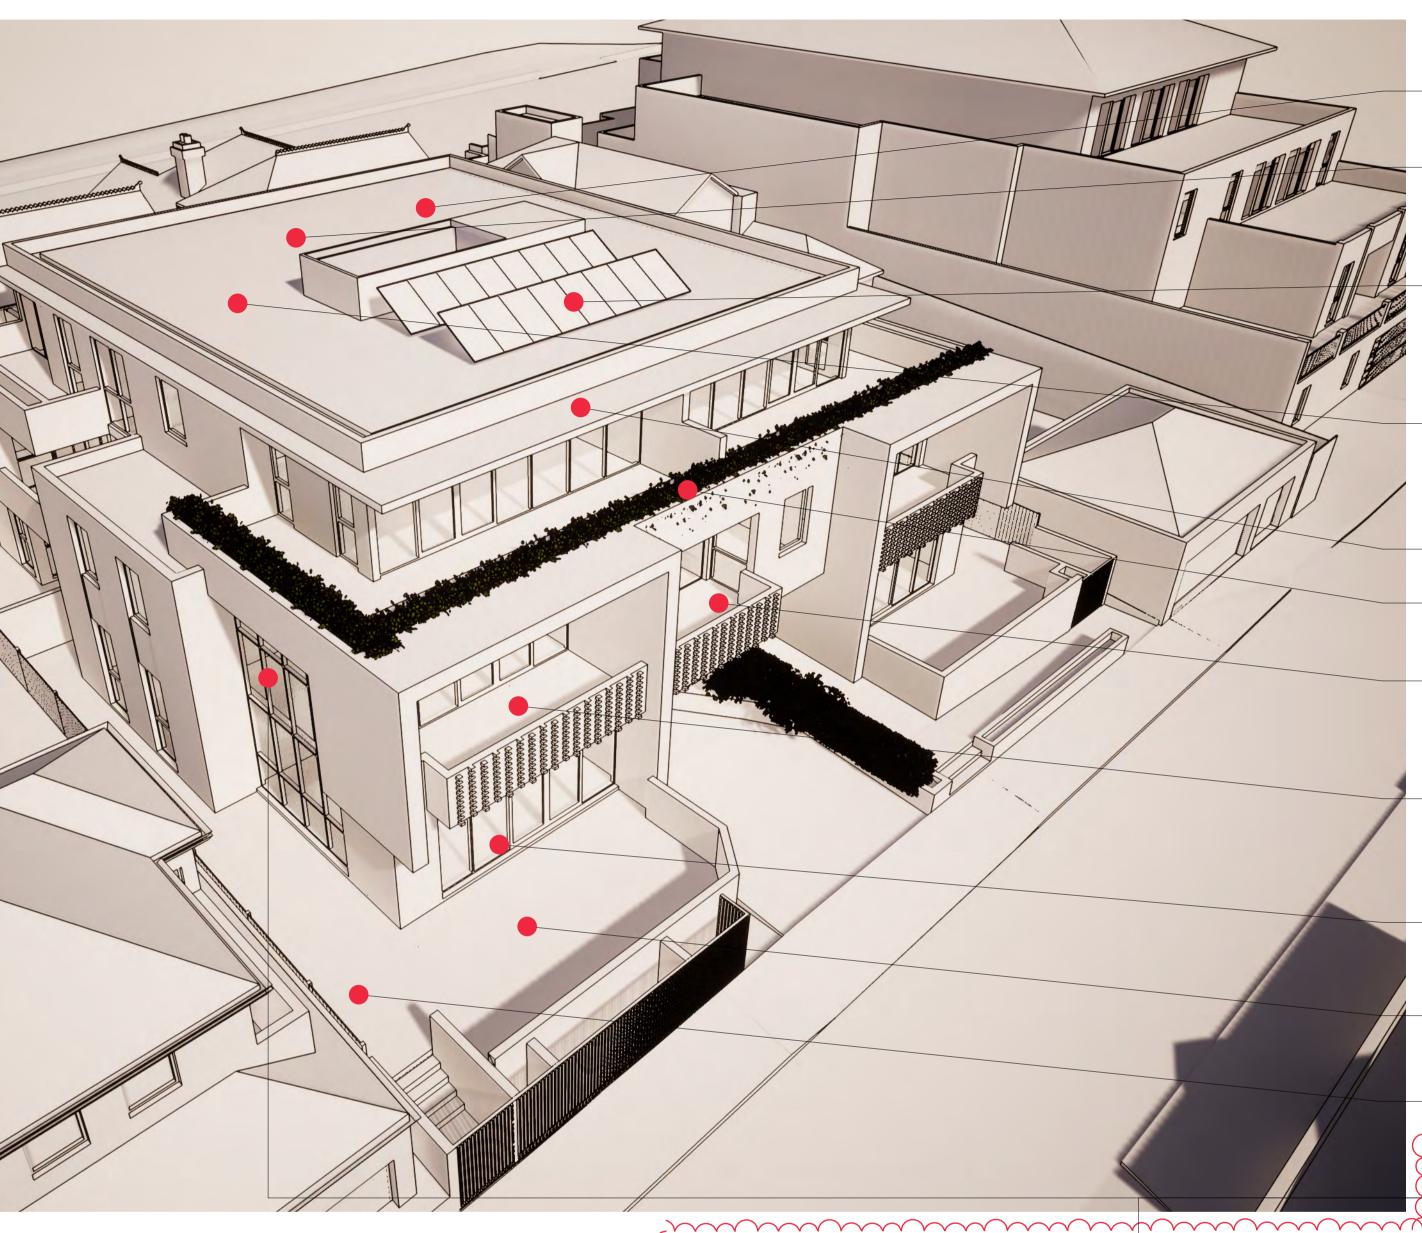MULTI - RESIDENTIAL DEVELOPMENT 727-729 TOORAK ROAD, KOOYONG, VIC

DESIGN: SUSTAINABILITY + MATERIALITY

## ESD: ACTIVE + PASSIVE

## RAINWATER HARVESTING

CENTRAL HEAT ELECTRIC PUMP HOT WATER SERVICE

4KW SOLAR PHOTOVOLTAIC PANELS TO PROVIDE POWER FOR COMMON-AREA USE

SELECTED AIR-CONDITIONING CONDENSORS TO BE LOCATED ON ROOF TO INCREASE ACOUSTIC COMFORT LEVELS AND OCCUPANT AMENITY

LIGHT-COLOURED ROOF TO REDUCE HEAT GAIN

"GREEN" EDGES

BUILDING INDENTATIONS AND OPEN CORNERS TO FACILITATE INCREASED SOLAR ACCESS AND CROSS-VENTILATION

NORTH-FACING AND/OR WRAP AROUND LIVING AREAS AND BALCONIES AS MUCH AS PRACTICABLE

AVERAGE 6.7-STAR ENERGY RATINGS TO APARTMENTS

ONE BICYCLE SPACE PER APARTMENT

PERMEABLE GROUND SURFACES

MOTORISED EXTERNAL ROLLER BLINDS WITH SELECTED COLOUR TO EAST AND WEST ELEVATIONS TO REDUCE HEAT GAIN

SCALE		DATE	OCT. 2020
		JOB NO.	19017
DRAWN	NZ	DWG NO.	TP3.06
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02 TP\19017\_TP\_NEW SCHEME (2F

DRAWING TITLE

MULTI - RESIDENTIAL DEVELOPMENT 727-729 TOORAK ROAD, KOOYONG, VIC

VISUAL AIDS

SCALE		DATE	AUG. 2020
		JOB NO.	19017
DRAWN	NZ	DWG NO.	TP3.07
CHECKED	RF	REV.	A (12/08/2020)





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Rev. ID	Issue Date	Issue Name
-	21/04/2020	TOWN PLANNING
А	12/08/2020	TOWN PLANNING RFI
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PROJECT MULTI - RESIDENTIAL DEVELOPMENT 727-729 TOORAK ROAD, KOOYONG, VIC

VISUAL AIDS

SCALE		DATE	AUG. 2020
		JOB NO.	19017
DRAWN	NZ	DWG NO.	TP3.08
CHECKED	RF	REV.	A (12/08/2020)





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3D Models/2.1.02 TP/19017\_TP\_NEW SCHEME (2F

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-	21/04/2020	TOWN PLANNING
А	12/08/2020	TOWN PLANNING RFI

PROJECT MULTI - RESIDENTIAL DEVELOPMENT 727-729 TOORAK ROAD, KOOYONG, VIC

VISUAL AIDS

DATE	AUG. 2020
JOB NO.	19017
DWG NO.	TP3.09
REV.	A (12/08/2020)
	JOB NO. DWG NO.



# **CORNER OF SUTTON ST. & AVENEL AVE.**



# CORNER OF SUTTON ST. & ELIZABETH ST.



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Models/2.1.02 TP\19017\_TP\_NEW SCHEME (2F

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-	21/04/2020	TOWN PLANNING
А	12/08/2020	TOWN PLANNING RFI

MULTI - RESIDENTIAL DEVELOPMENT PROJECT 727-729 TOORAK ROAD, KOOYONG, VIC

VISUAL AIDS

SCALE		@A1	DATE	AUG. 2020
			JOB NO.	19017
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TOORAK RD. AERIAL VIEW



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MULTI - RESIDENTIAL DEVELOPMENT PROJECT 727-729 TOORAK ROAD, KOOYONG, VIC

VISUAL AIDS

SCALE		DATE	AUG. 2020
		JOB NO.	19017
DRAWN	NZ	DWG NO.	TP3.12
CHECKED	RF	REV.	A (12/08/2020)

# DEVELOPMENT SUMMARY

SITE INFORMATION	
	4.4502
SITE AREA:	1,452m <sup>2</sup>
SITE COVERAGE:	880.8m <sup>2</sup> (60.7%)
PERMEABLE AREA:	✓ 439.8m <sup>2</sup> (30.3%)
GARDEN AREA:	► 521.7m <sup>2</sup> (35.9%)
	inn
	B
CARPARK & BIKE SPACE	
NUMBER OF CARPARKS:	28 (INCL. 2 VISITOR)
NUMBER OF BICYCLE PARKS:	18 (INCL. 4 VISITOR)
STORAGE	
NUMBER OF STORAGES	15

LEVEL	GFA	COVERAGE
BASEMENT 2	605.5	41.7%
BASEMENT 1	605.5	41.7%
GROUND FLOOR	855.0 B	
FIRST FLOOR	756.2	
SECOND FLOOR	497.5	
TOTAL GFA	<b>3,319.7 m<sup>2</sup></b>	
	ß	

BASEMENT LEVEL 2				
COMMON AREA	CARPARKING	518.8		
	CIRCULATION	51.6		
	SERVICES	34.5		
	TOTAL	605.5 m²		

BASEMENT LEVEL 1				
COMMON AREA	CARPARKING	530.4		
	CIRCULATION	51.6		
	REFUSE	14.5		
	SERVICES	8.7		
	TOTAL	605.5 m²		

GROUND FLOOR					
	CIRCULATION	129.7			
APARTMENTS	G01	142.7			
	Ç G02	82.5			
	G03	82.4			
	G04	134.3			
COMMON AREA	SERVICES	10.0			
HOUSES	TH1	130.3			
	TH2	138.6			
	TOTAL 855.0 m <sup>2</sup>				

 $\mathcal{S}$ 

FIRST FLOOR					
APARTMENTS	101	125.1			
	102	81.6			
	103	81.6			
	104	125.1			
	105	63.9			
COMMON AREA	CIRCULATION	42.9			
	SERVICES	3.8			
	TERRACE	74.0			
HOUSES	TH1	88.4			
	TH2	55.3			
	TOTAL	756.2 m²			

SECOND FLOOR				
	201	166.3		
APARTMENTS	202	166.3		
	CIRCULATION	31.9		
COMMON AREA	SERVICES	28.3		
	TERRACE	104.8		
	TOTAL	497.6 m²		

INTERLANDI MANTESSO ARCHITECTS

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7/10/2020

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UNIT	TYPE	FLOOR AREA	TERRACE /OUTDOOR	TOTAL AREA	ACCESSIBILITY		
GROUND FLOOR	GROUND FLOOR						
G01	3 BED	142.7	91.7	236m <sup>2</sup>	YES		
G02	1 BED	82.5	35.7	118.2m <sup>2</sup>	YES		
G03	5 1 BED	82.4	34.8	117.2m <sup>2</sup>	YES		
G04	3 BED	134.3	83.1	218.5m <sup>2</sup>	YES		
FIRST FLOOR							
101	3 BED	125.1	17.9	143.0m <sup>2</sup>	YES		
102	2 BED	81.6	8.3	89.9m <sup>2</sup>	YES		
103	2 BED	81.6	8.3	89.9m <sup>2</sup>	YES		
104	3 BED	125.1	17.9	143.0m <sup>2</sup>	YES		
105	1 BED	63.9	12.7	76.6m <sup>2</sup>	YES		
SECOND FLOOR							
201	3 BED	166.3	52.4	218.7m <sup>2</sup>	YES		
202	3 BED	166.3	52.4	218.7m <sup>2</sup>	YES		
TOWNHOUSES (TO	ORAK ROAD)						
TH1	3 BED	218.7	108.4	327.1m <sup>2</sup>	N/A		
TH2	3 BED	194.0	122.7	316.7m <sup>2</sup>	N/A		
TOTAL: 13 UNITS	3 x1B, 2 x2B, 8 x3B	1,664.4 m²	655.2 m²	2,319.6m <sup>2</sup>	11 UNITS > 50%		
				B			


Rev. ID	Issue Date	Issue Name
-	21/04/2020	TOWN PLANNING
A	24/08/2020	TOWN PLANNING RFI
В	7/10/2020	TOWN PLANNING RFI 2nd
-		

PROJECT MULTI - RESIDENTIAL DEVELOPMENT 727-729 TOORAK ROAD, KOOYONG, VIC

DRAWING TITLE DEVELOPMENT SUMMARY



SCALE	@A1	DATE	OCT. 2020
		JOB NO.	19017
DRAWN	NZ	DWG NO.	TP3.16
CHECKED	RF	REV.	B (7/10/2020)

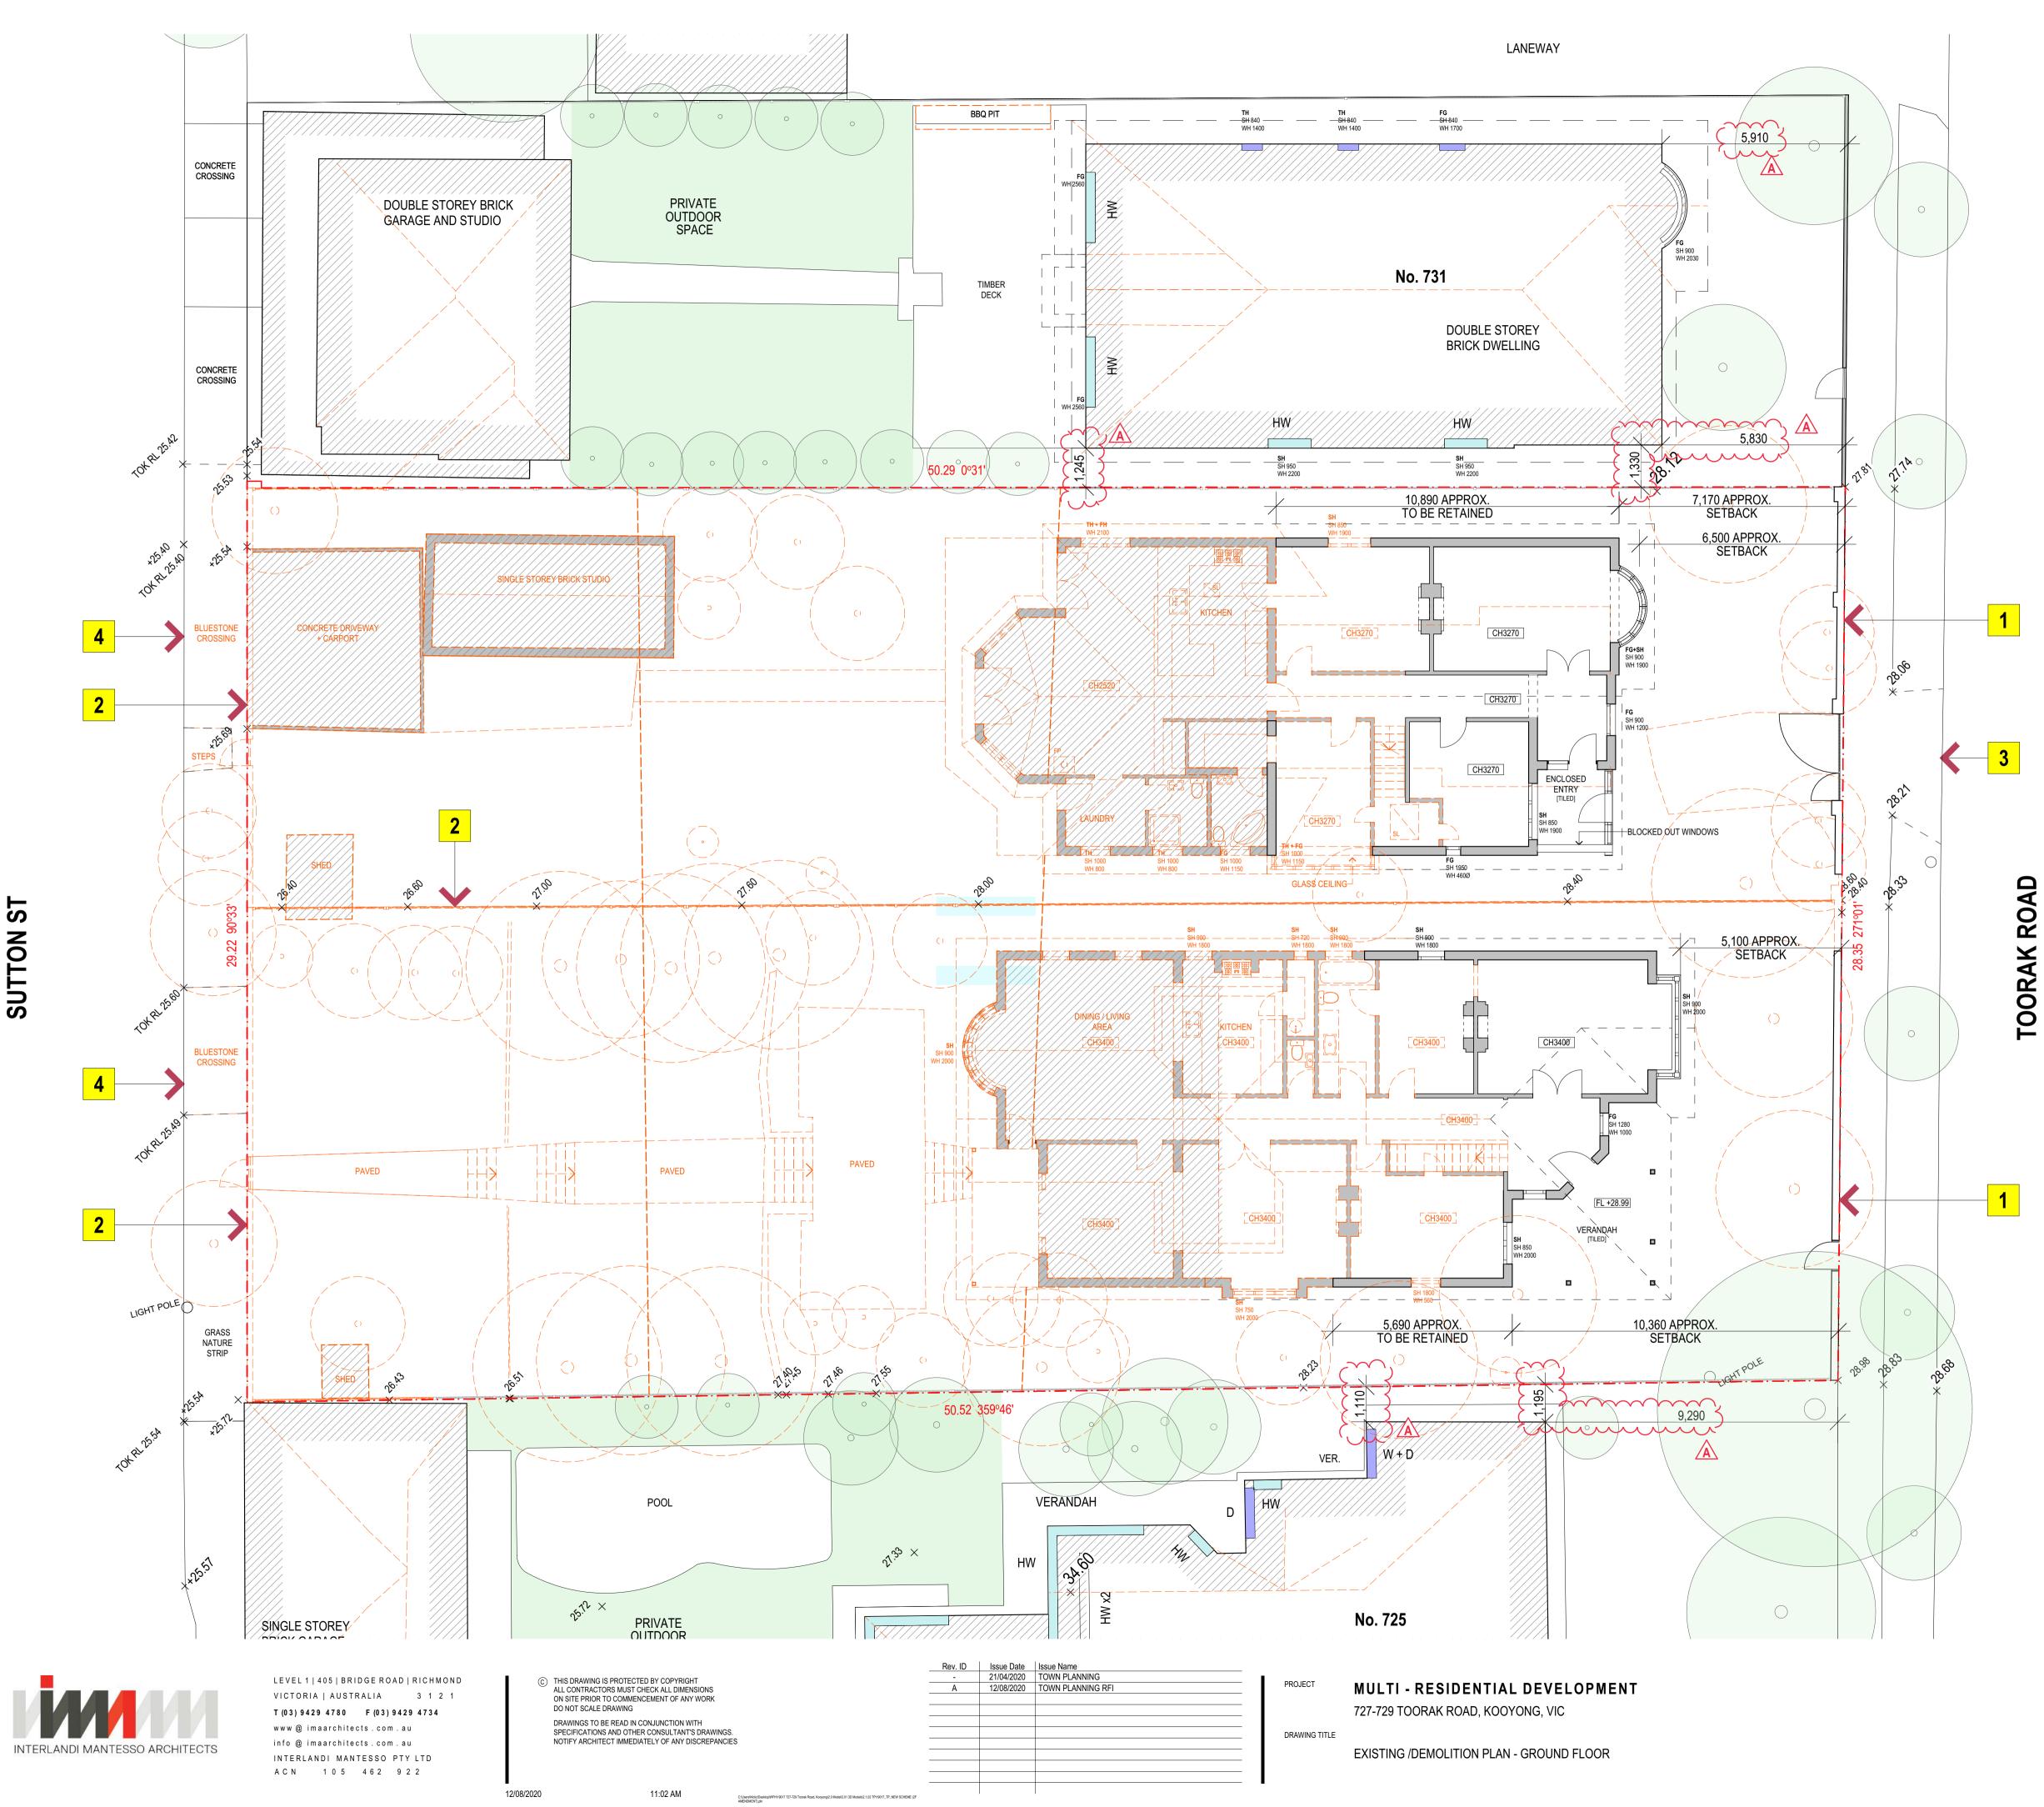

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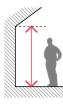
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ROAD  $\boldsymbol{\mathbf{X}}$ 

SL CHXXXX FP FG SH ΤH ΗW

SKYLIGHT CEILING HEIGHT (MM) FIREPLACE FIXED GLASS WINDOW SINGLE HUNG WINDOW TOP HUNG WINDOW NEIGHBORING HABITABLE WINDOW NEIGHBORING DOOR

EXISTING TREES



WALL HEIGHT MEASUREMENT - MEASURED TO INTERNAL SPRINGING POINT


SILL HEIGHT MEASUREMENT - MEASURED FROM INTERNAL FFL

WINDOW HEIGHT MEASUREMENT -MEASURED OPENING


# **DEMOLITION LEGEND**


	EXISTING BUILDING /STRUCTURE TO BE RETAINED
Z <i>7_7_7_7</i> _2	EXISTING BUILDING /STRUCTURE TO BE DEMOLISHED. (EXT. BRICKS AND ROOF TILES TO BE RE-USED)
0	EXISTING TREE
	EXISTING TREE TO BE REMOVED
1	EXISTING 2M BOUNDARY BRICK FENCE TO BE RETAINED (ALONG TOORAK RD.)
2	EXISTING BOUNDARY TIMBER FENCE TO BE DEMOLISHED (ALONG SUTTON ST.)
3	EXISTING CROSSING TO BE REMOVED AND AND REINSTATED (ALONG TOORAK RD.)
4	EXISTING CROSSING TO BE REMOVED AND REINSTATED (ALONG SUTTON ST.)




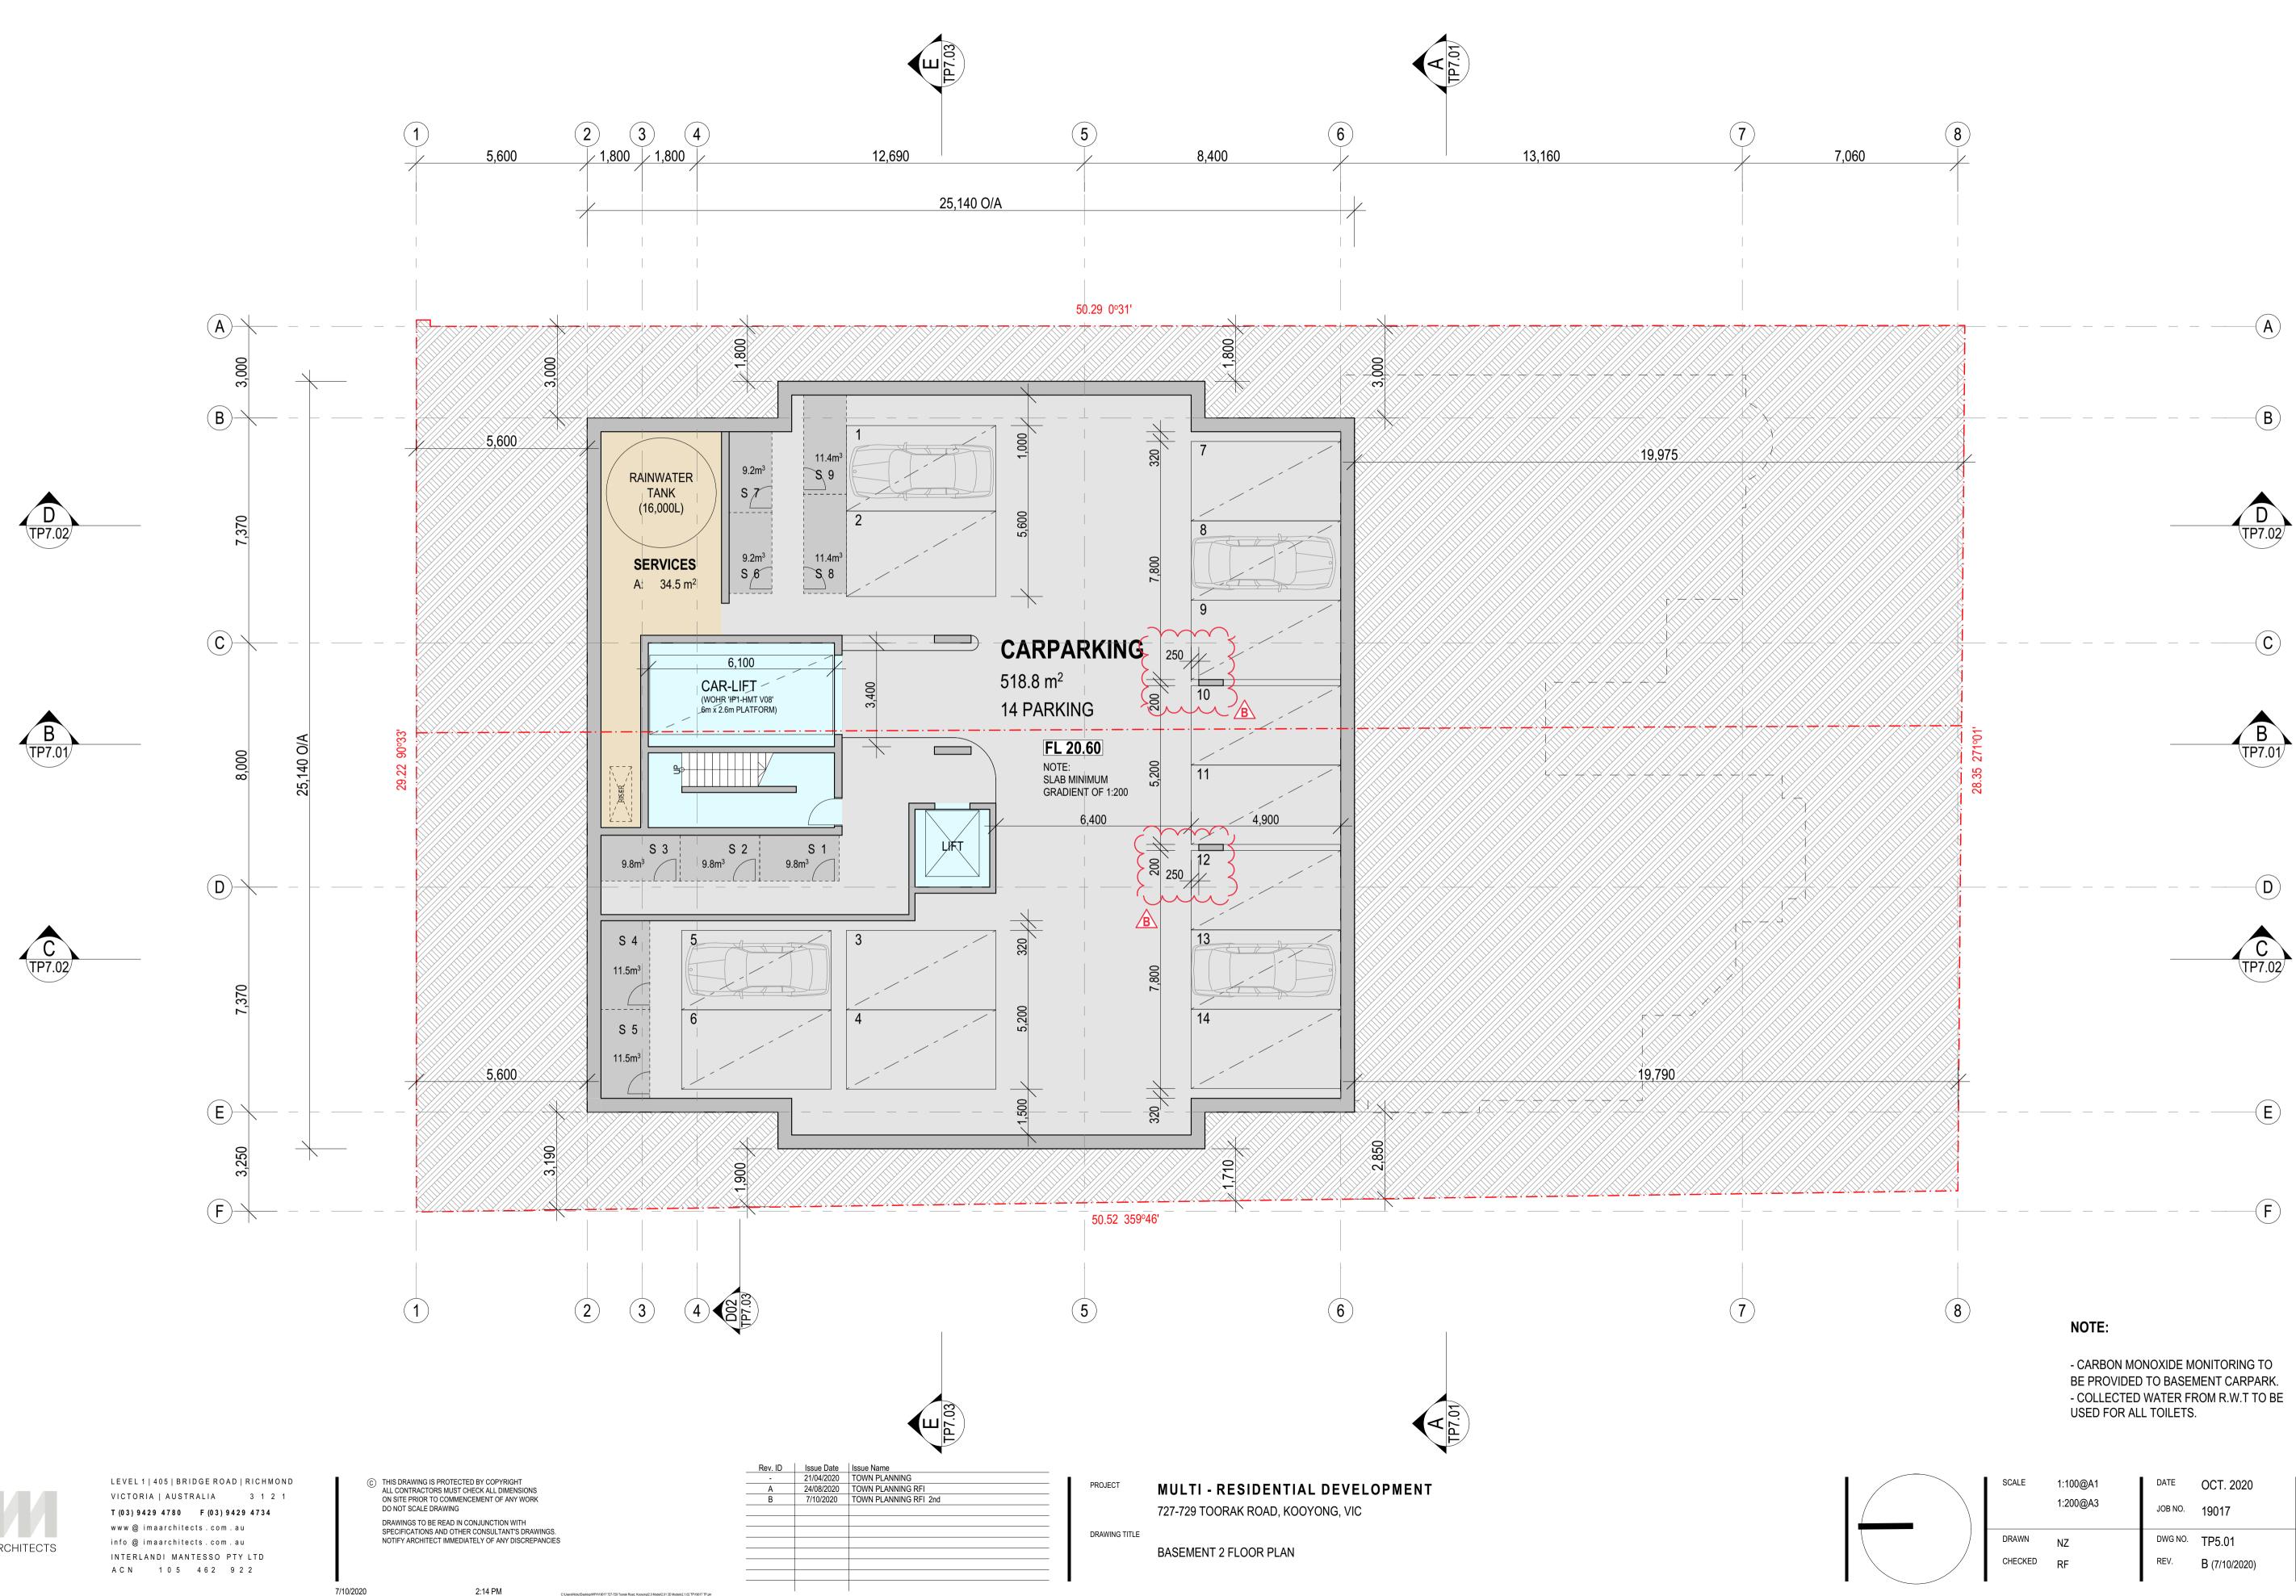



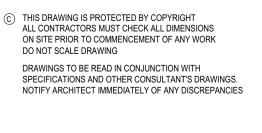


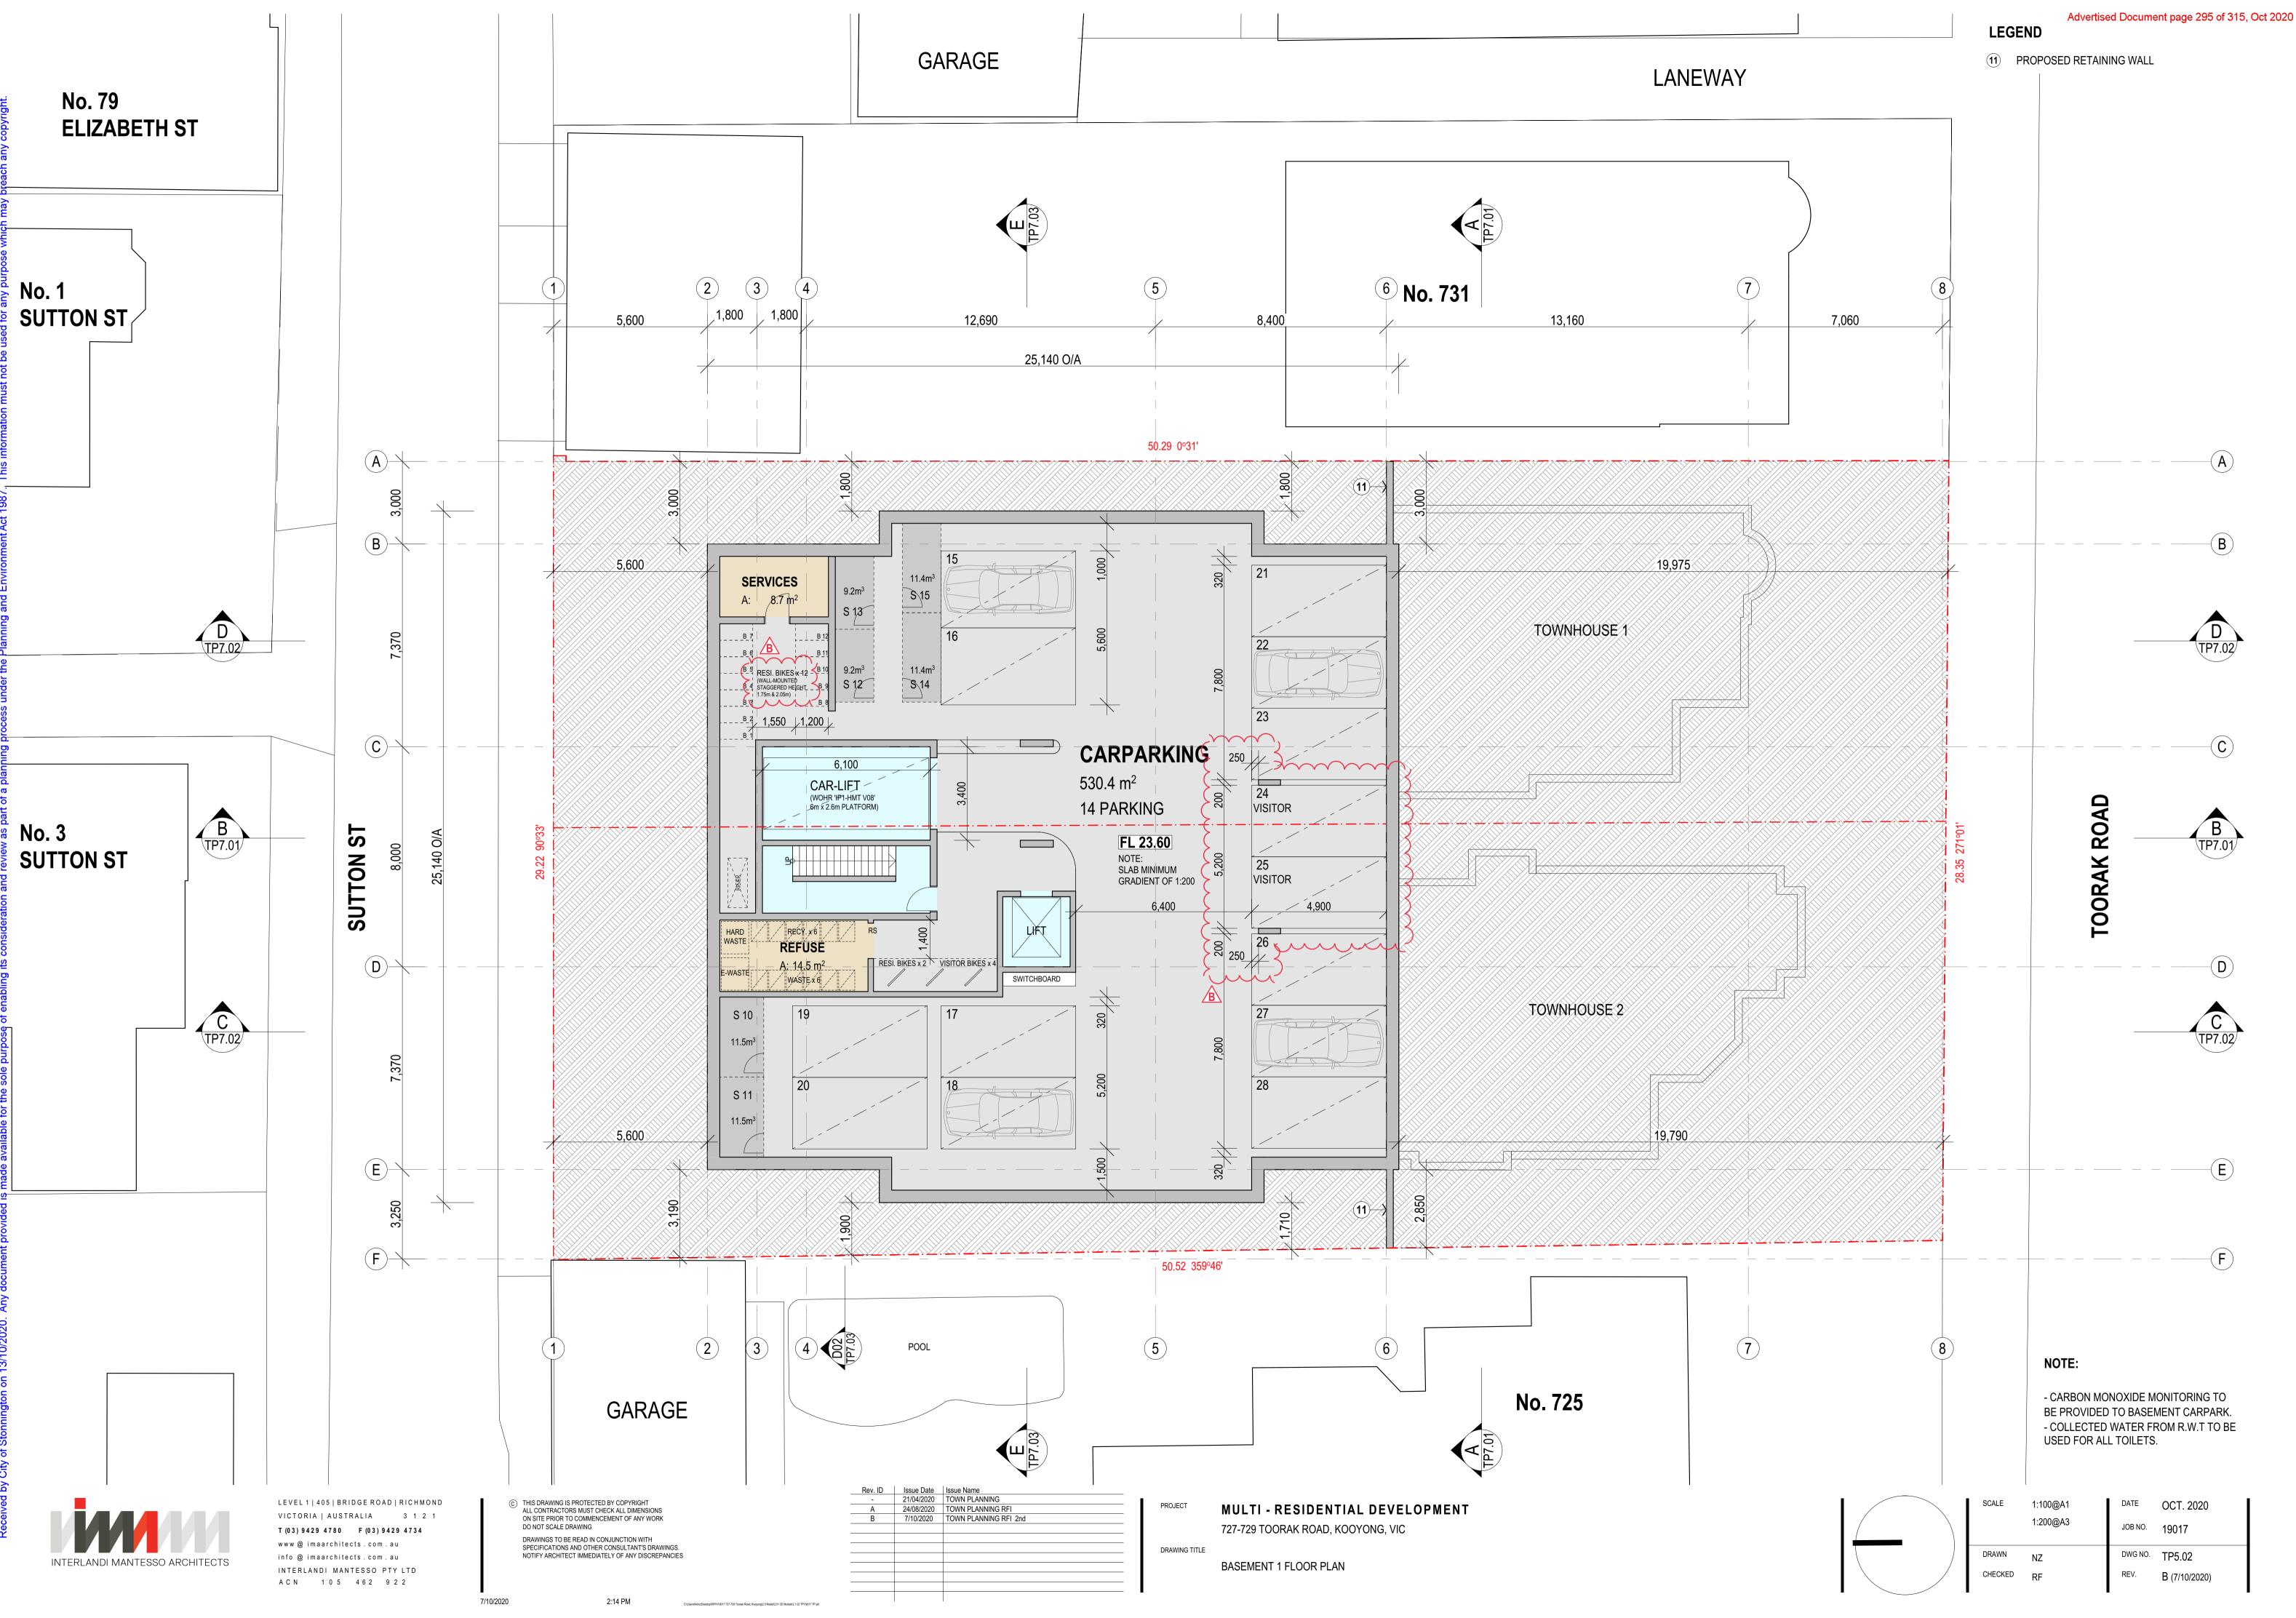

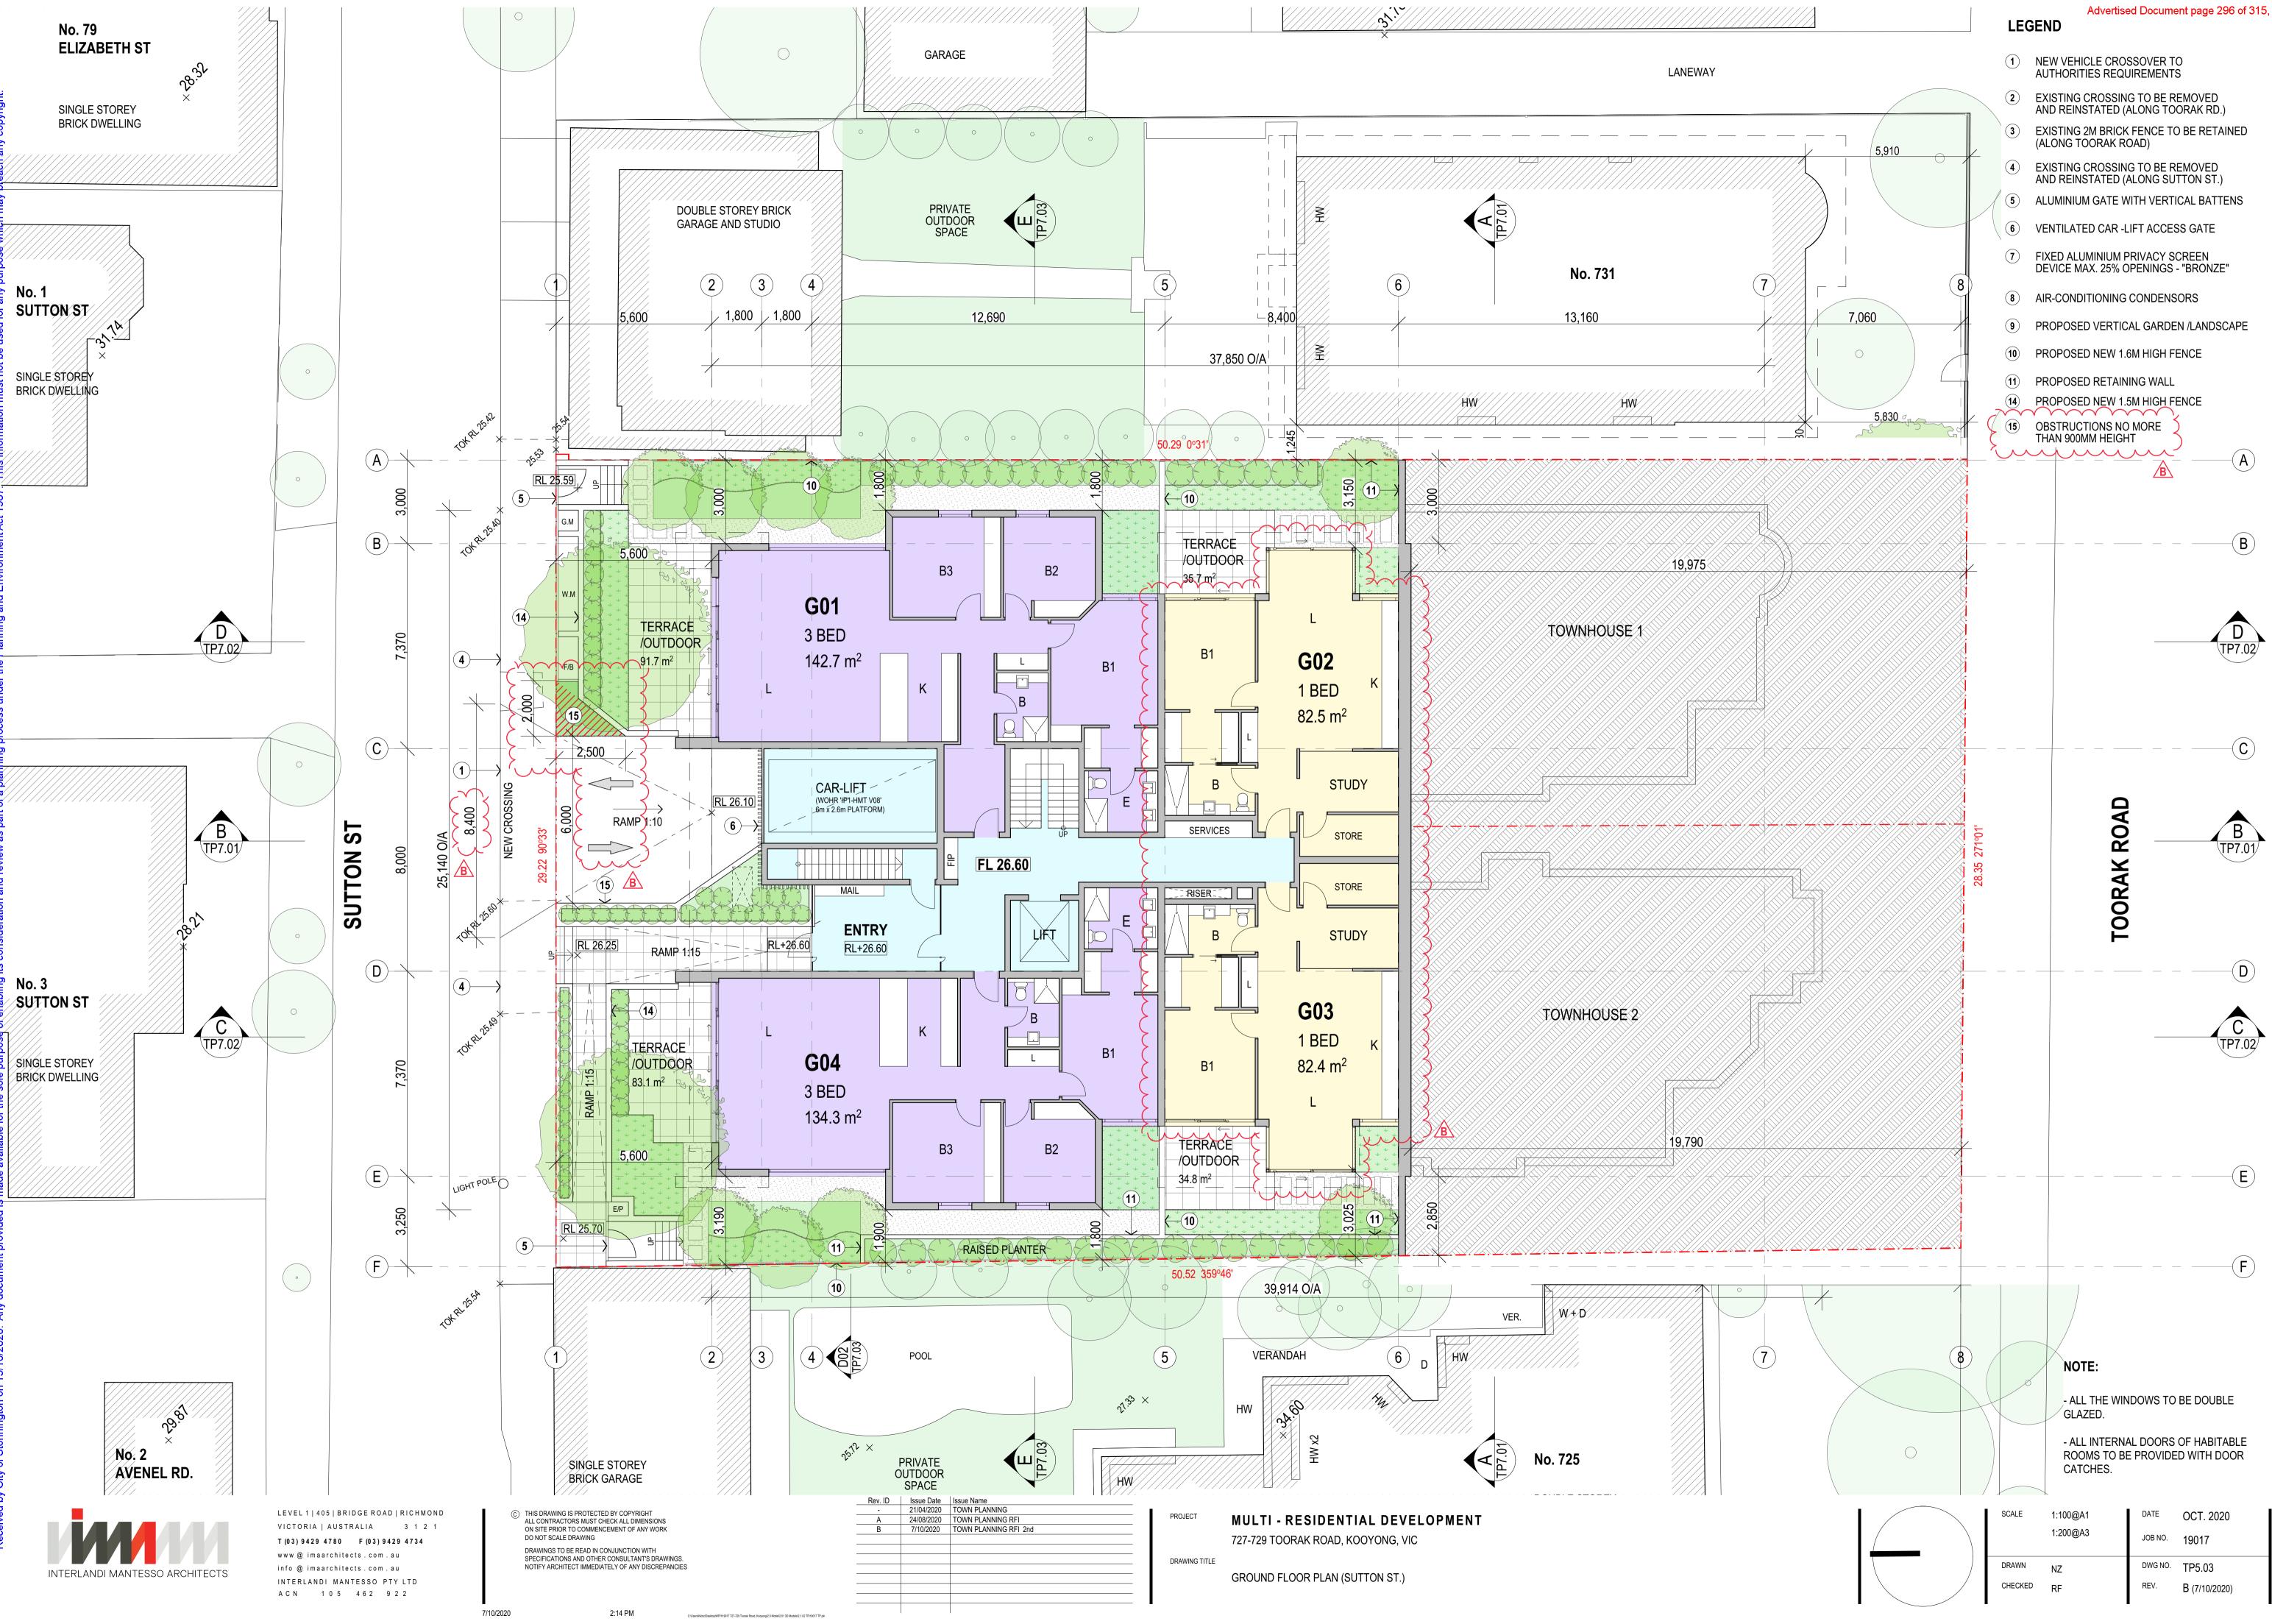






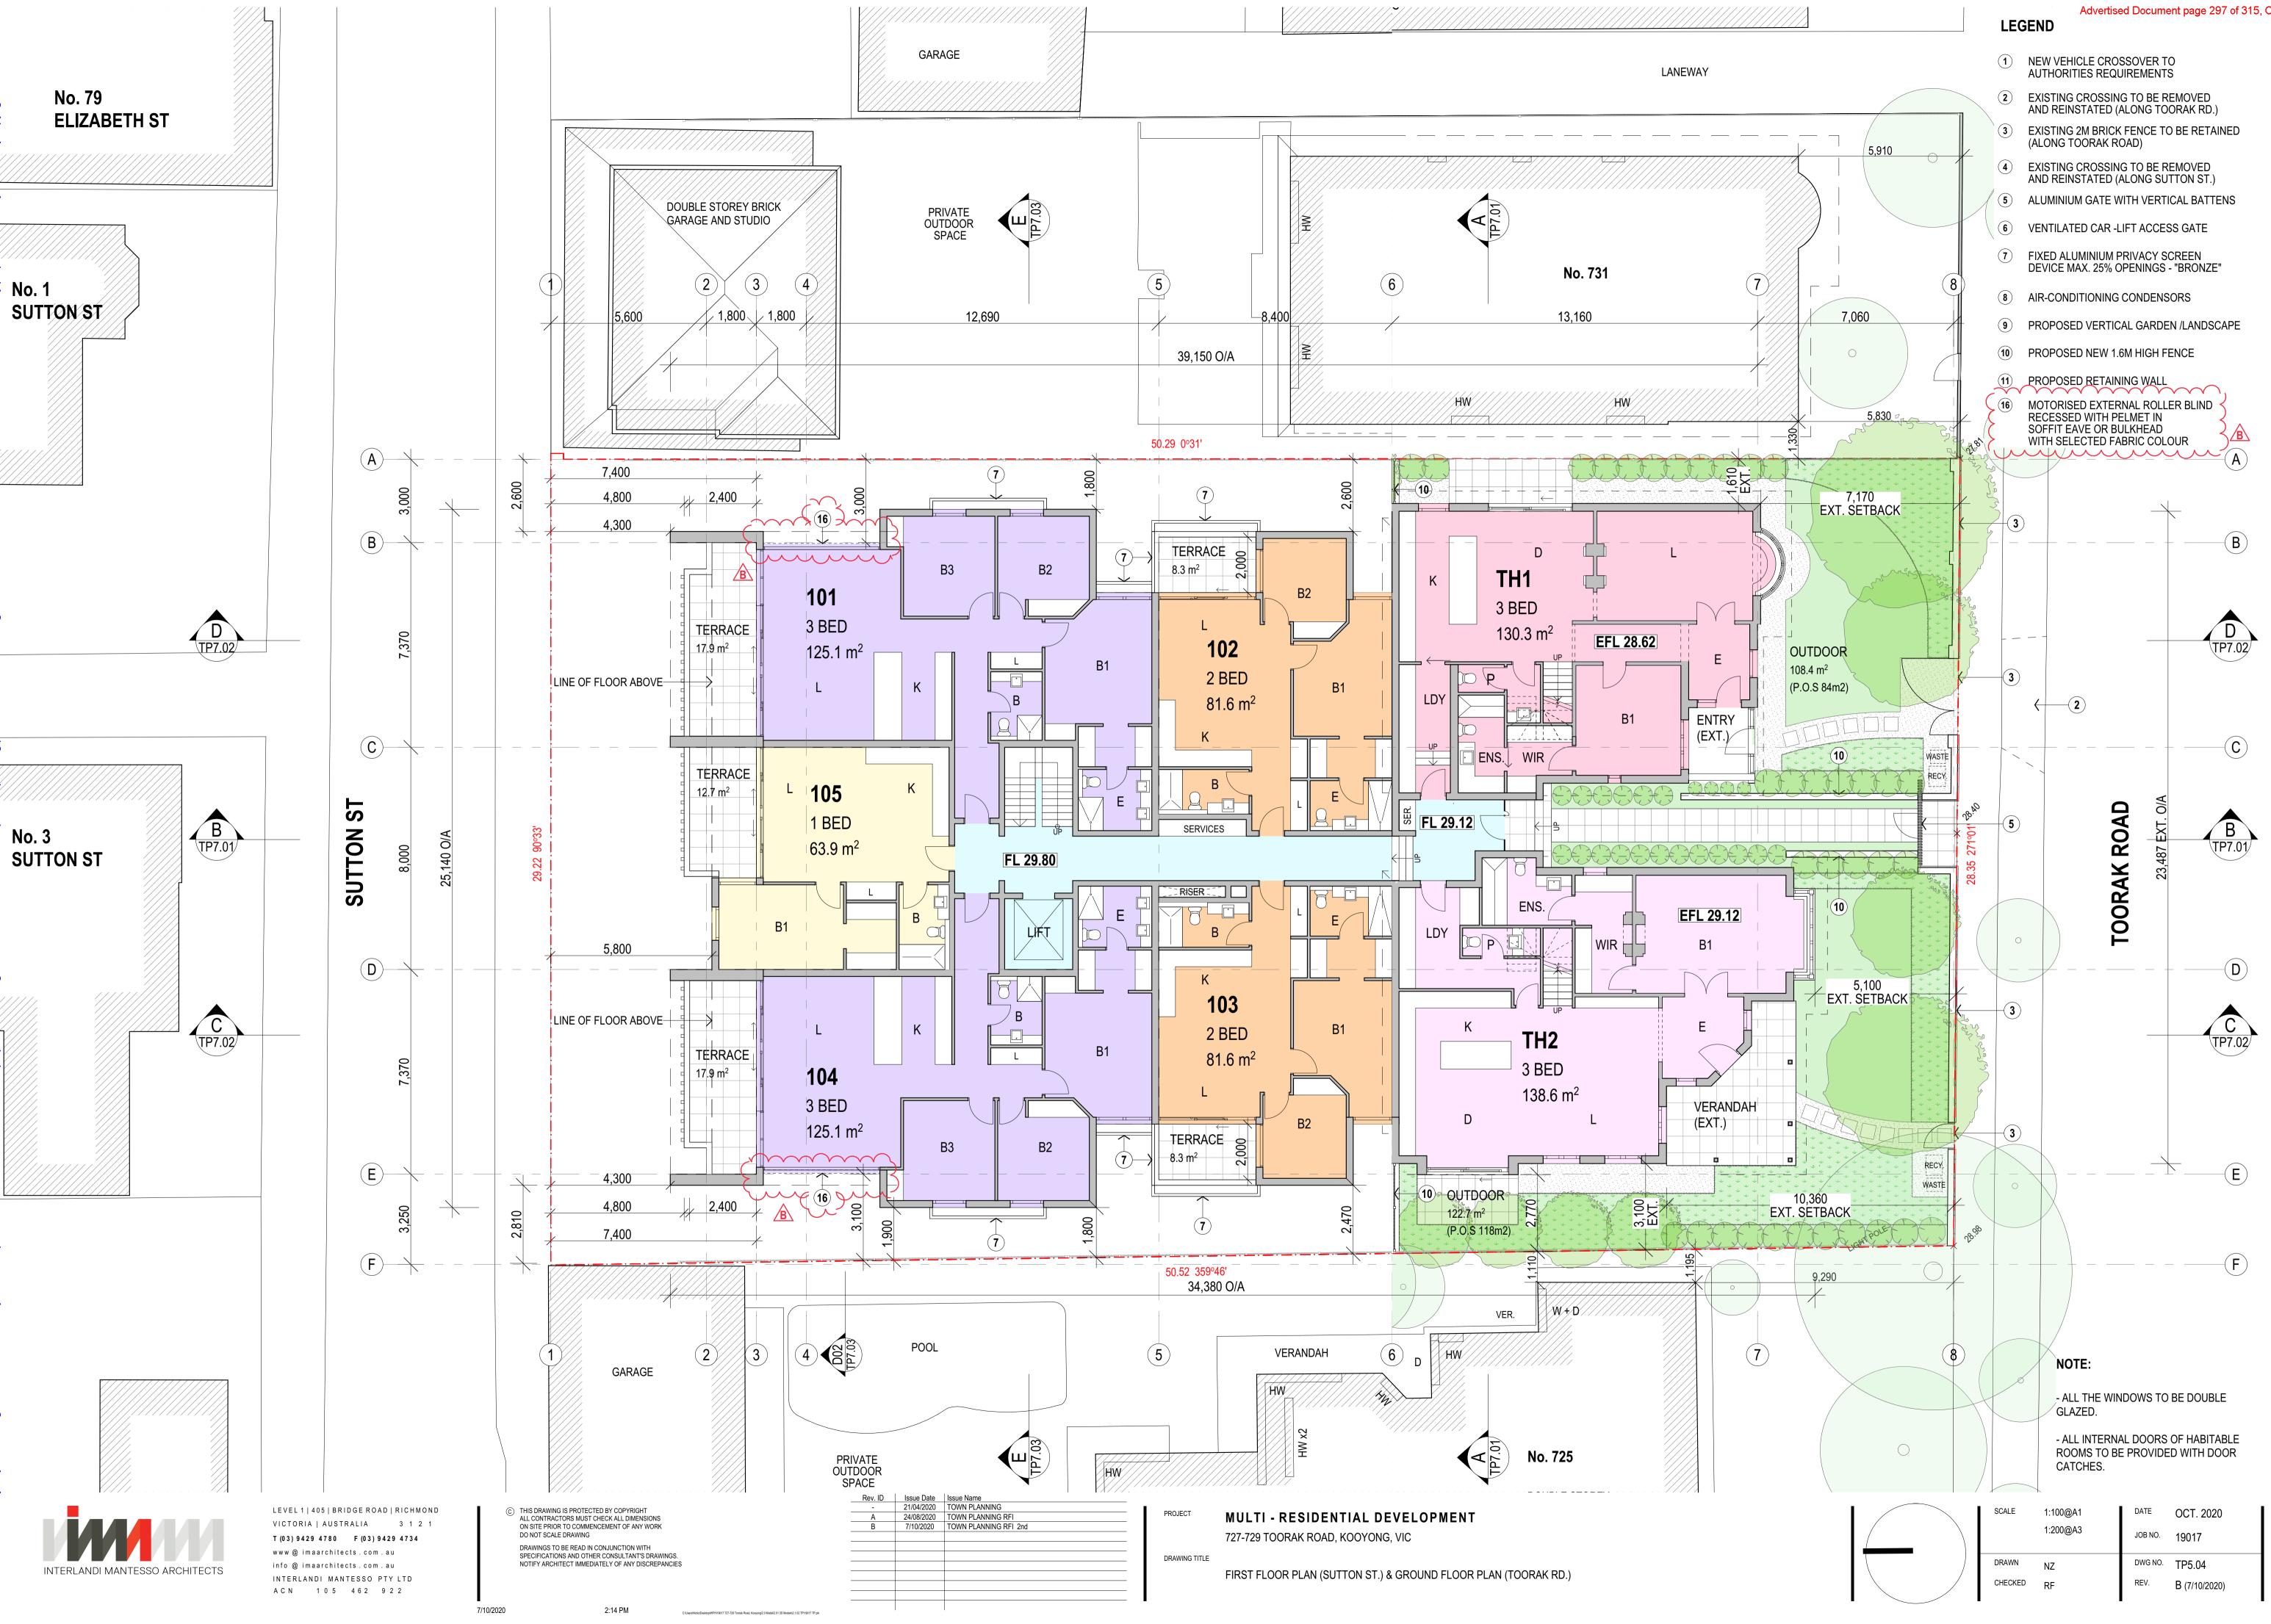


### Advertised Document page 297 of 315, Oct 2020

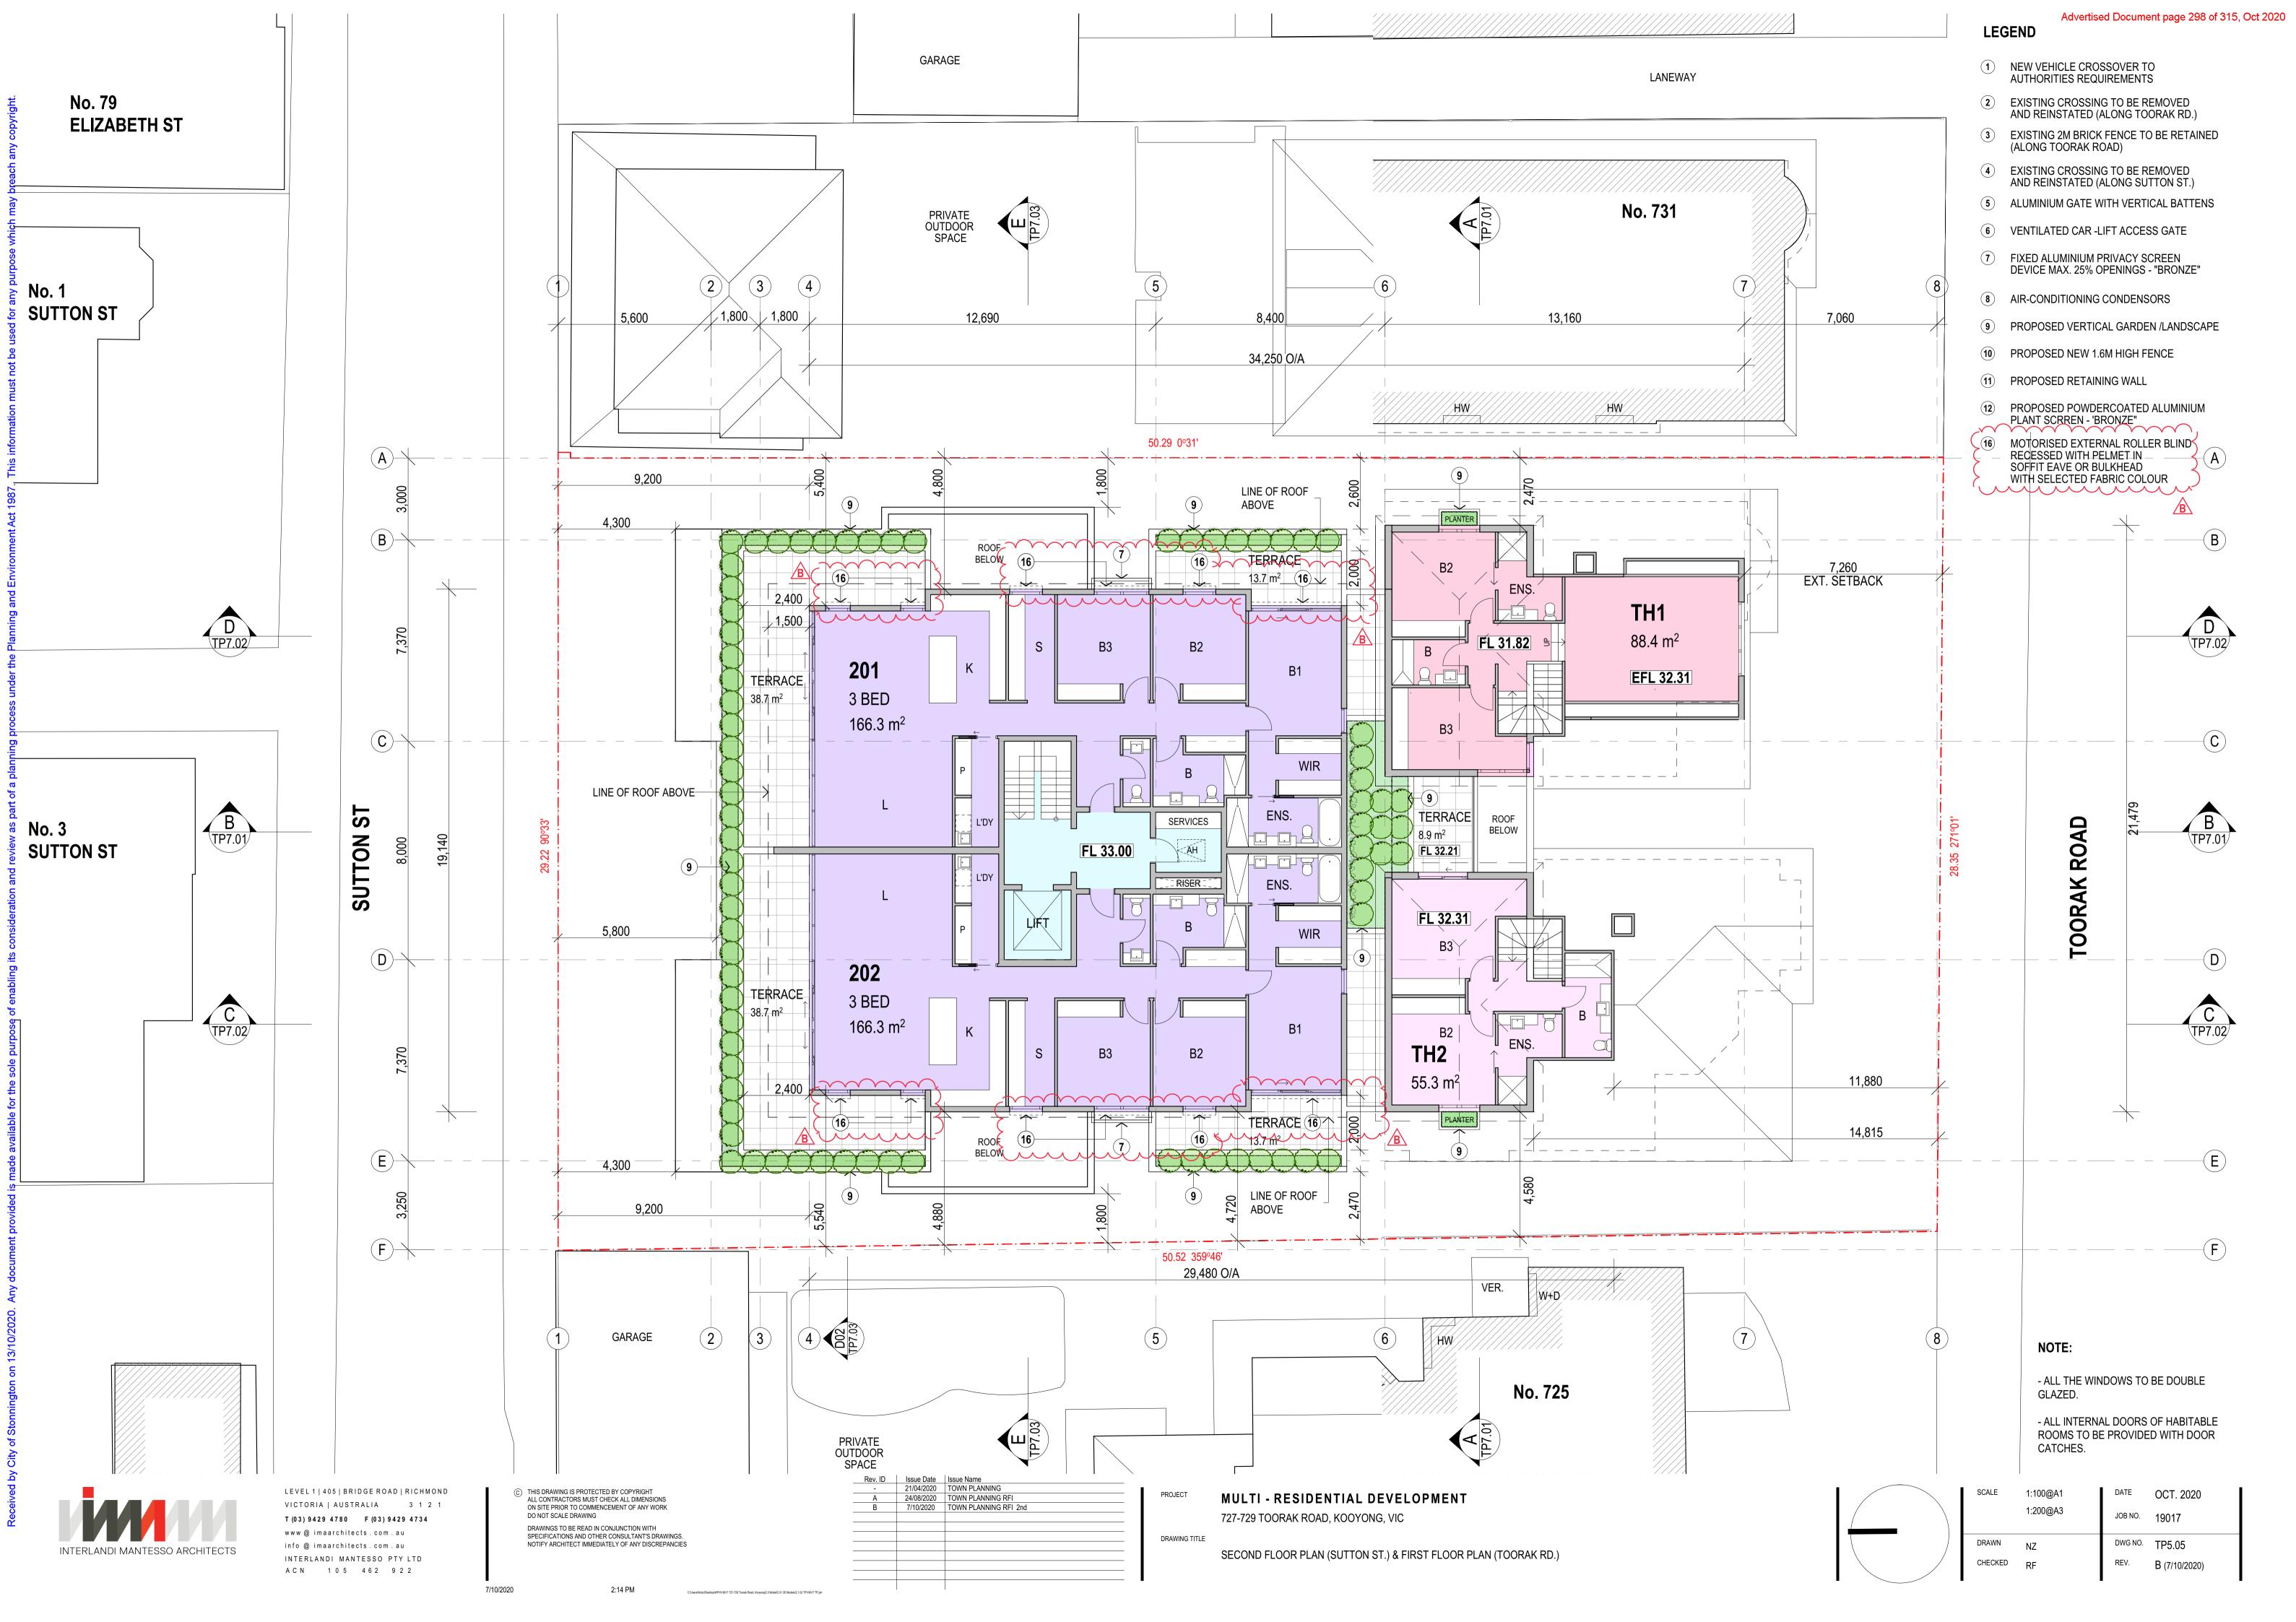



**B** (TP7.0)

C TP7.02

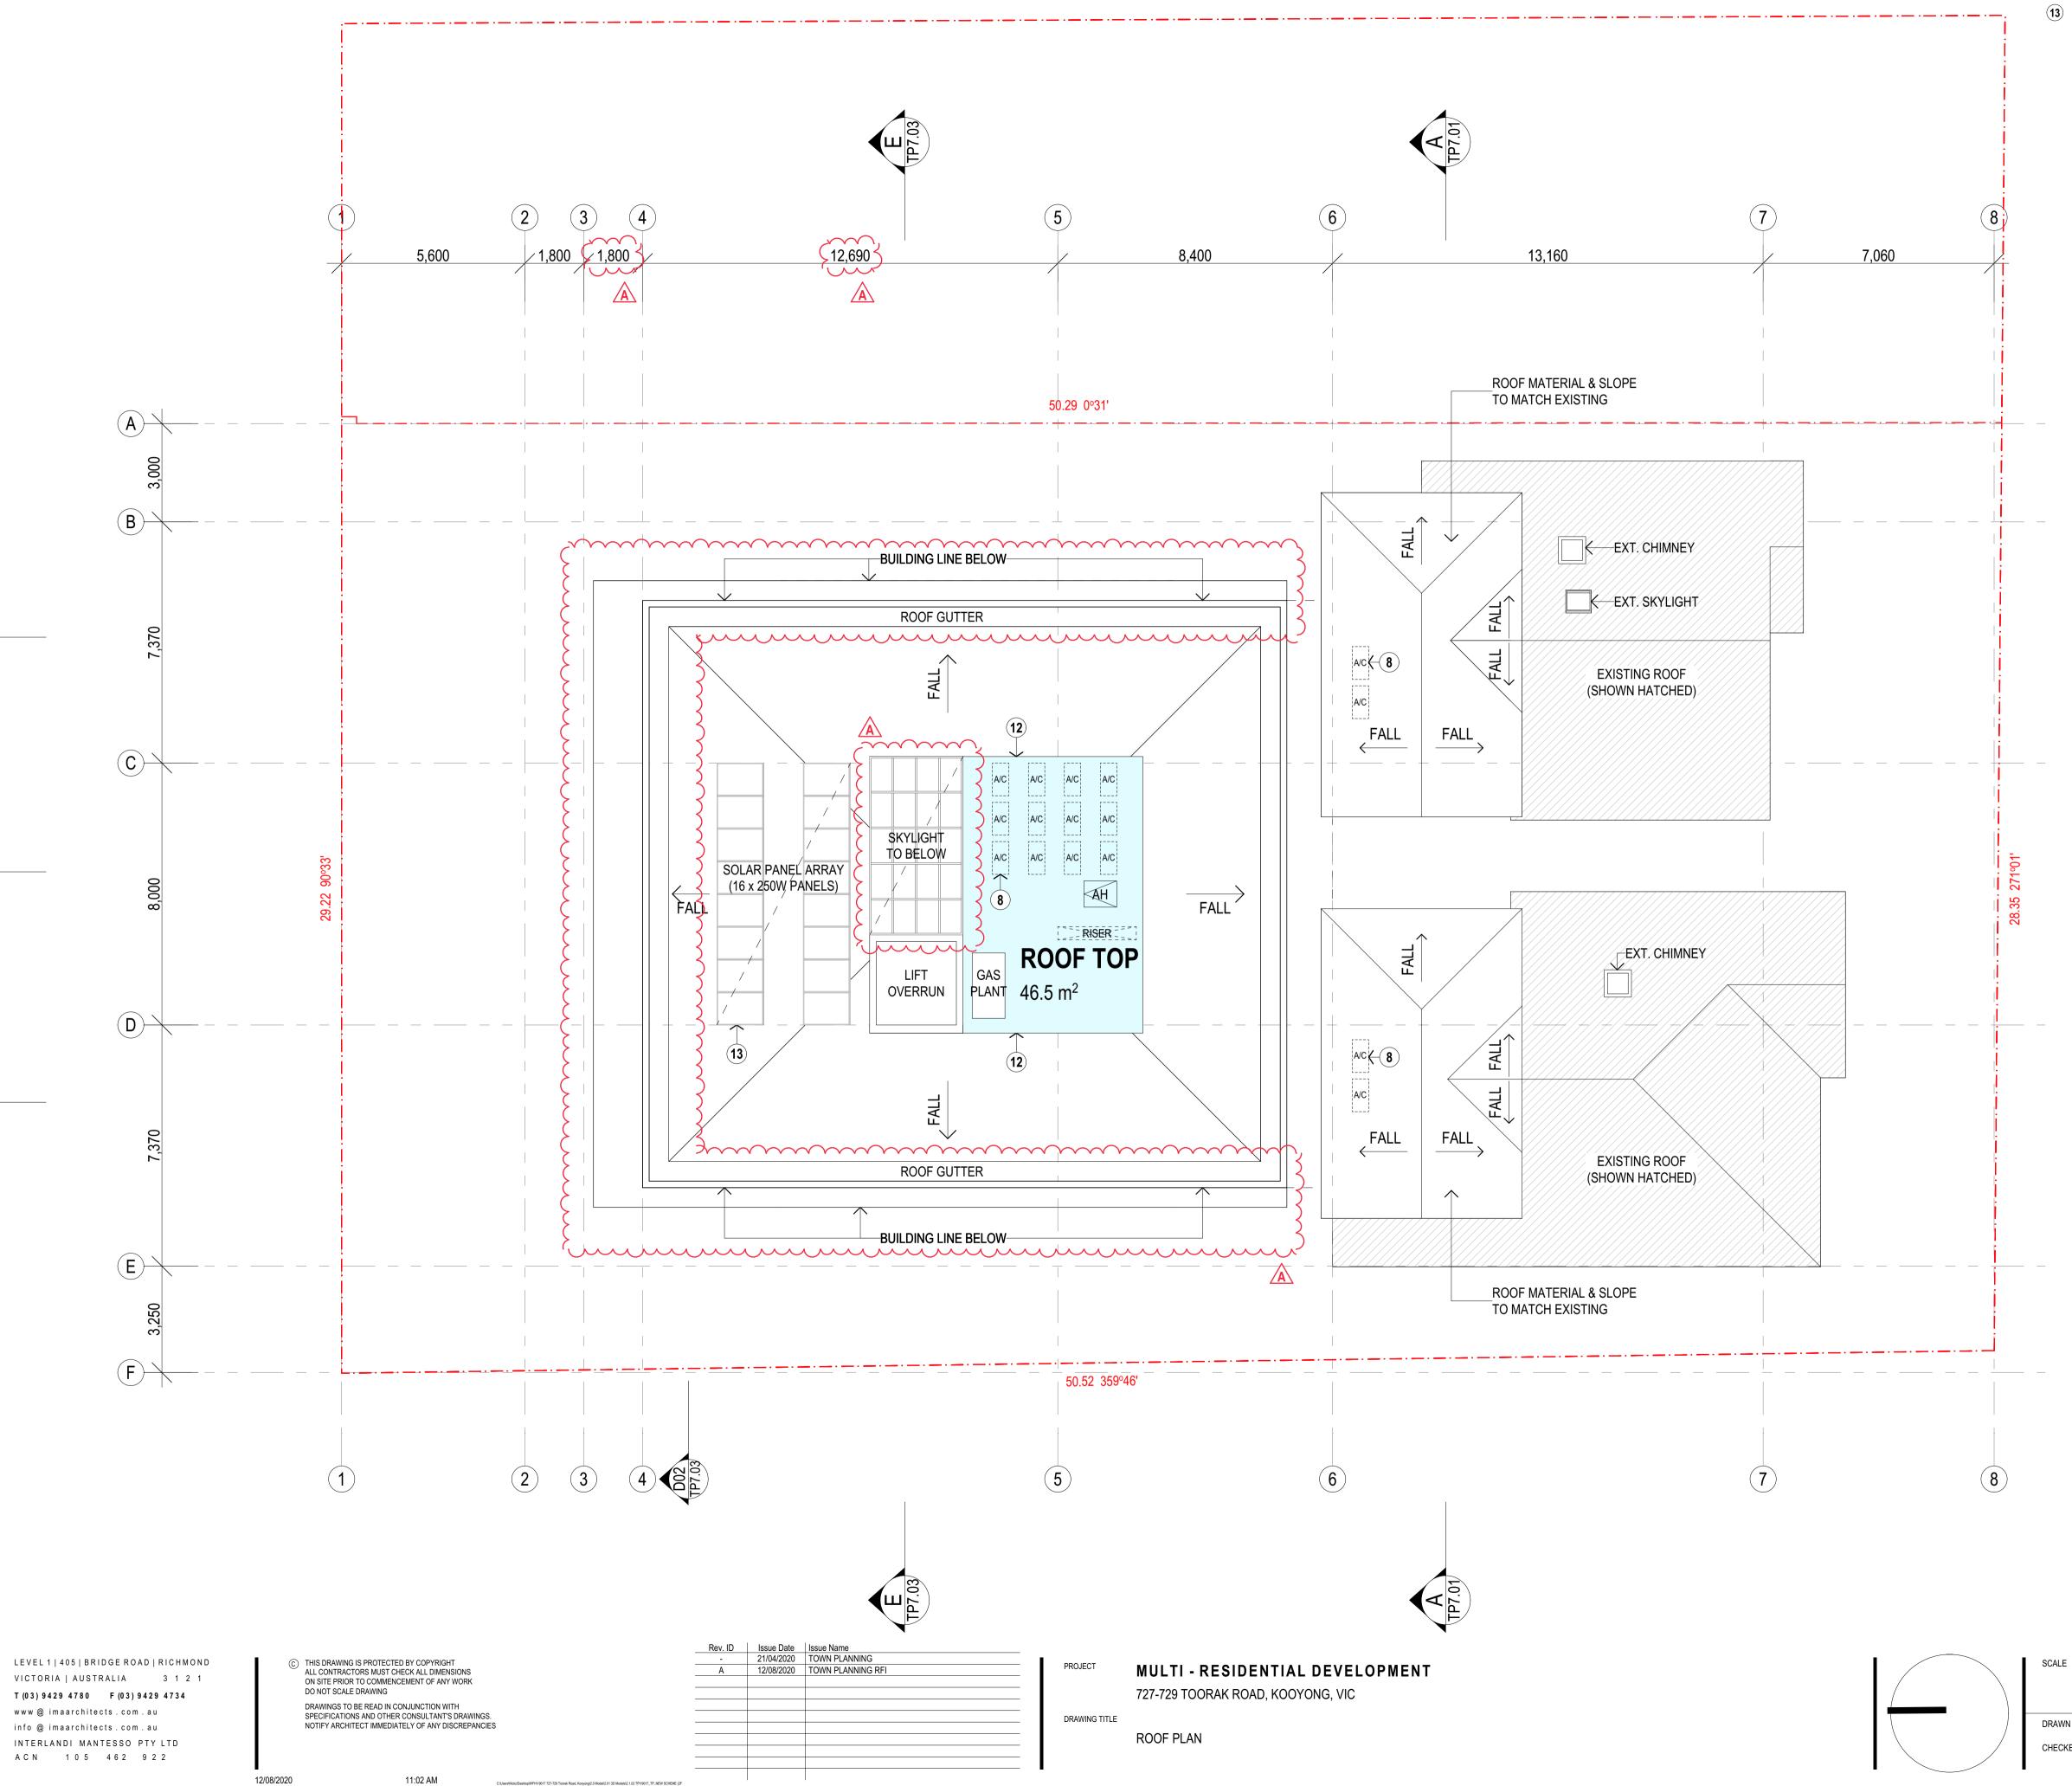



C:\Users\Nickz\E AMENDMENT).

## LEGEND


- (8) AIR-CONDITIONING CONDENSORS
- (12) PROPOSED POWDERCOATED ALUMINIUM PLANT SCRREN 'BRONZE"
- (13) SOLAR PANEL ARRAY

SCALE	1:100@A1 1:200@A3	DATE JOB NO.	AUG. 2020 19017	
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CHECKED	RF	REV.	A (12/08/2020)	

NOTE:

TOTAL 732m<sup>2</sup> ROOF AREA TO BE CONNECTED TO PROPOSED R.W.T.

·····

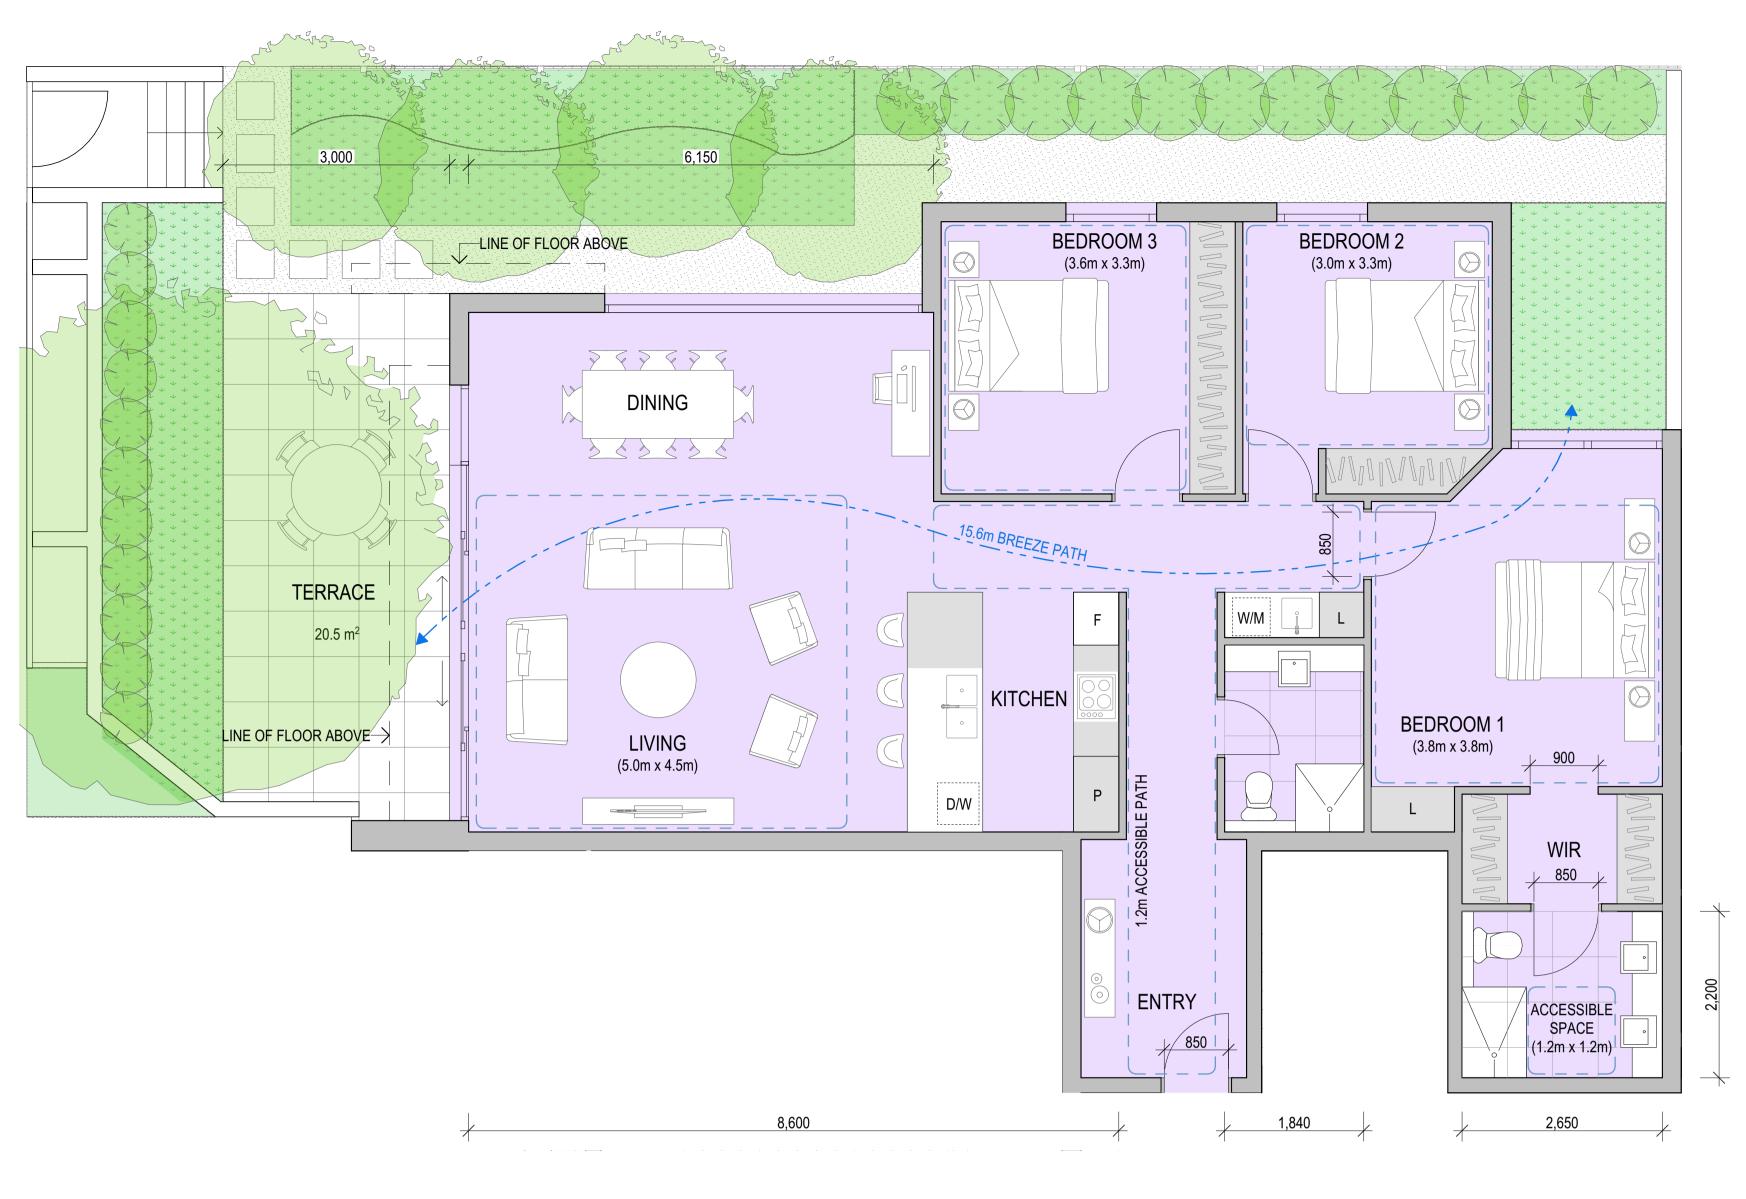

### UNIT TYPE 1 - ACCESSIBLE DWELLING.

2
142.7m <sup>2</sup>
20.5m <sup>2</sup>
17.9m <sup>3</sup> (SHOWN AS GREY)


APPLICABLE TO: G01, G04 & 101, 104 (SIMILAR)



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2:14 PM



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-	21/04/2020	TOWN PLANNING
A	24/08/2020	TOWN PLANNING RFI
В	7/10/2020	TOWN PLANNING RFI 2nd
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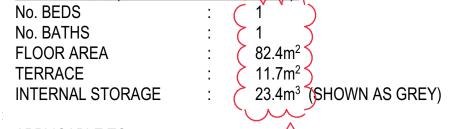
PROJECT MULTI - RESIDENTIAL DEVELOPMENT 727-729 TOORAK ROAD, KOOYONG, VIC 4,500

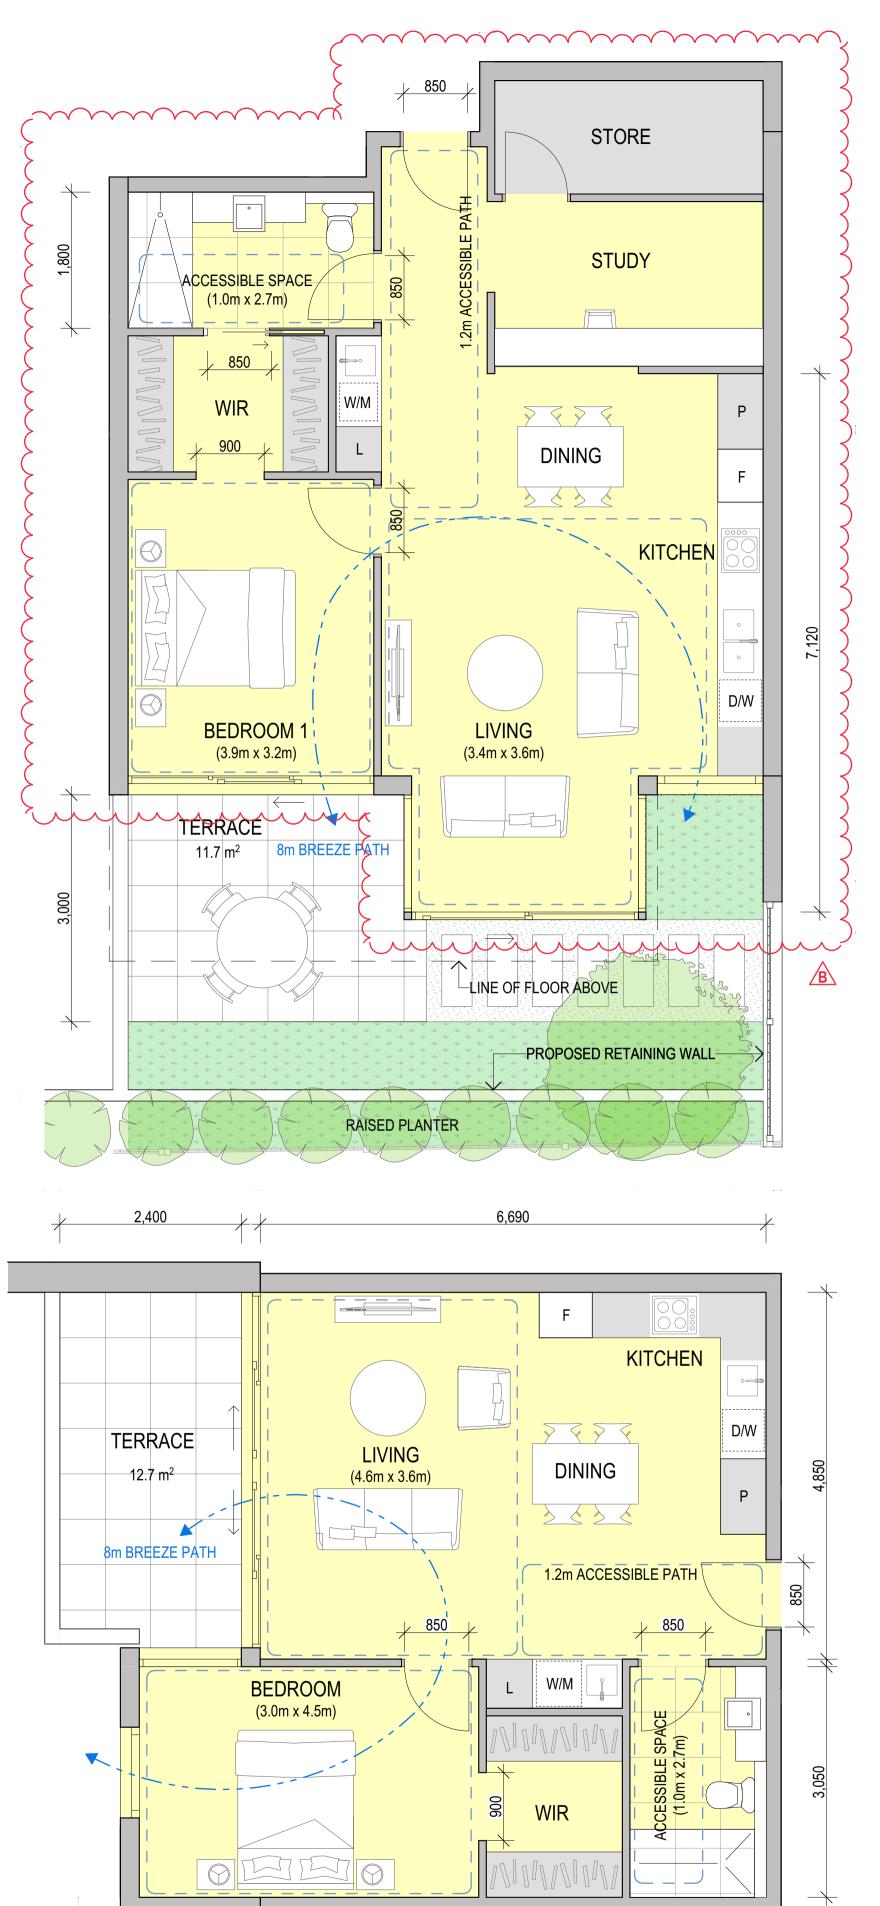TYPICAL UNIT LAYOUT

DRAWING TITLE



B



UNIT TYPE 3 - (ACCESSIBLE DWELLING)

APPLICABLE TO: G02, G03

UNIT TYPE 3A - (ACCESSIBLE DWELLING).


No. BEDS	:	1
No. BATHS	:	1
FLOOR AREA	:	64m <sup>2</sup>
TERRACE	:	12.7m <sup>2</sup>
INTERNAL STORAGE	:	8.7m <sup>3</sup> (SHOWN AS GREY)
		· · · ·

APPLICABLE TO: 105

1,800	
	~

S
C


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[	DRAWN	NZ	DWG NO.	TP5.07
(	CHECKED	RF	REV.	B (7/10/2020)

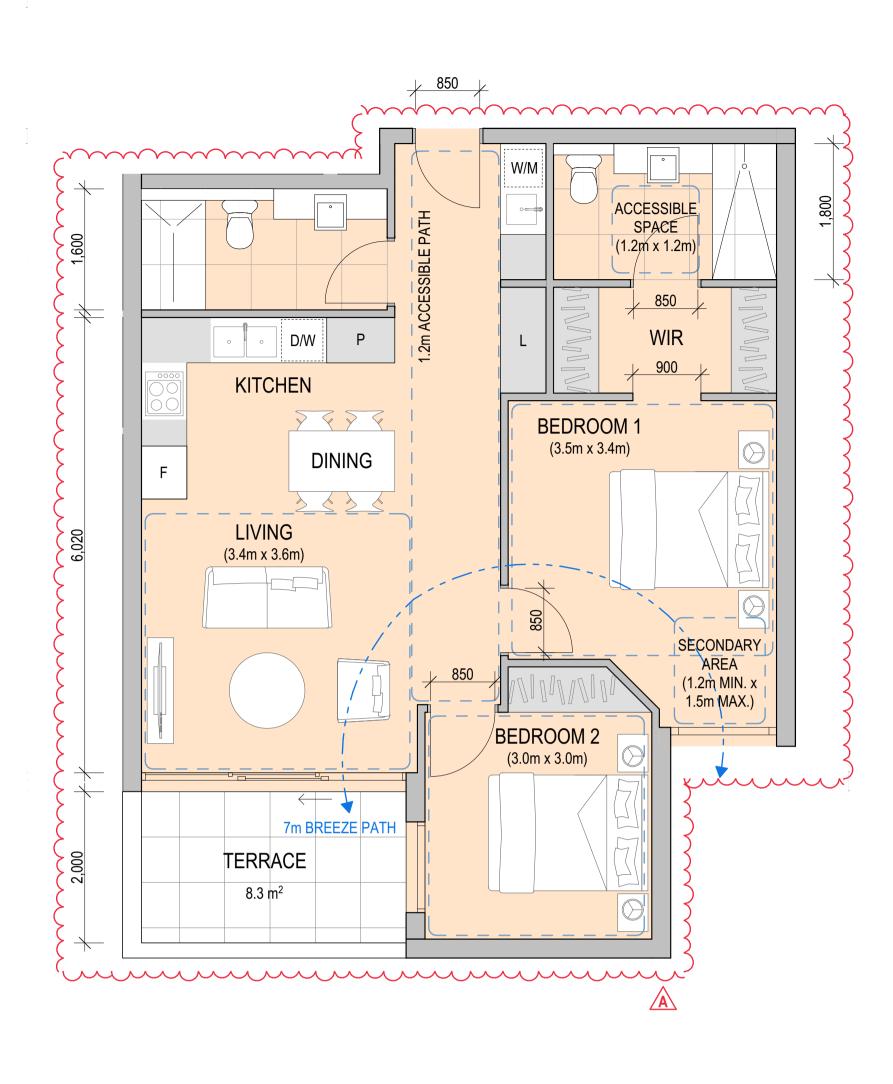

## UNIT TYPE 2B - (ACCESSIBLE DWELLING).

No. BEDS No. BATHS FLOOR AREA TERRACE INTERNAL STORAGE

APPLICABLE TO: 102, 103

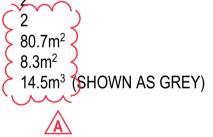




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C:UsersINick2DesktopIWFH19017 727-729 Toorak Road, Kooyongl2.0 Model2.01 3D Models2.1.02 TP19017\_TP\_NEW SCHEME (2F AMENDMENT).pin

12/08/2020




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-	21/04/2020	TOWN PLANNING	
А	12/08/2020	TOWN PLANNING RFI	PROJECT
			DRAWING TITLE

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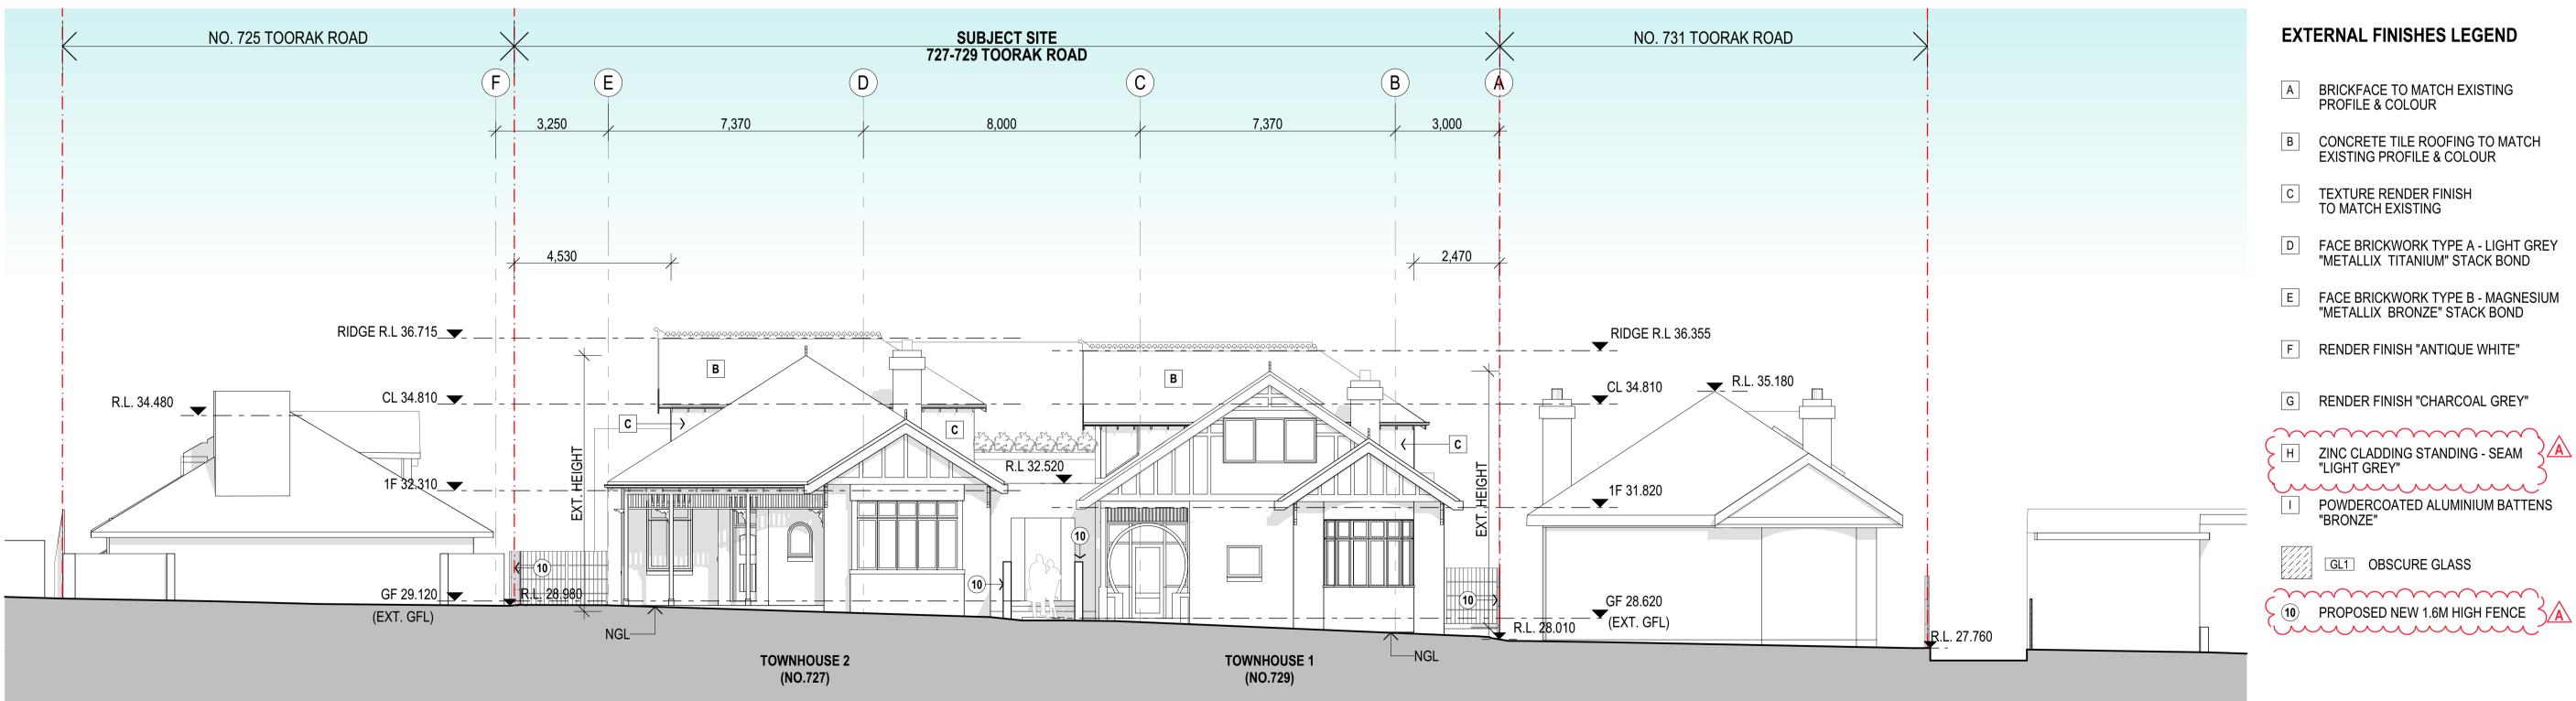
PROJECT MULTI - RESIDENTIAL DEVELOPMENT 727-729 TOORAK ROAD, KOOYONG, VIC

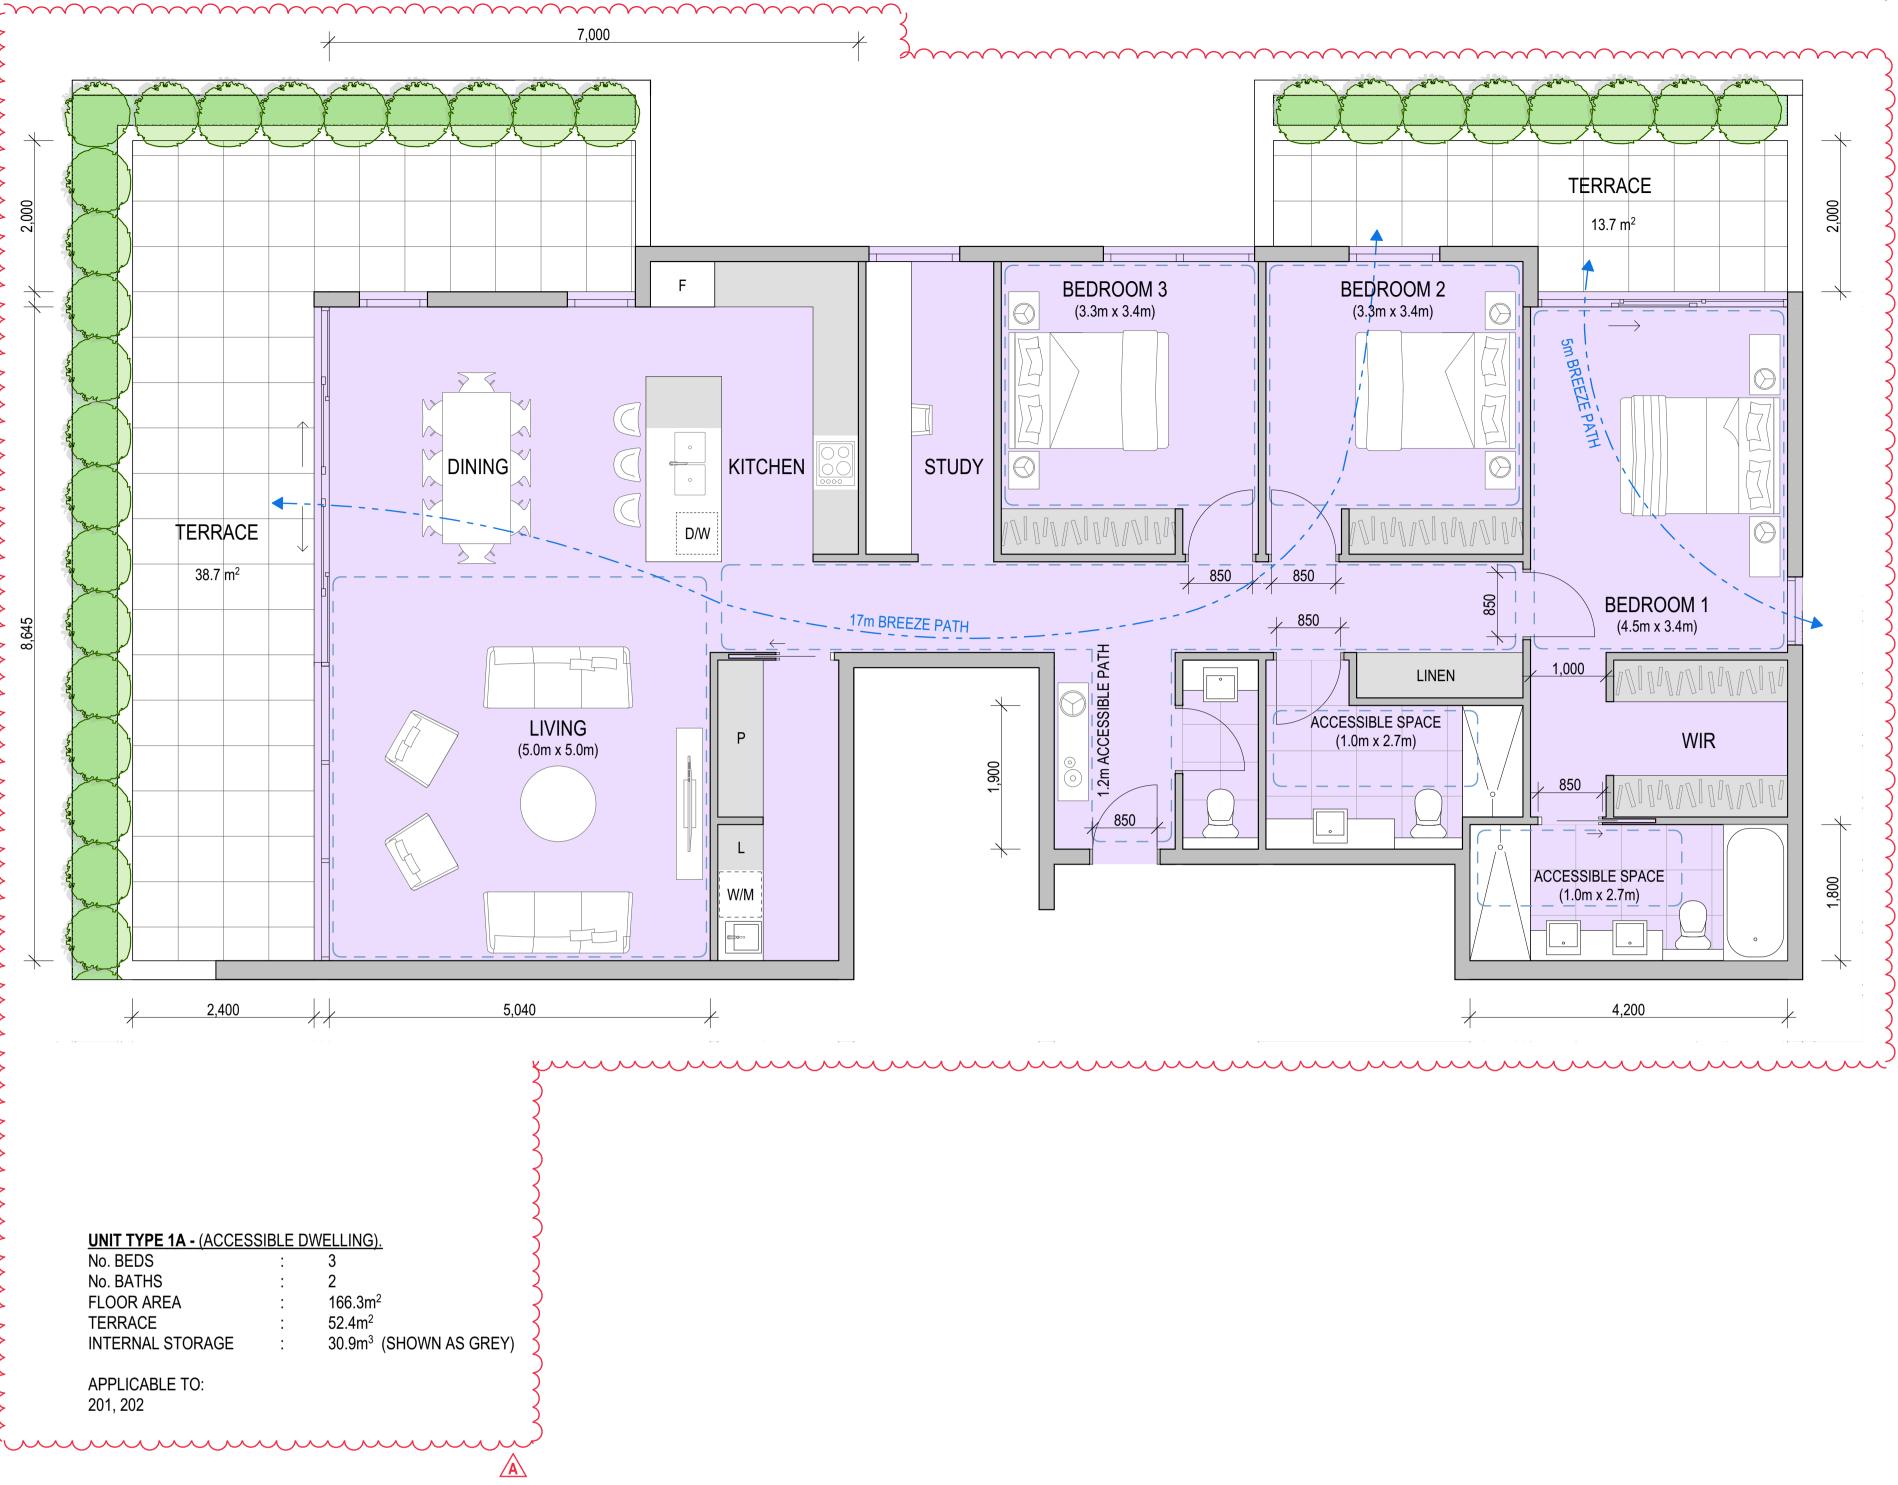TYPICAL UNIT LAYOUT



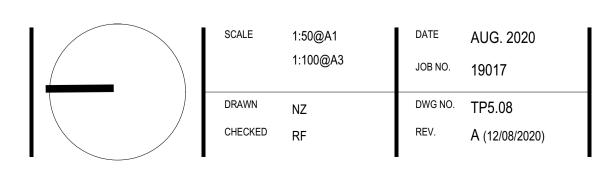

# **EXISTING ELEVATION - TOORAK ROAD** (WITHOUT FENCE)



# **PROPOSED SOUTH ELEVATION -TOORAK ROAD** (WITHOUT FENCE)

12/08/2020



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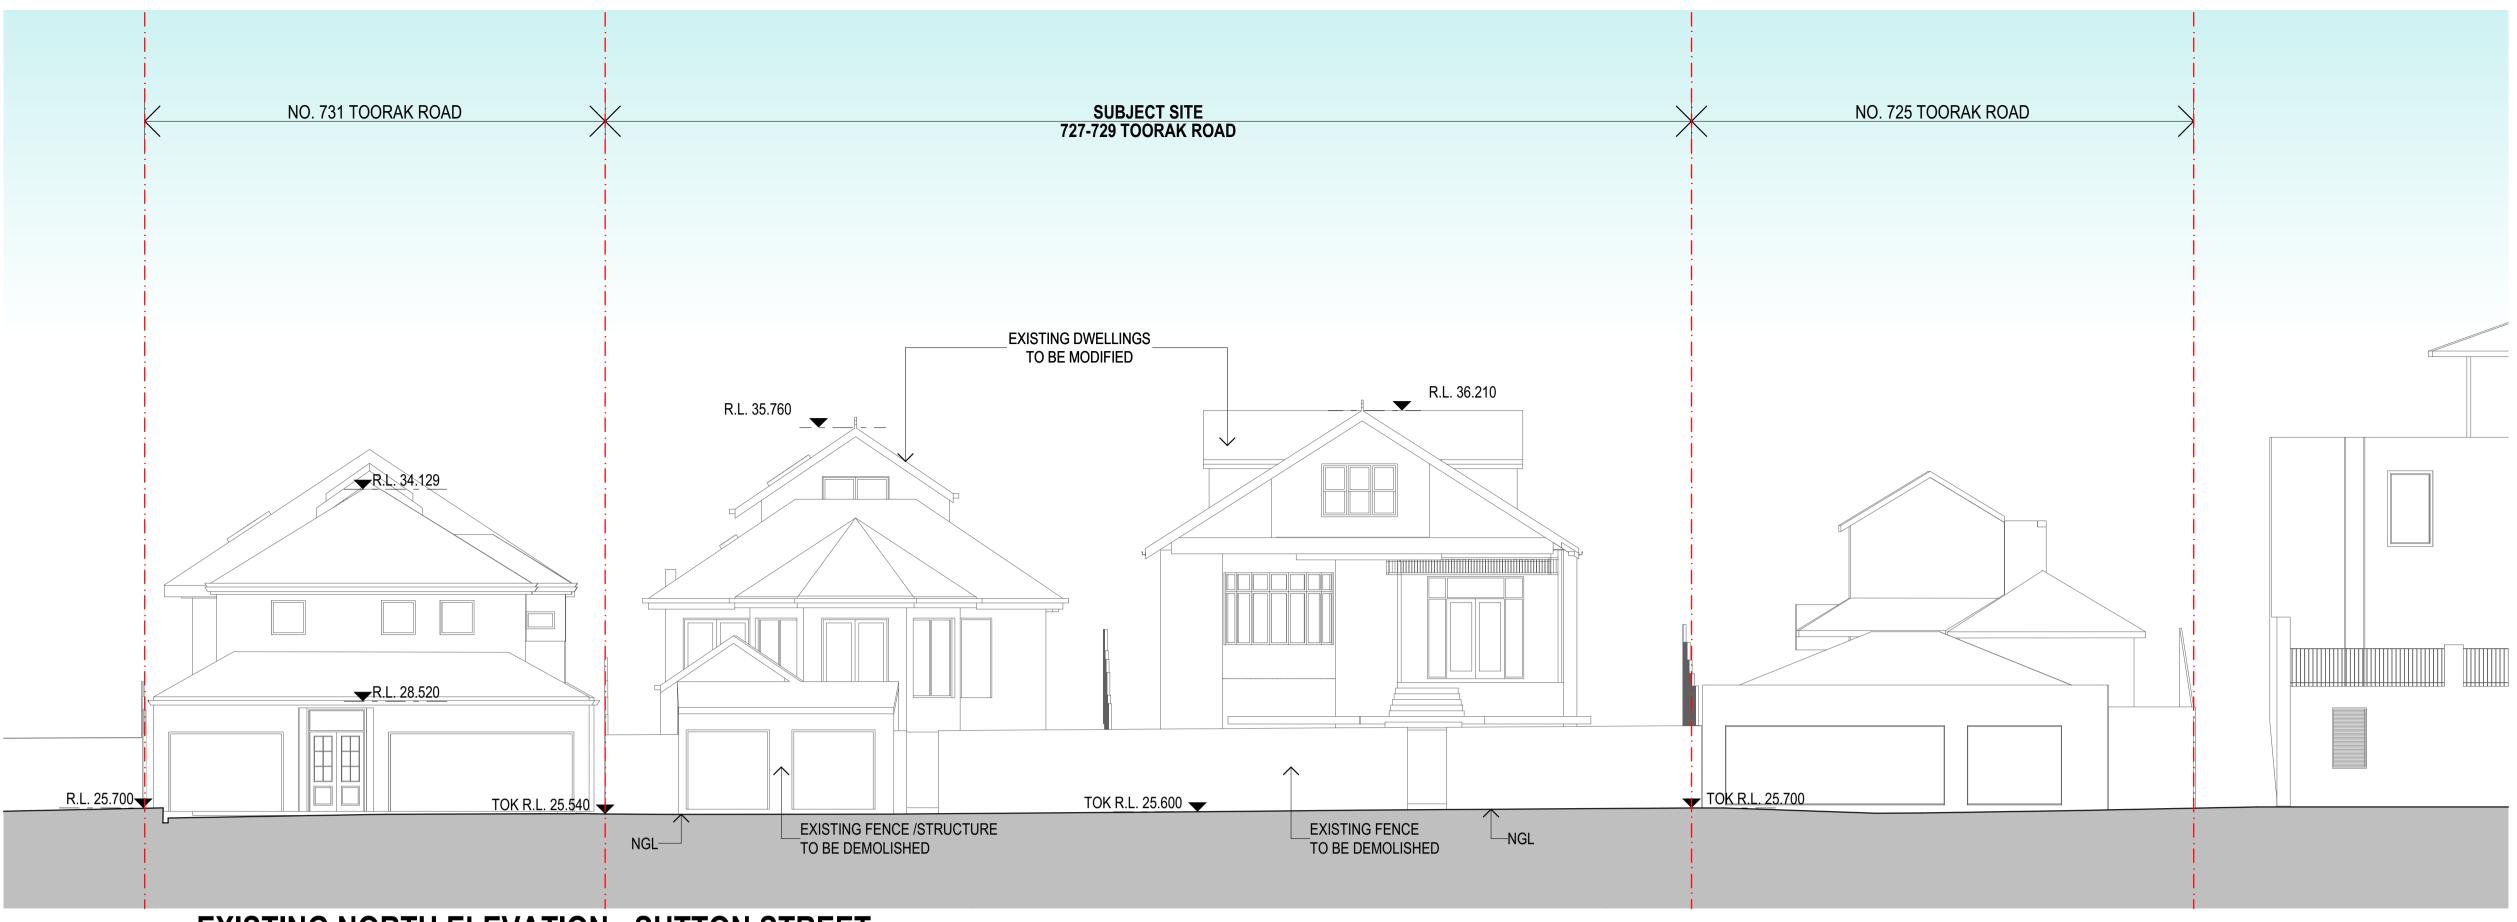
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Rev. ID	Issue Date	Issue Name
-	21/04/2020	TOWN PLANNING
Α	12/08/2020	TOWN PLANNING RFI


PROJECT MULTI - RESIDENTIAL DEVELOPMENT 727-729 TOORAK ROAD, KOOYONG, VIC

ELEVATIONS

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# **EXISTING NORTH ELEVATION - SUTTON STREET**



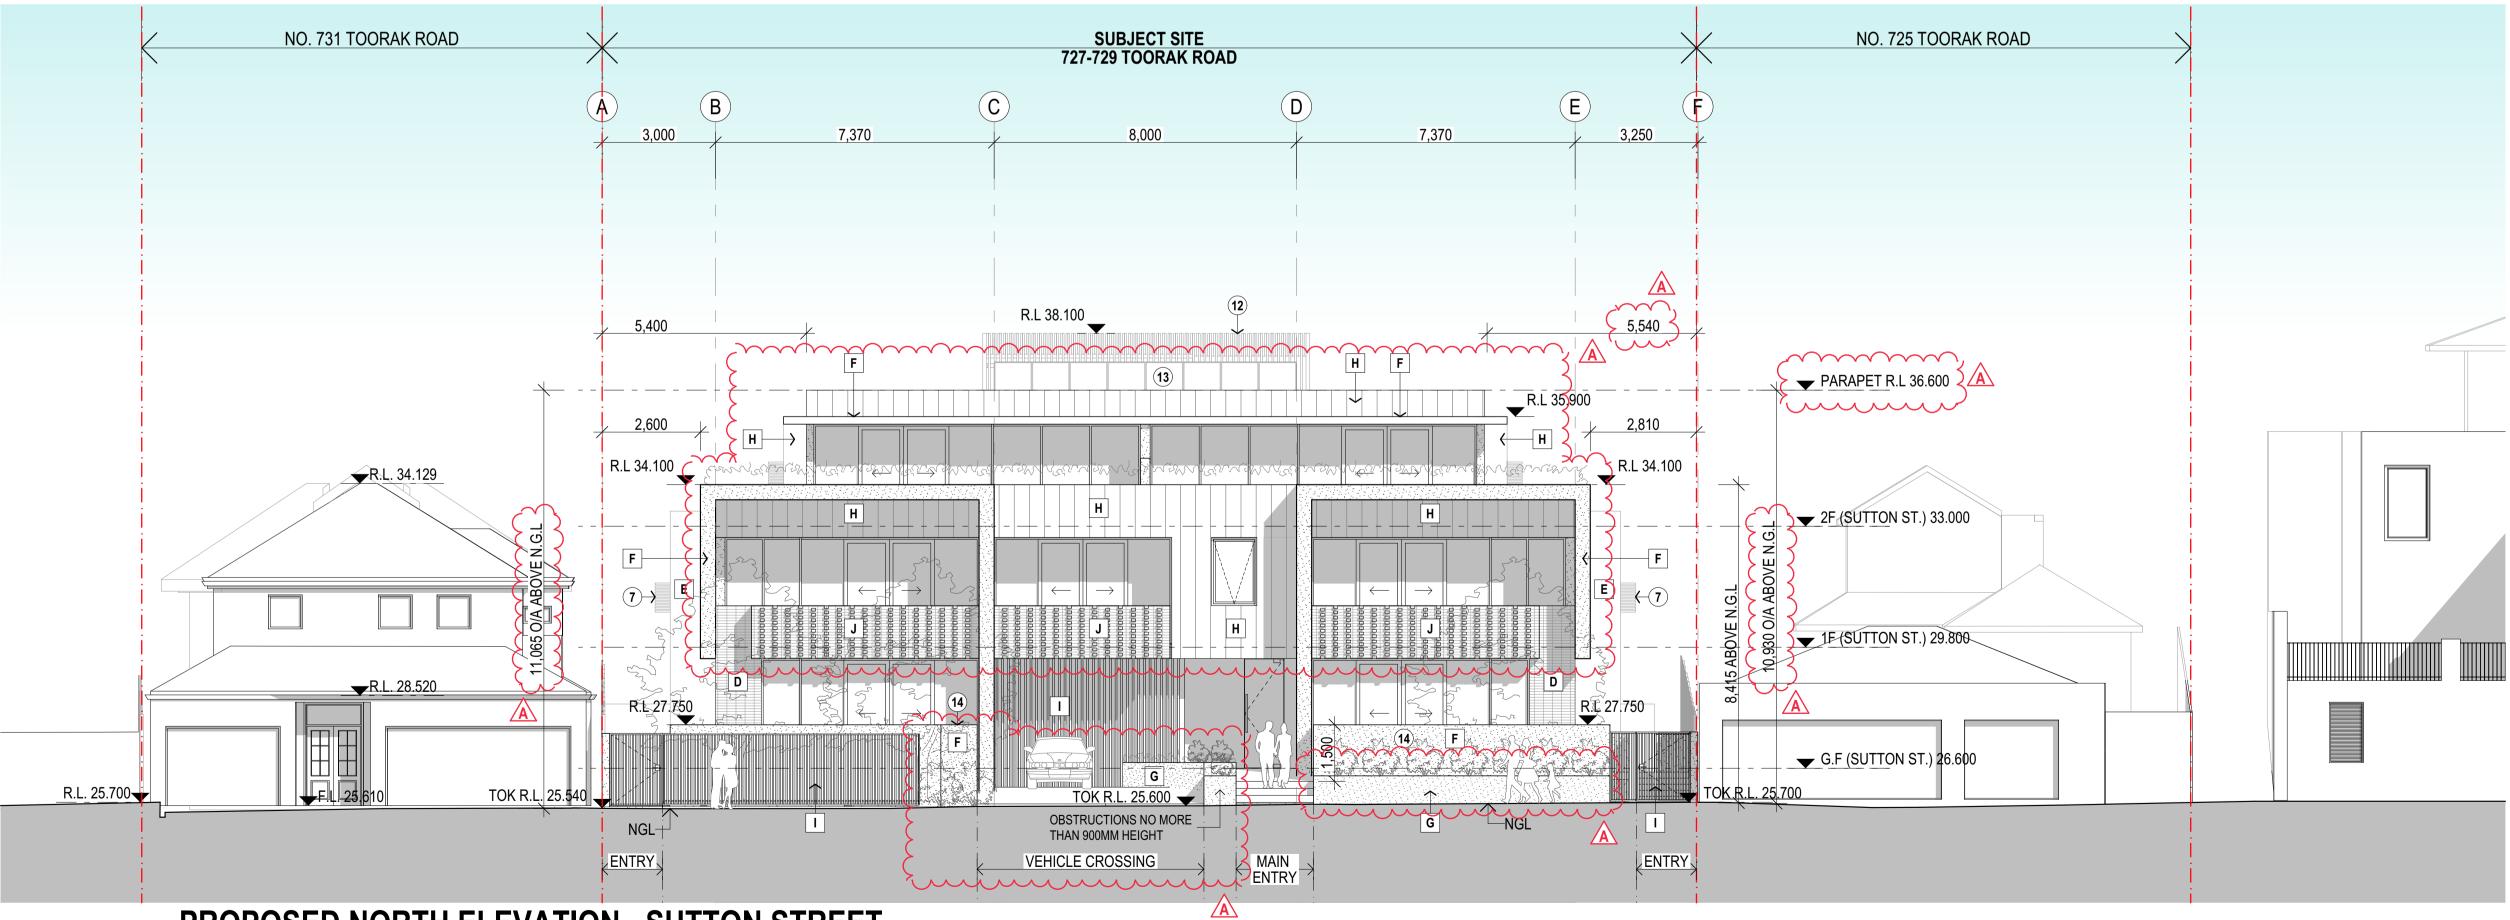

12/08/2020



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MULTI - RESIDENTIAL DEVELOPMENT 727-729 TOORAK ROAD, KOOYONG, VIC

ELEVATIONS

PROJECT

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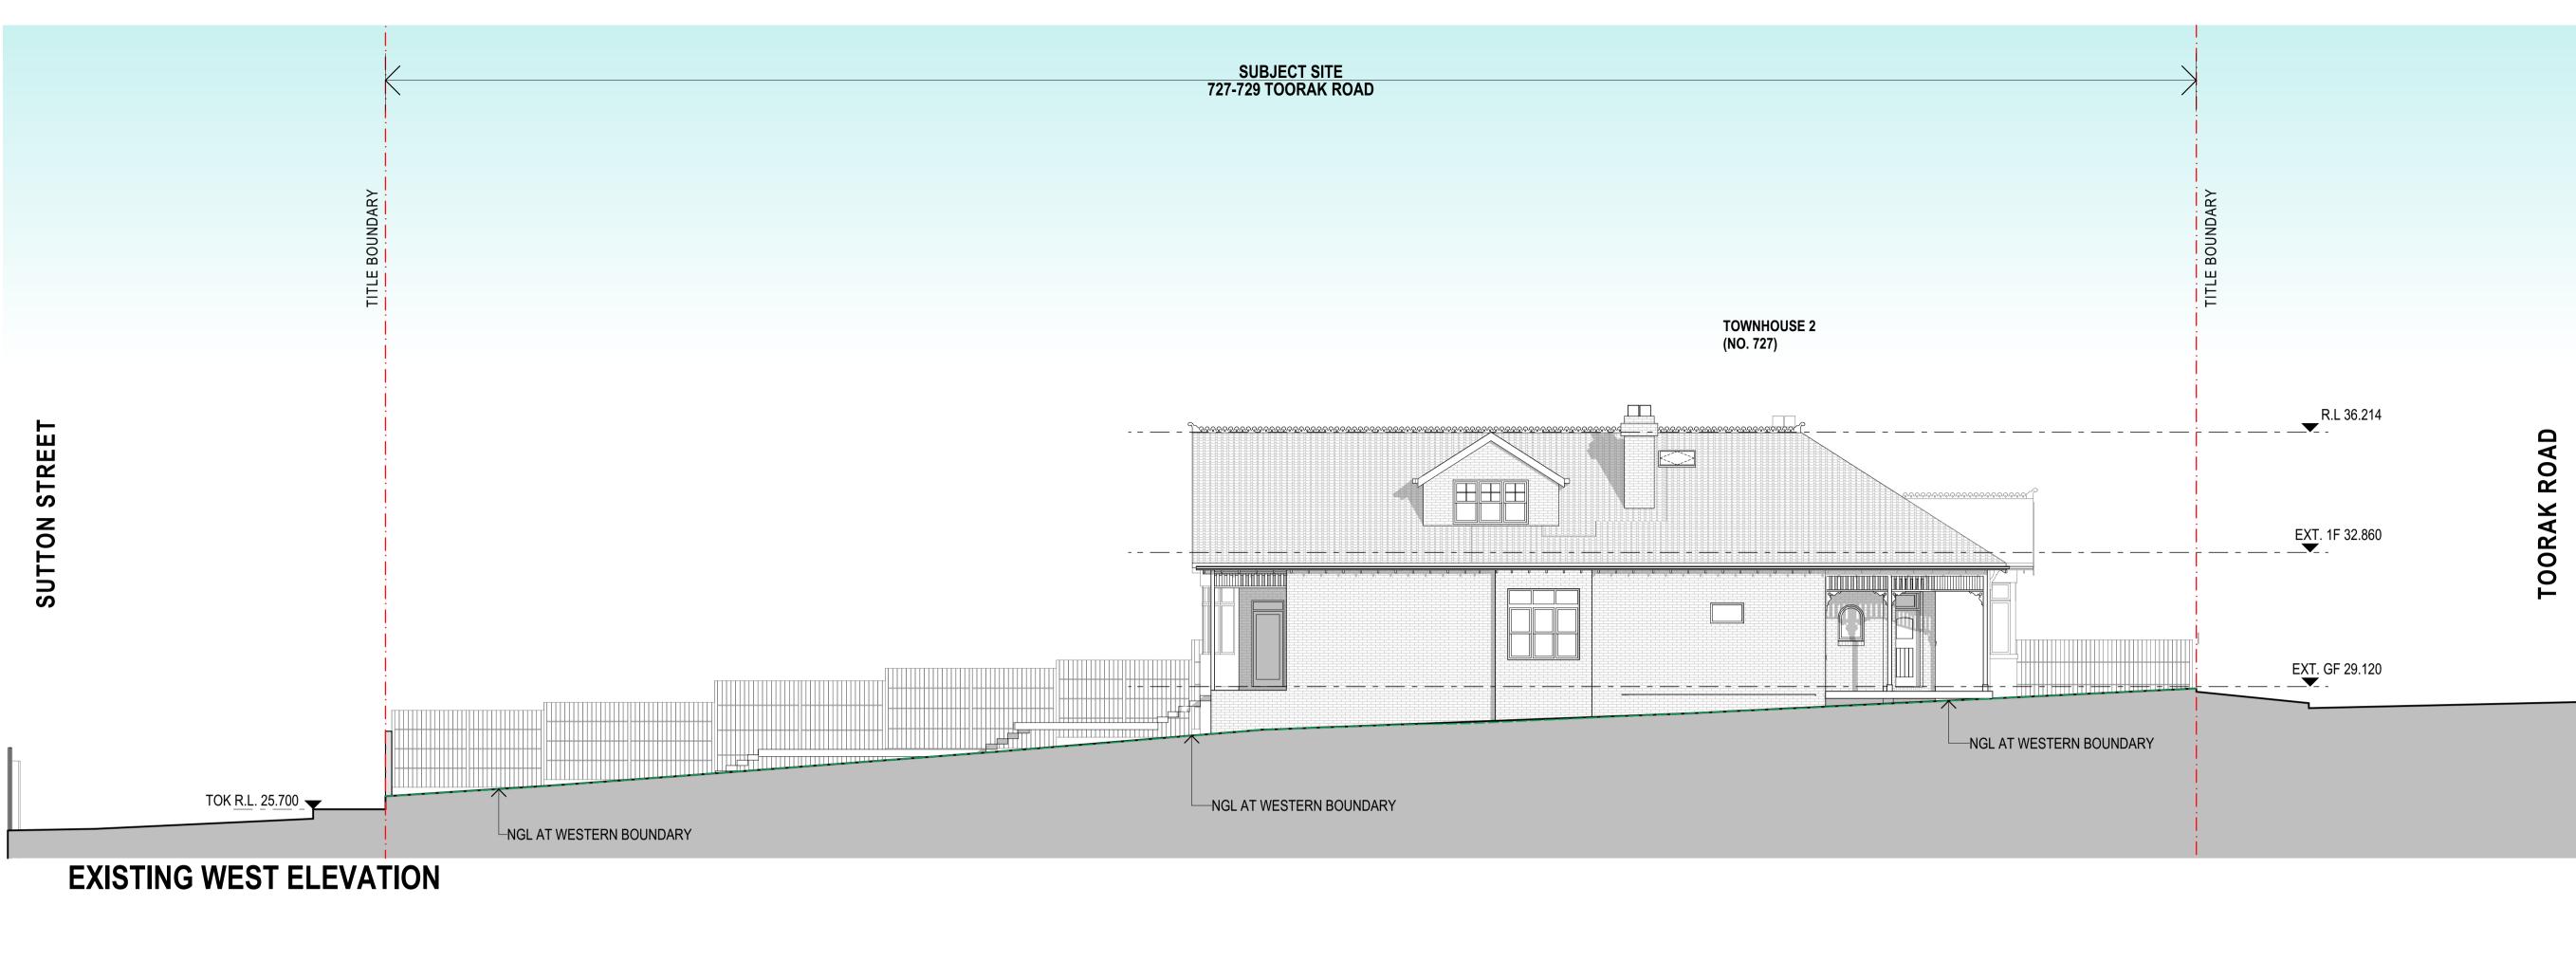
## EXTERNAL FINISHES LEGEND


- A BRICKFACE TO MATCH EXISTING PROFILE & COLOUR
- B CONCRETE TILE ROOFING TO MATCH EXISTING PROFILE & COLOUR
- C TEXTURE RENDER FINISH TO MATCH EXISTING
- D FACE BRICKWORK TYPE A LIGHT GREY "METALLIX TITANIUM" STACK BOND
- E FACE BRICKWORK TYPE B MAGNESIUM "METALLIX BRONZE" STACK BOND
- F RENDER FINISH "ANTIQUE WHITE"

G RENDER FINISH "CHARCOAL GREY"

- H ZINC CLADDING STANDING - SEAM "LIGHT GREY" POWDERCOATED ALUMINIUM BATTENS "BRONZE" FACE BRICKWORK TYPE C - LIGHT GREY "METALLIX TITANIUM" STACK BOND WITH TESSELLATED BRICK FINISH
- GL1 OBSCURE GLASS
- (7) FIXED ALUMINIUM PRIVACY SCREEN DEVICE MAX. 25% OPENINGS - "BRONZE"
- (12) PROPOSED POWDERCOATED ALUMINIUM PLANT SCRREN 'BRONZE''
- (13) SOLAR PANEL ARRAY
- (14) PROPOSED NEW 1.5M HIGH FENCE

SCALE	1:100@A1	DATE	AUG. 2020
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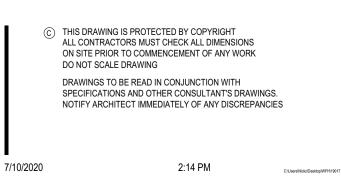


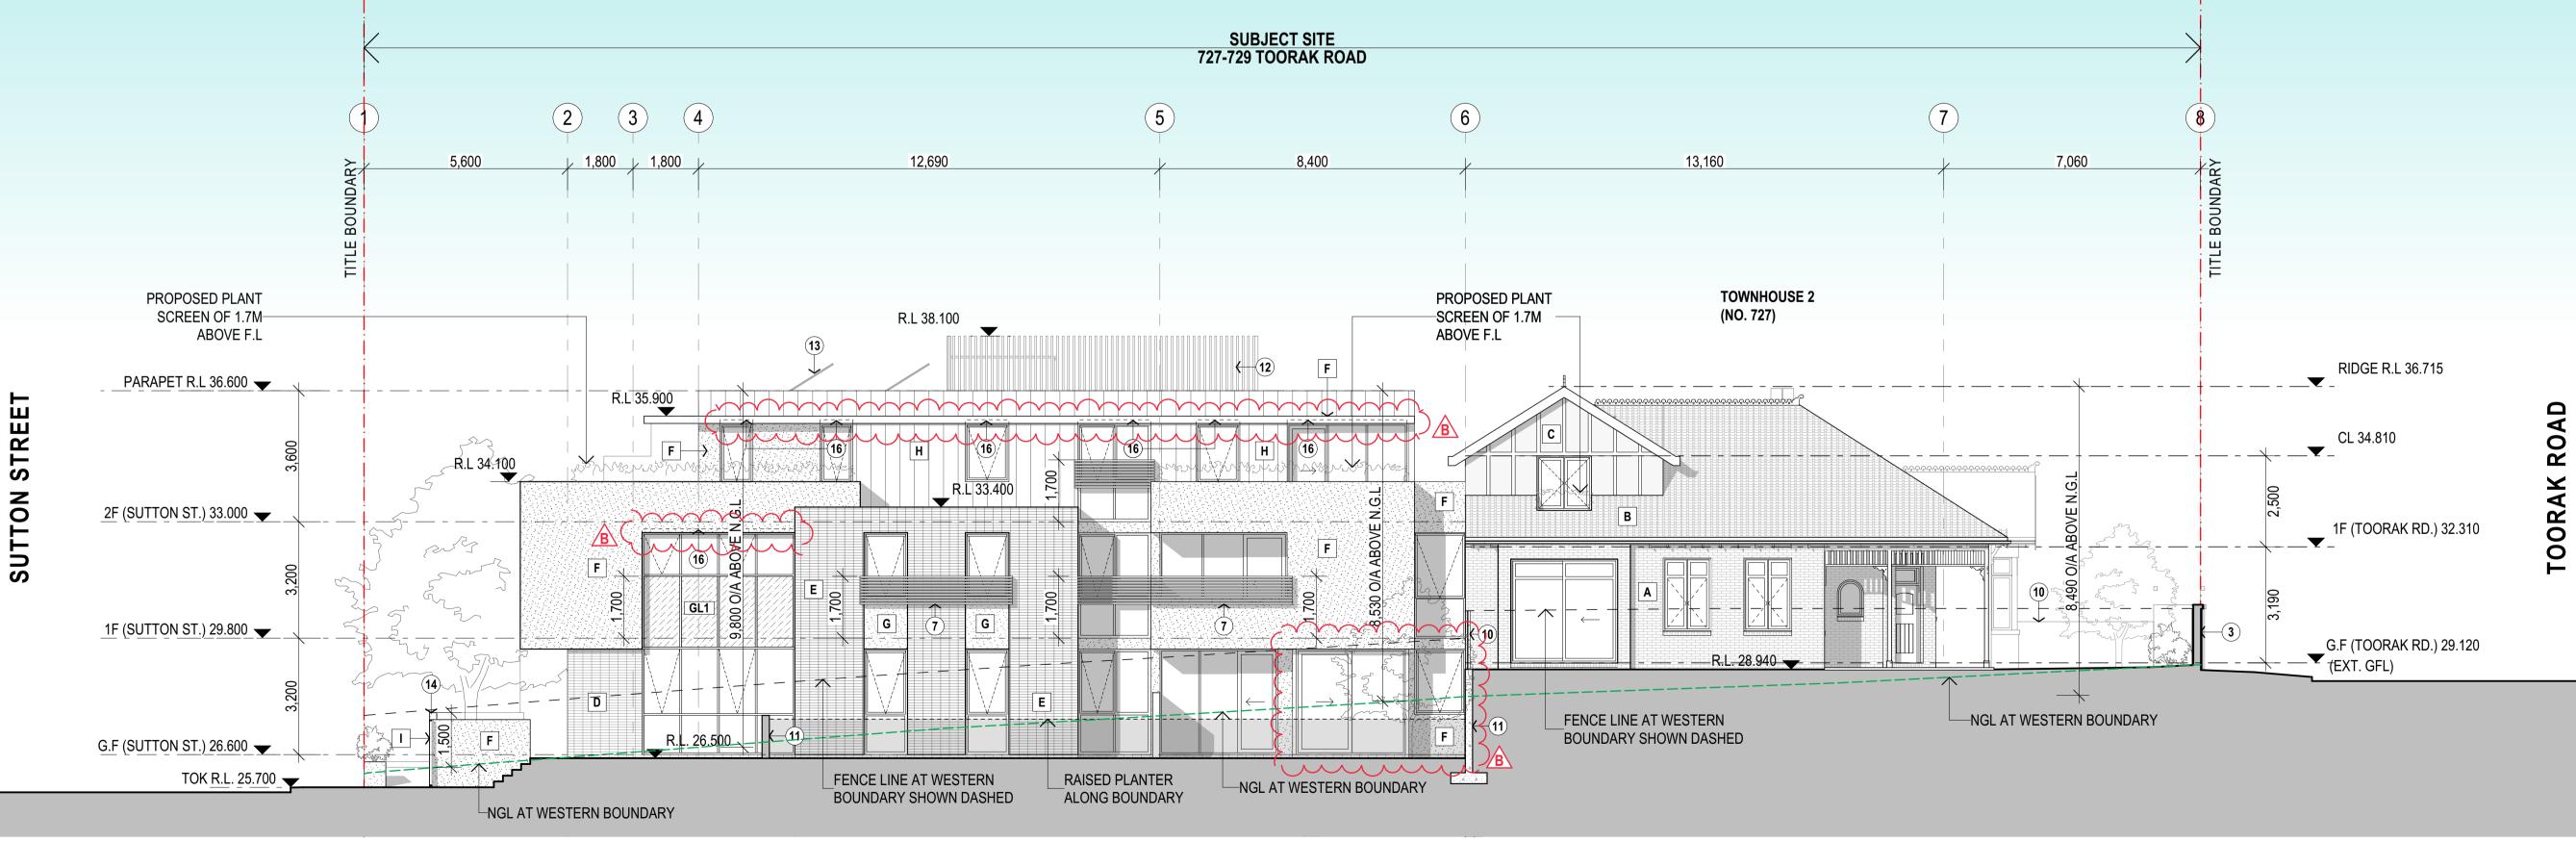

# **PROPOSED WEST ELEVATION**



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MULTI - RESIDENTIAL DEVELOPMENT 727-729 TOORAK ROAD, KOOYONG, VIC

ELEVATIONS

PROJECT


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### EXTERNAL FINISHES LEGEND


А	BRICKFACE TO MATCH EXISTING
	PROFILE & COLOUR

- B CONCRETE TILE ROOFING TO MATCH EXISTING PROFILE & COLOUR
- C TEXTURE RENDER FINISH TO MATCH EXISTING
- D FACE BRICKWORK TYPE A LIGHT GREY "METALLIX TITANIUM" STACK BOND
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- F RENDER FINISH "ANTIQUE WHITE"
- G RENDER FINISH "CHARCOAL GREY"
- H ZINC CLADDING STANDING SEAM "LIGHT GREY"
- POWDERCOATED ALUMINIUM BATTENS
   "BRONZE"
- GL1 OBSCURE GLASS
- (3) EXISTING 2M BRICK FENCE TO BE RETAINED (ALONG TOORAK ROAD)
- FIXED ALUMINIUM PRIVACY SCREEN DEVICE MAX. 25% OPENINGS - "BRONZE"
- (10) PROPOSED NEW 1.6M HIGH FENCE
- (11) PROPOSED RETAINING WALL
- (12) PROPOSED POWDERCOATED ALUMINIUM PLANT SCRREN - 'BRONZE"
- (13) SOLAR PANEL ARRAY

	(16 MOTORI RECESS SOFFIT E	SED EXTER ED WITH P EAVE OR B		
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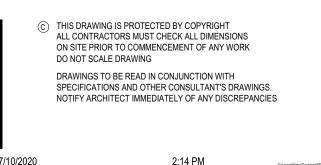
# **EXISTING EAST ELEVATION**

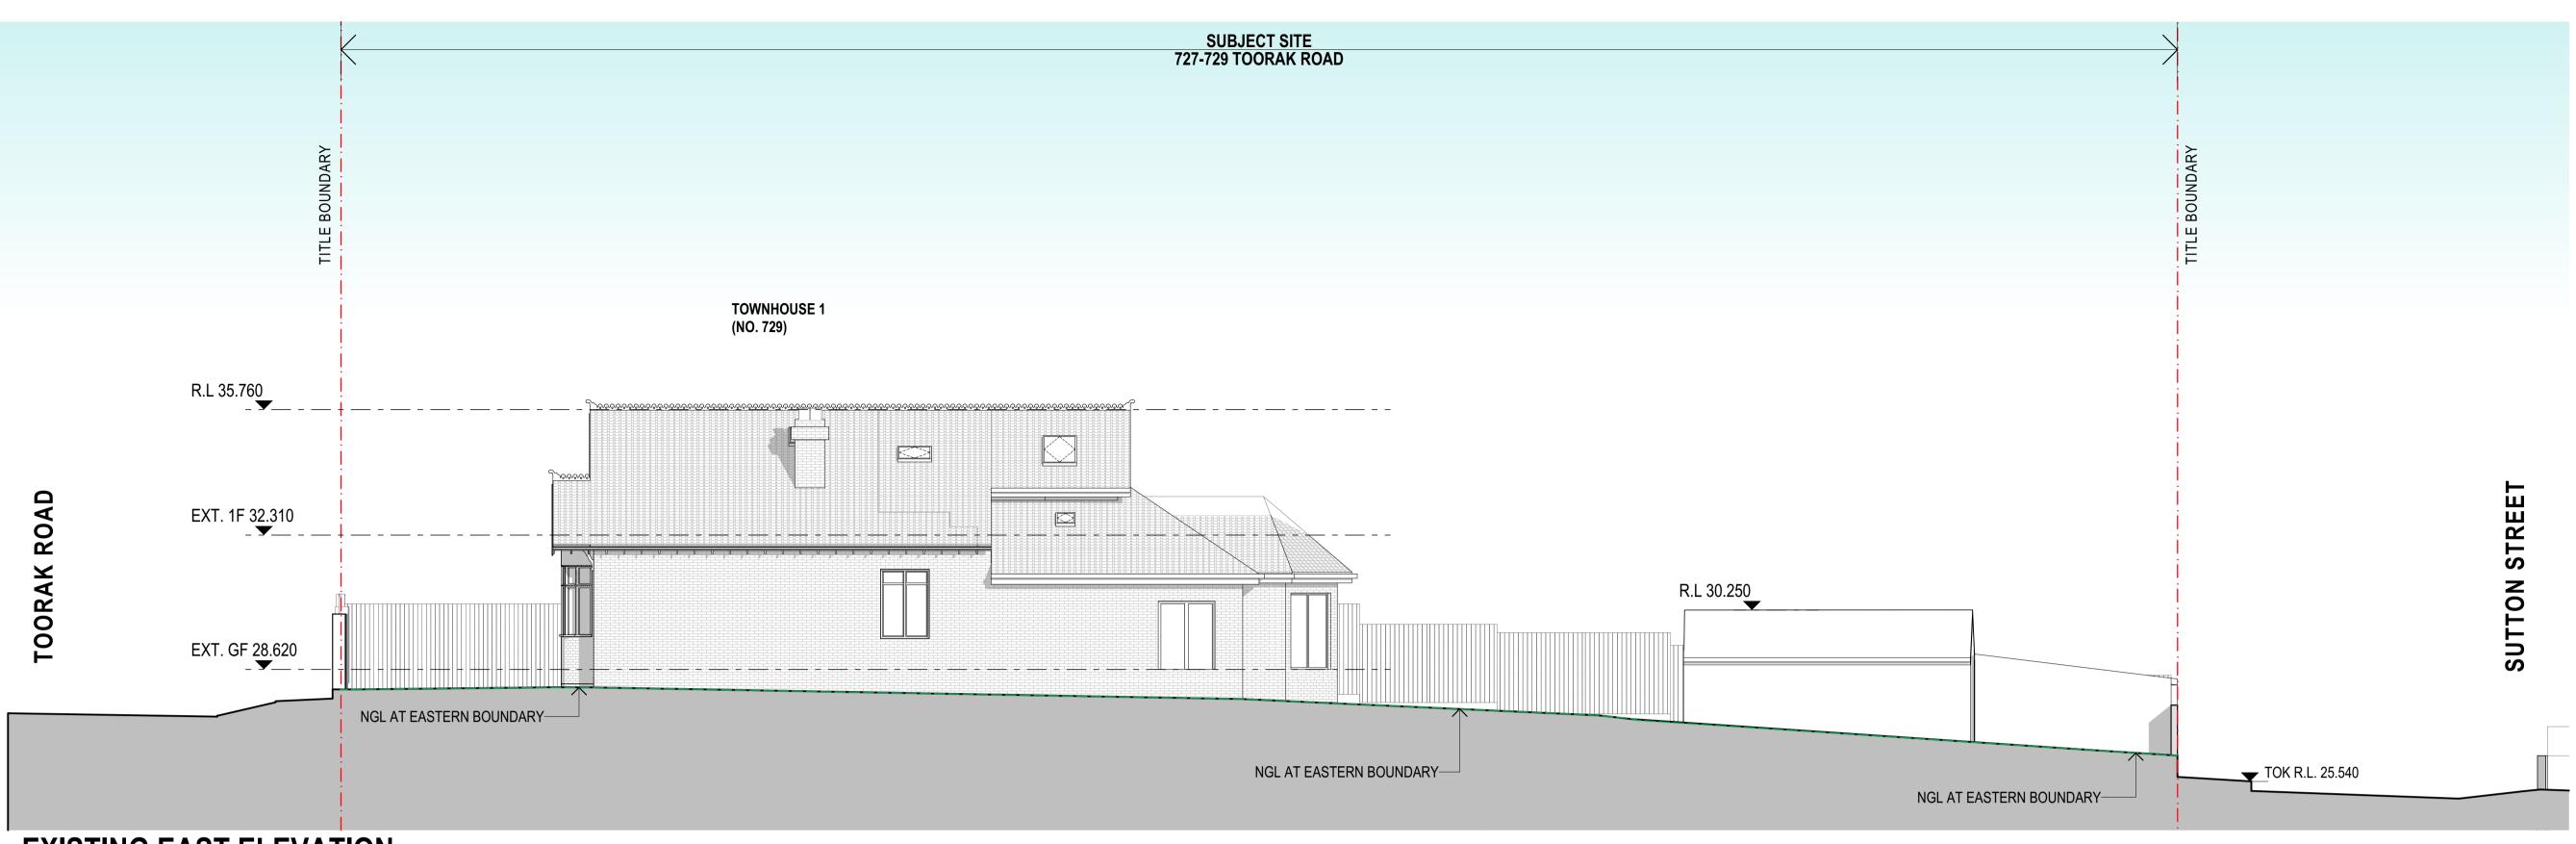

# **PROPOSED EAST ELEVATION**

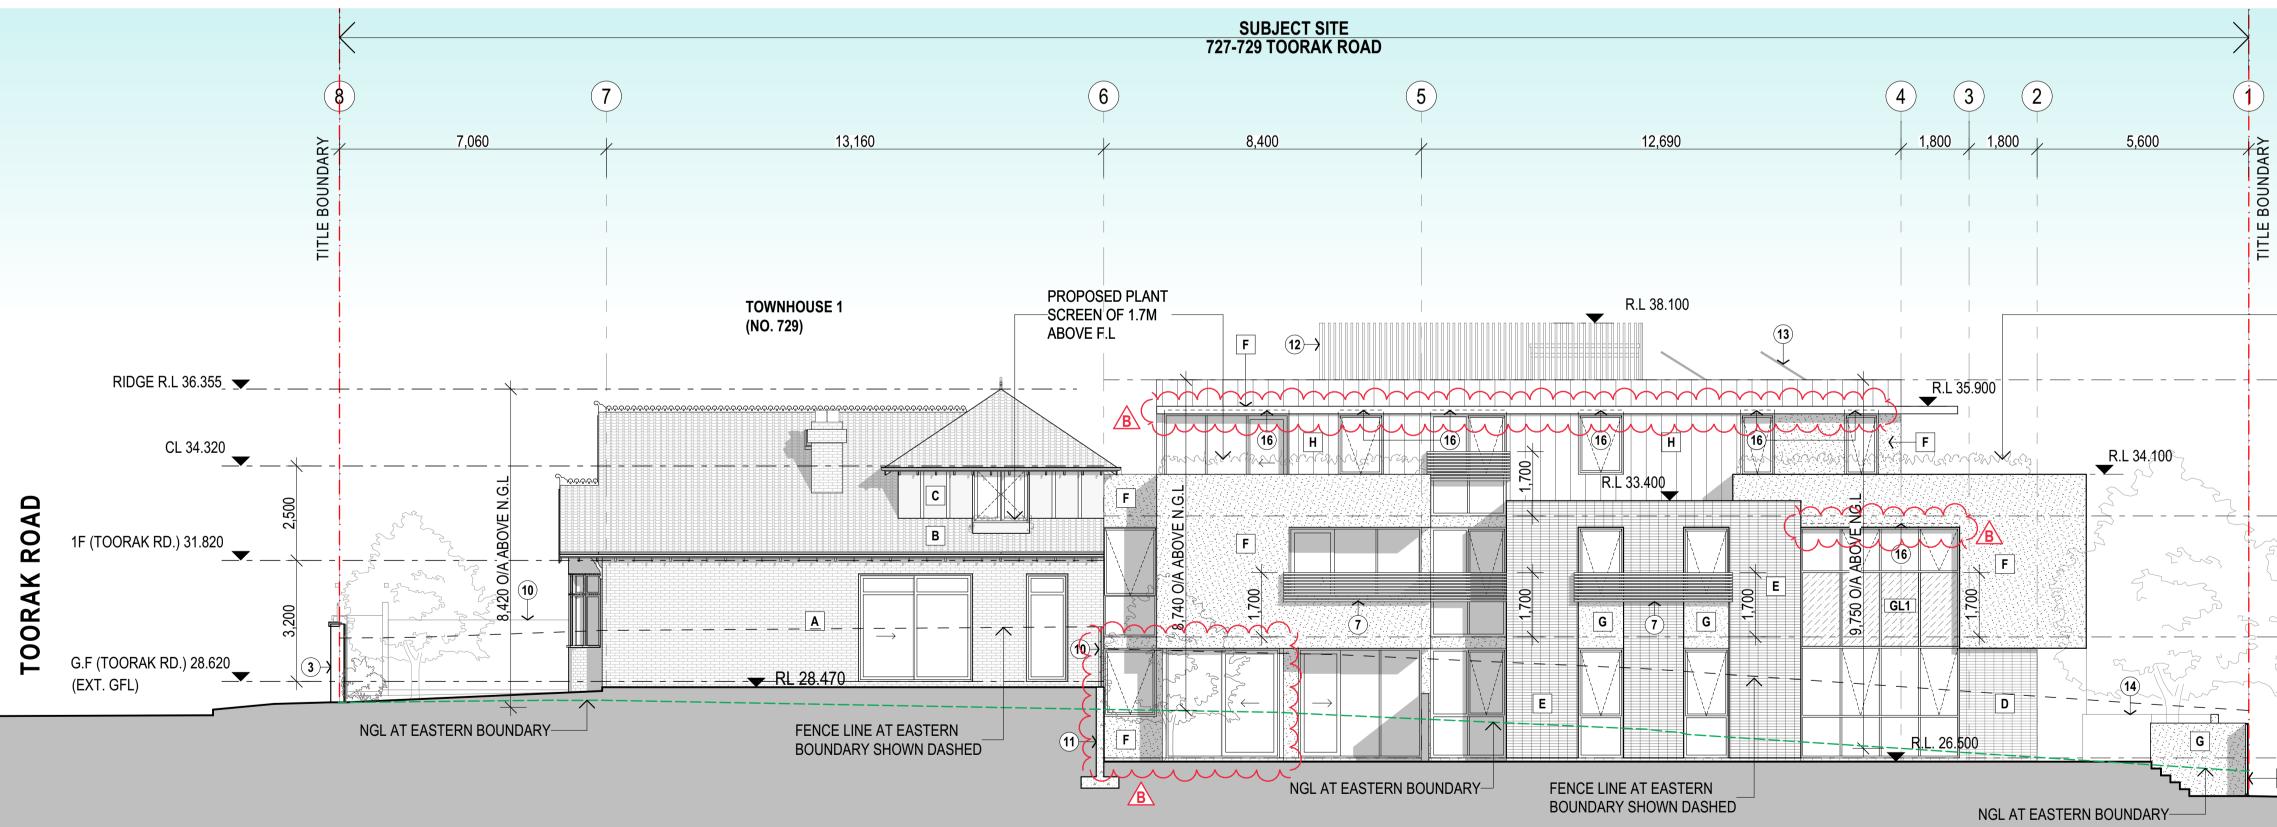

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MULTI - RESIDENTIAL DEVELOPMENT PROJECT 727-729 TOORAK ROAD, KOOYONG, VIC

ELEVATIONS

DRAWING TITLE

PROPOSED PLANT SCREEN OF 1.7M ABOVE F.L	
SCREEN OF 1.7M	
SCREEN OF 1.7M	
PARAPET R.L 36.600	
3,600	
<u>→ 2F (SUTTON ST.) 33.000</u>	
► 1F (SUTTON ST.) 29.800	
3,200 SI	
G.F (SUTTON ST.) 26.600	
TOK R.L. 25.540	

## **EXTERNAL FINISHES LEGEND**

A		CE TO MAT & COLOUF	TCH EXISTING	
В		TE TILE RO G PROFILE	OOFING TO MATCH & COLOUR	
С		E RENDER CH EXISTIN		
D			TYPE A - LIGHT GRE IM" STACK BOND	ΞY
Ε			TYPE B - MAGNESIL E" STACK BOND	JM
F	RENDER	FINISH "AN	NTIQUE WHITE"	
G	RENDER	FINISH "CH	HARCOAL GREY"	
Η	ZINC CLA "LIGHT G		ANDING - SEAM	
1	POWDEF "BRONZE		LUMINIUM BATTEN	S
	GL1	OBSCURE	GLASS	
3		G 2M BRICK TOORAK R	( FENCE TO BE RET OAD)	AINED
7			PRIVACY SCREEN DPENINGS - "BRONZ	Έ"
10	PROPOS	ED NEW 1.0	6M HIGH FENCE	
(11)	PROPOS	ED RETAIN	IING WALL	
12		ED POWDE CRREN - 'B	RCOATED ALUMIN	IUM
(13)	SOLAR F	ANEL ARR	AY	
(14)	PROPOS	ED NEW 1.	5M HIGH FENCE	
16	RECESS SOFFIT E	ED WITH PE EAVE OR BL		
:100@A	.1	DATE	OCT. 2020	-
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IZ		DWG NO.	TP6.04	

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B (7/10/2020)

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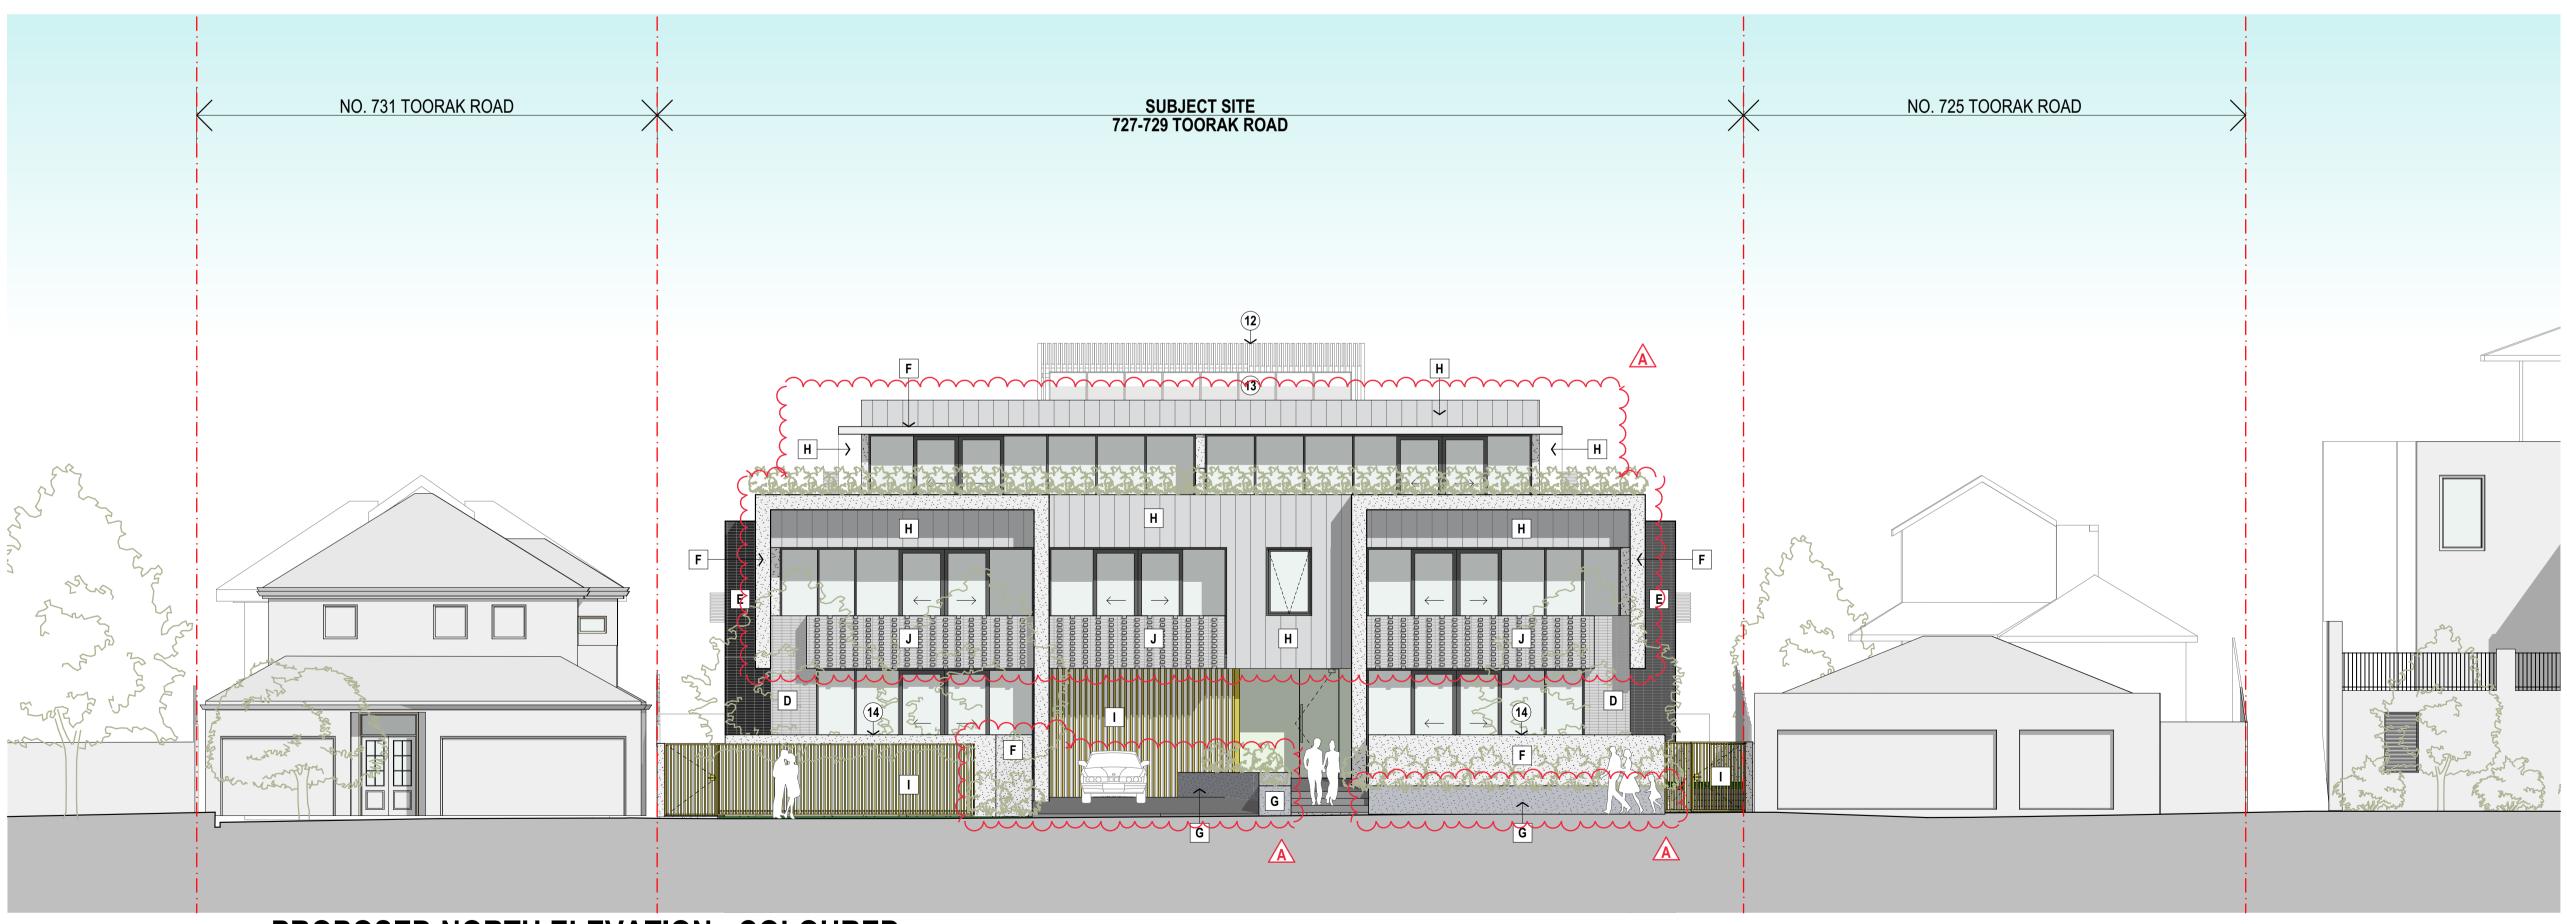
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# **PROPOSED SOUTH ELEVATION - COLOURED** (WITHOUT FENCE)



**PROPOSED NORTH ELEVATION - COLOURED** 



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A	12/08/2020	TOWN PLANNING RFI	PROJECT
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PROJECT MULTI - RESIDENTIAL DEVELOPMENT 727-729 TOORAK ROAD, KOOYONG, VIC

PROPOSED ELEVATIONS - COLOURED

## EXTERNAL FINISHES LEGEND

А	BRICKFACE TO MATCH EXISTING
	PROFILE & COLOUR

- B CONCRETE TILE ROOFING TO MATCH EXISTING PROFILE & COLOUR
- C TEXTURE RENDER FINISH TO MATCH EXISTING
- D FACE BRICKWORK TYPE A LIGHT GREY "METALLIX TITANIUM" STACK BOND
- E FACE BRICKWORK TYPE B MAGNESIUM "METALLIX BRONZE" STACK BOND
- F RENDER FINISH "ANTIQUE WHITE"


G RENDER FINISH "CHARCOAL GREY"

H ZINC CLADDING STANDING - SEAM  $\int A$ "LIGHT GREY" ······ I POWDERCOATED ALUMINIUM BATTENS "BRONZE" 

J FACE BRICKWORK TYPE C - LIGHT GREY WITH TESSELLATED BRICK FINISH ······ 

- GL1 OBSCURE GLASS
- (12) PROPOSED POWDERCOATED ALUMINIUM PLANT SCRREN 'BRONZE''
- (13) SOLAR PANEL ARRAY
- (14) PROPOSED NEW 1.5M HIGH FENCE

SCALE	1:100@A1	DATE	AUG. 2020
	1:200@A3	JOB NO.	19017
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# **PROPOSED WEST ELEVATION - COLOURED**

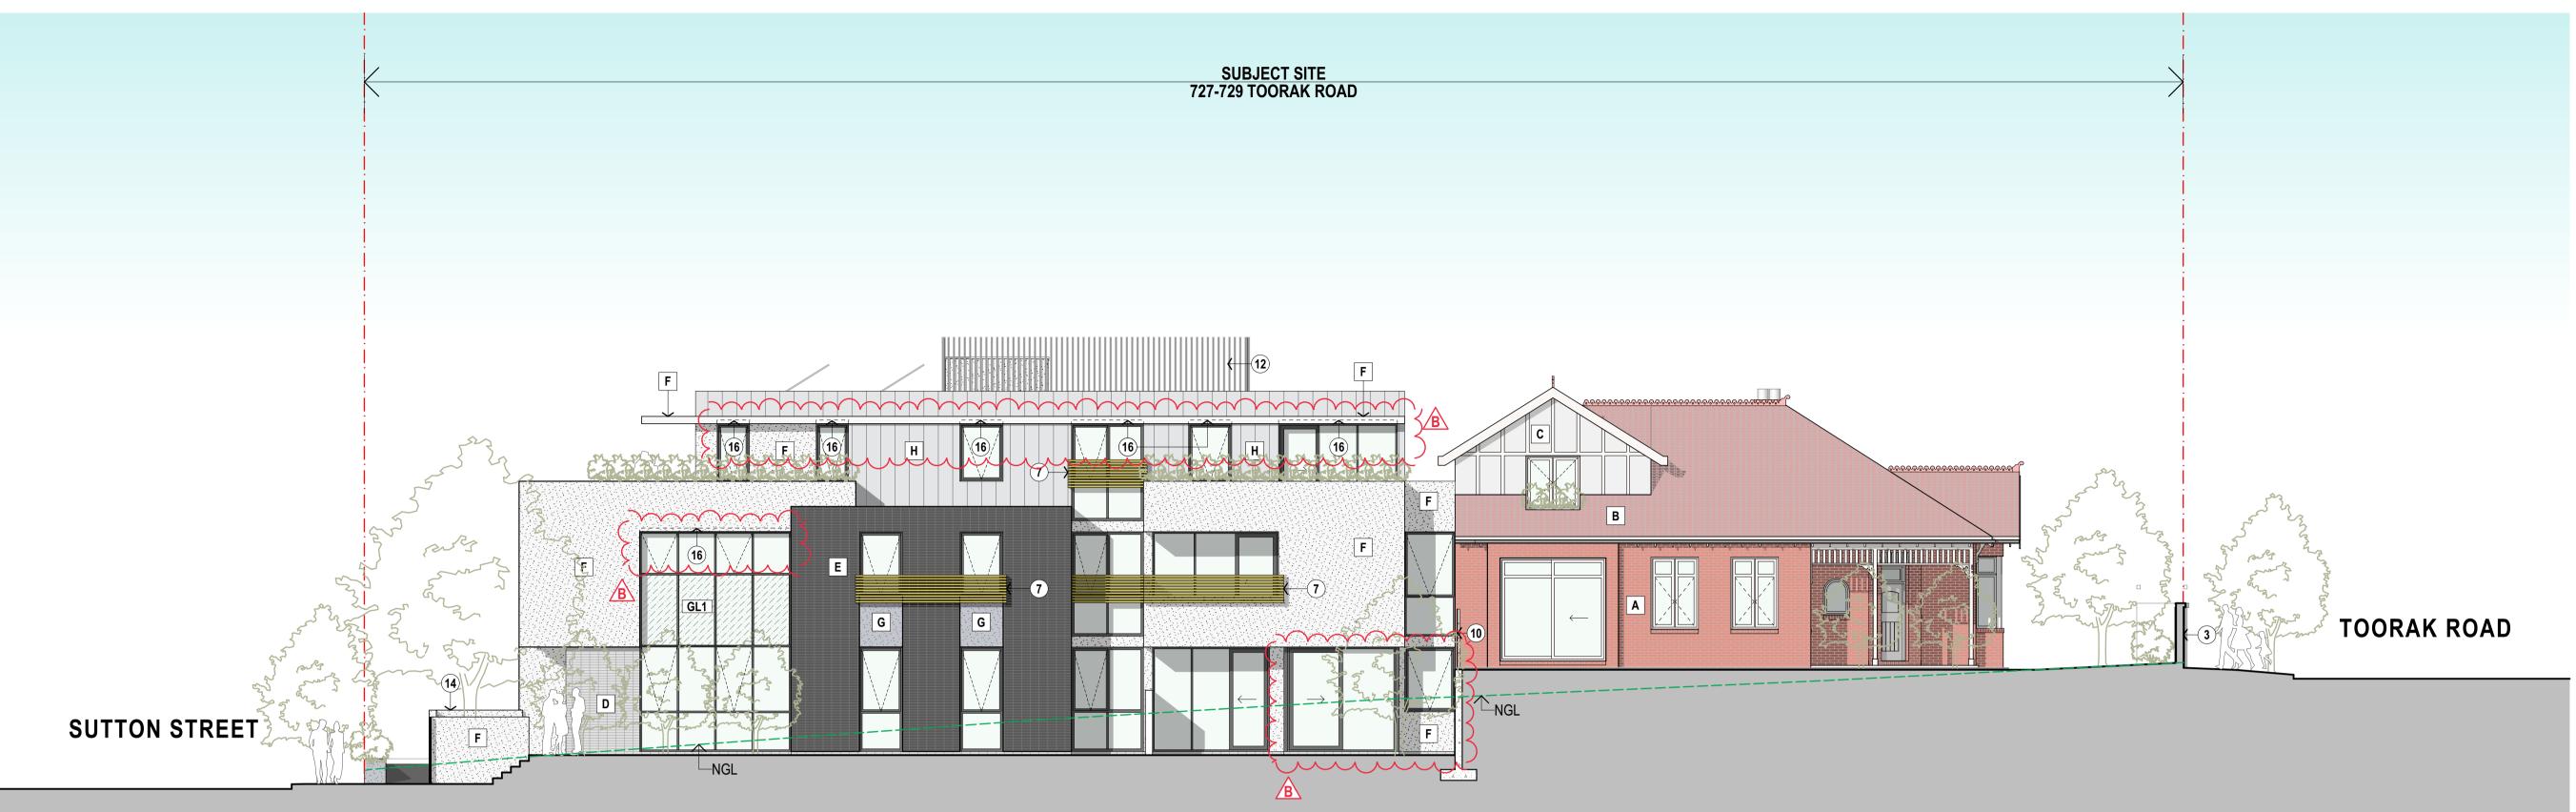

# **PROPOSED EAST ELEVATION - COLOURED**



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PROJECT

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MULTI - RESIDENTIAL DEVELOPMENT 727-729 TOORAK ROAD, KOOYONG, VIC

**PROPOSED ELEVATIONS - COLOURED** 

Advertised Document page 307 of 315, Oct 2020

## EXTERNAL FINISHES LEGEND

- A BRICKFACE TO MATCH EXISTING PROFILE & COLOUR
- B CONCRETE TILE ROOFING TO MATCH EXISTING PROFILE & COLOUR
- C TEXTURE RENDER FINISH TO MATCH EXISTING
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- FIXED ALUMINIUM PRIVACY SCREEN DEVICE MAX. 25% OPENINGS "BRONZE"
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- (12) PROPOSED POWDERCOATED ALUMINIUM PLANT SCRREN 'BRONZE"
- (14) PROPOSED NEW 1.5M HIGH FENCE  $\sim$

16 MOTORISED EXTERNAL ROLLER BLIND SOFFIT EAVE OR BULKHEAD WITH SELECTED FABRIC COLOUR

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	1:200@A3	JOB NO.	19017	
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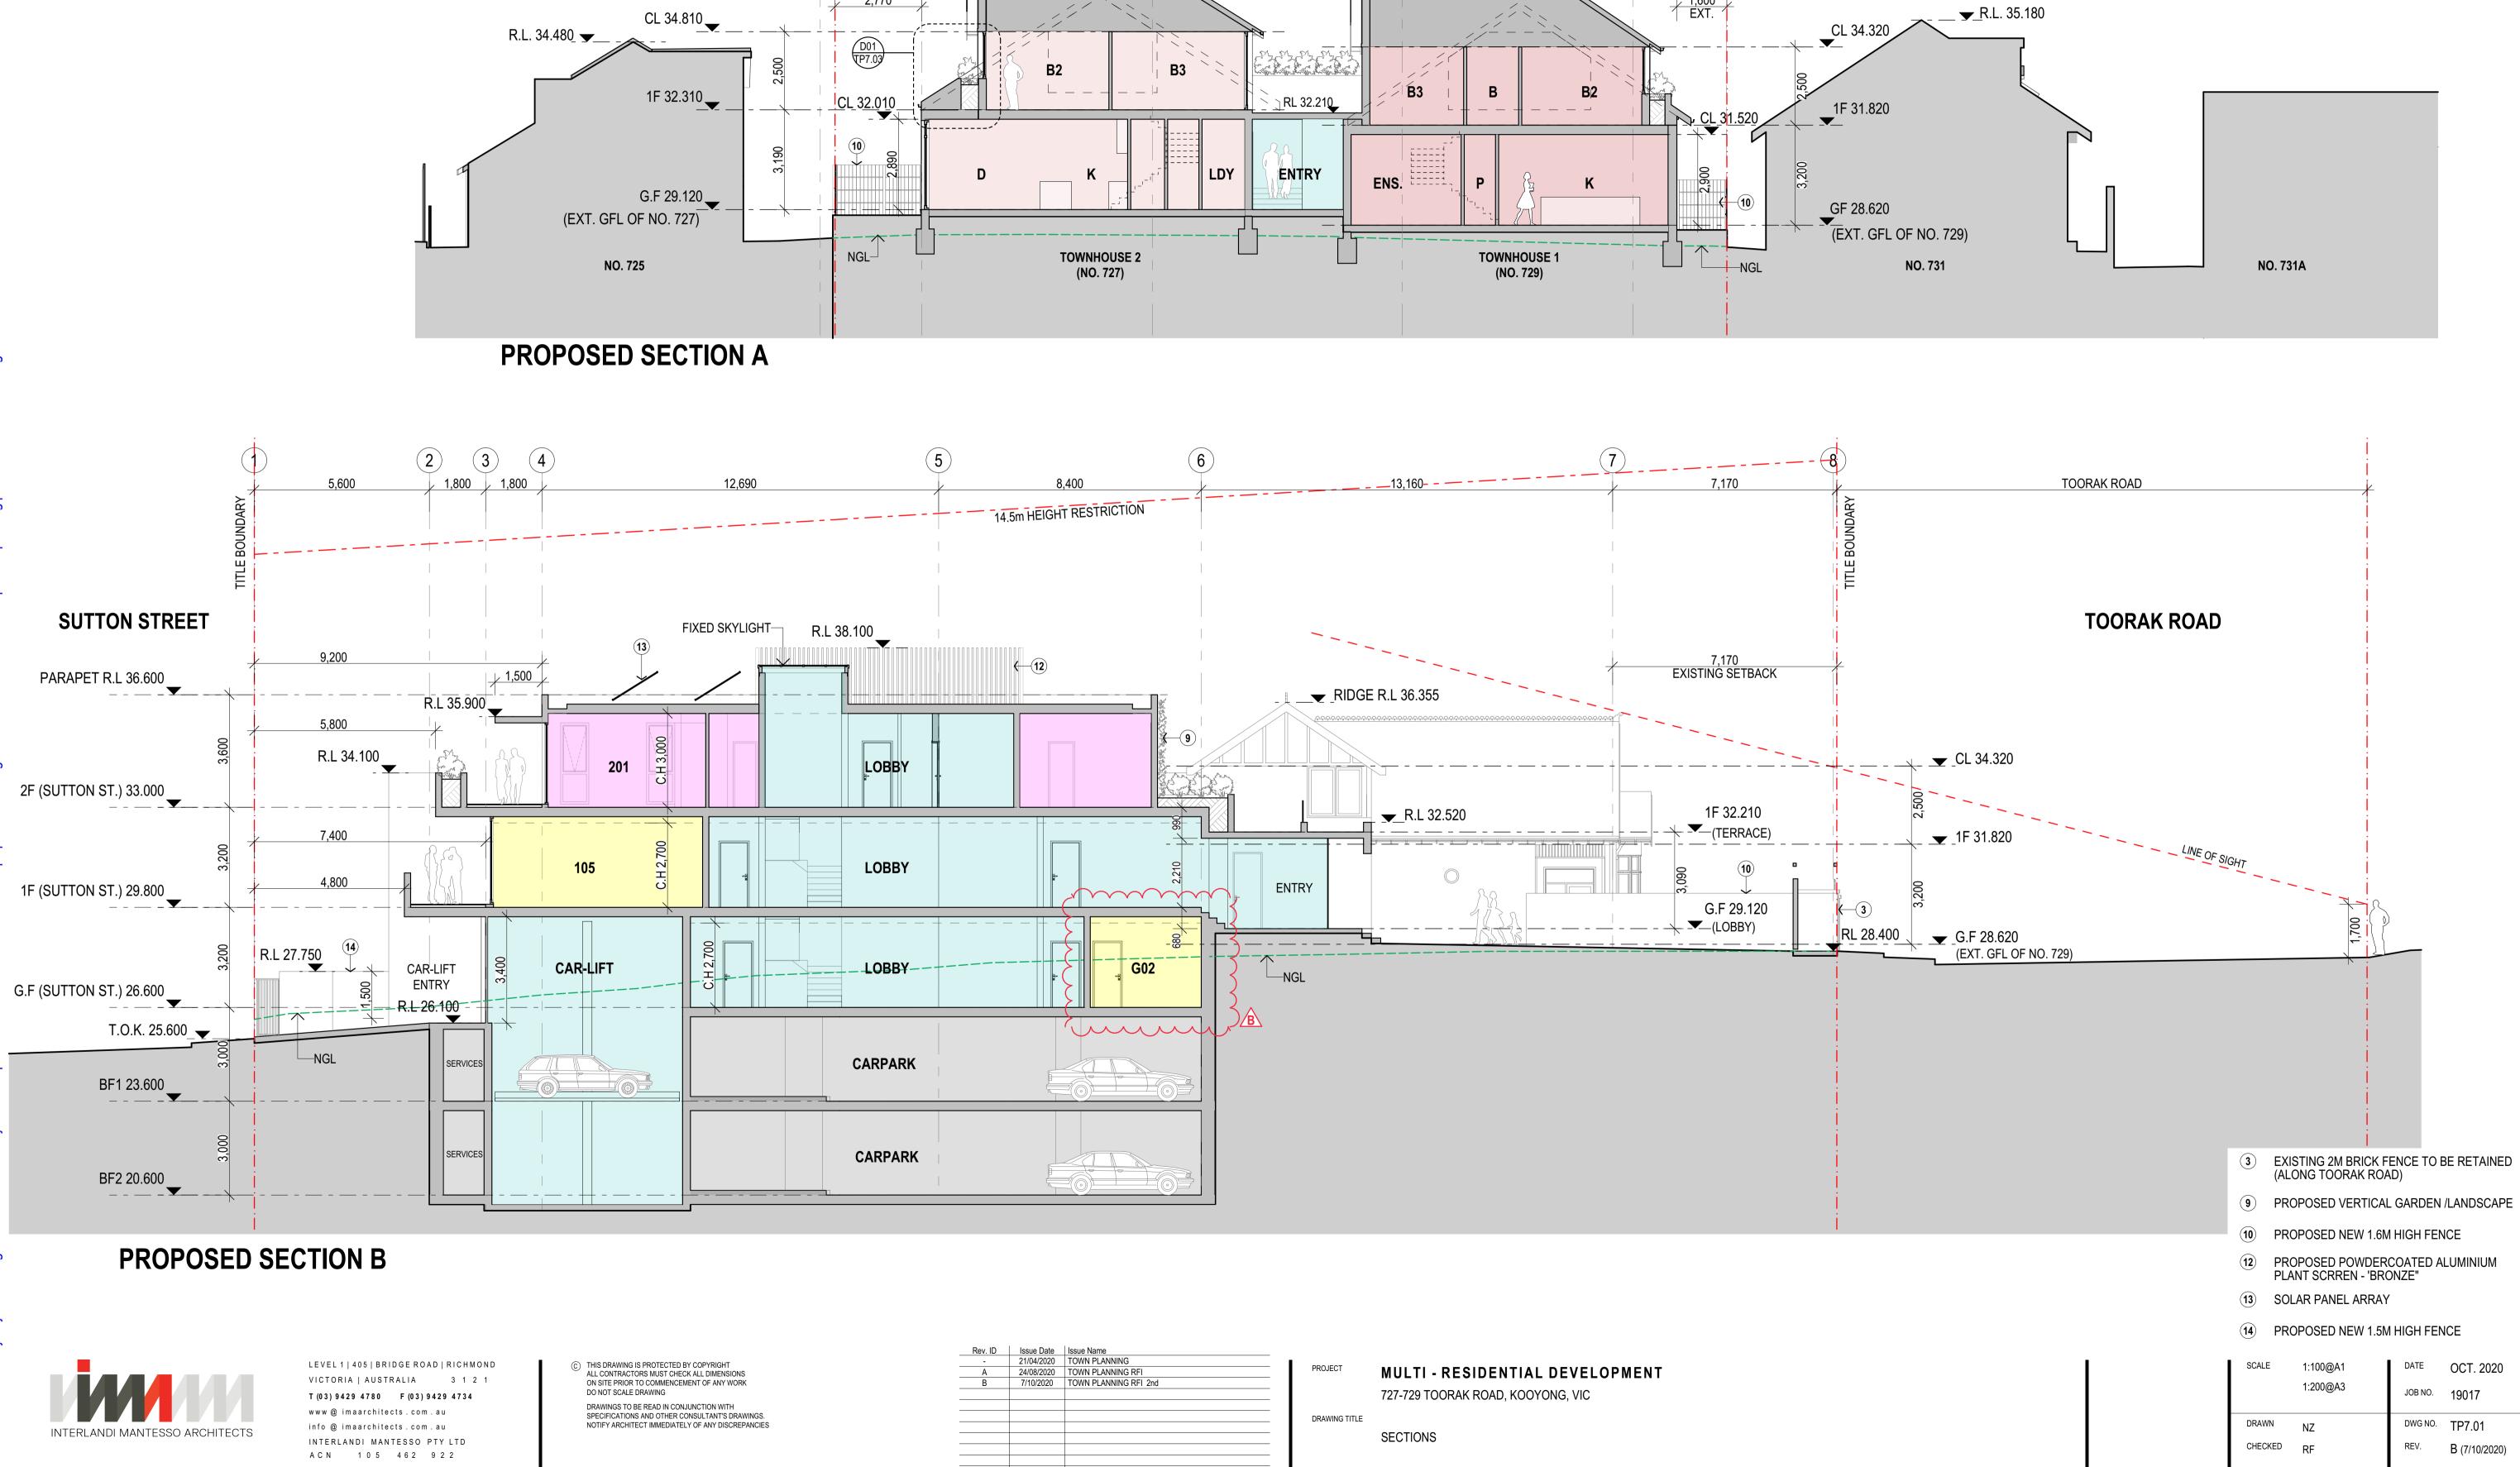



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SECTIONS


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B (7/10/2020)





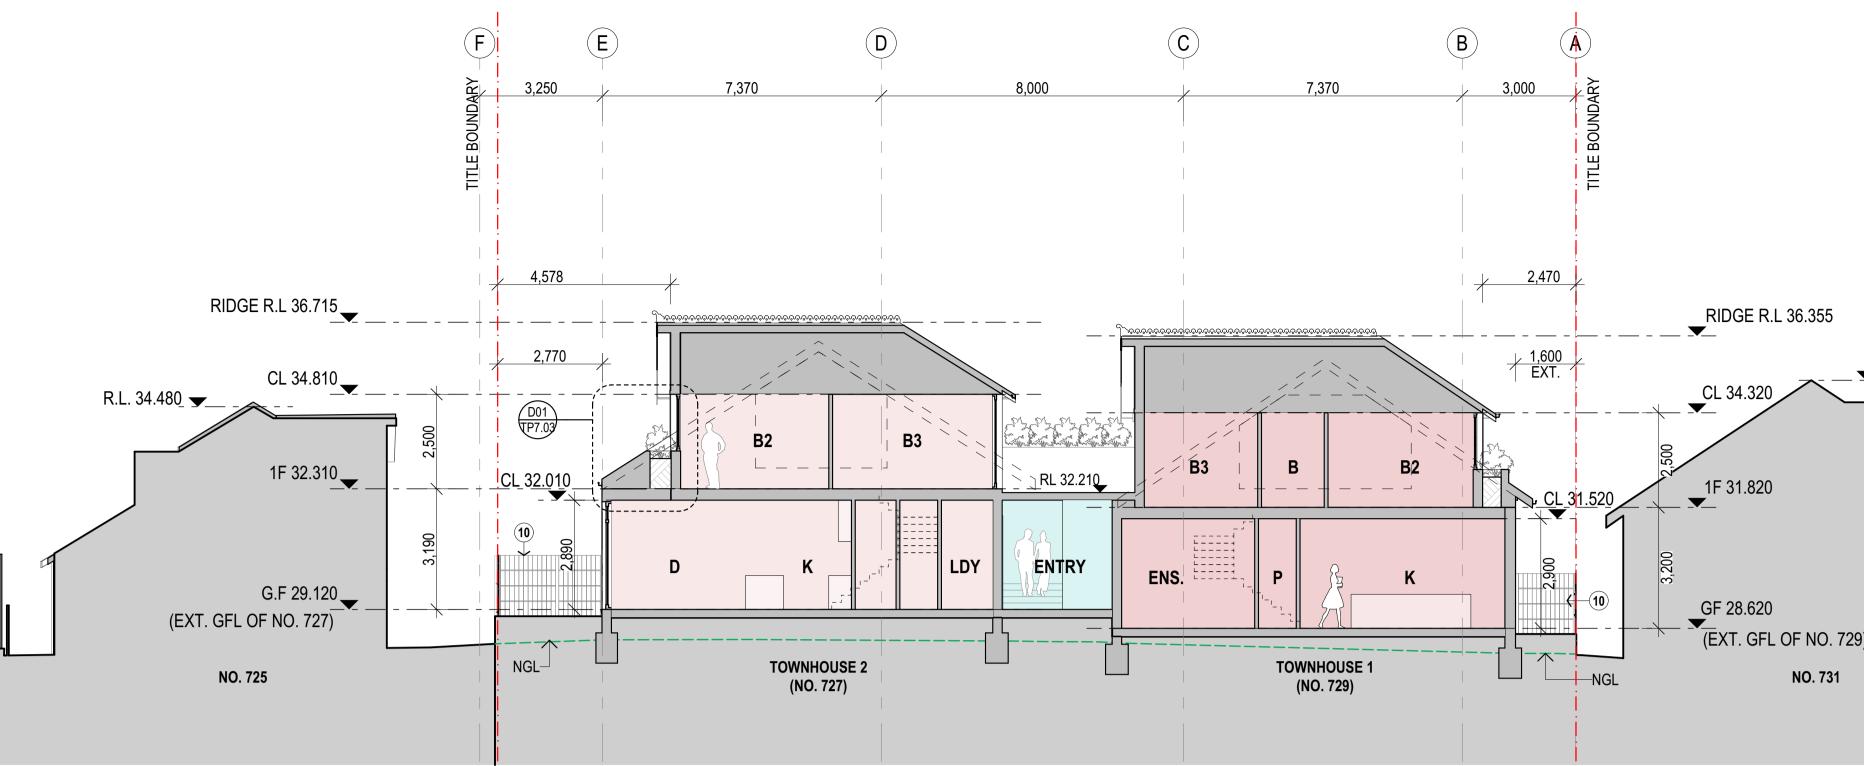

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7/10/2020

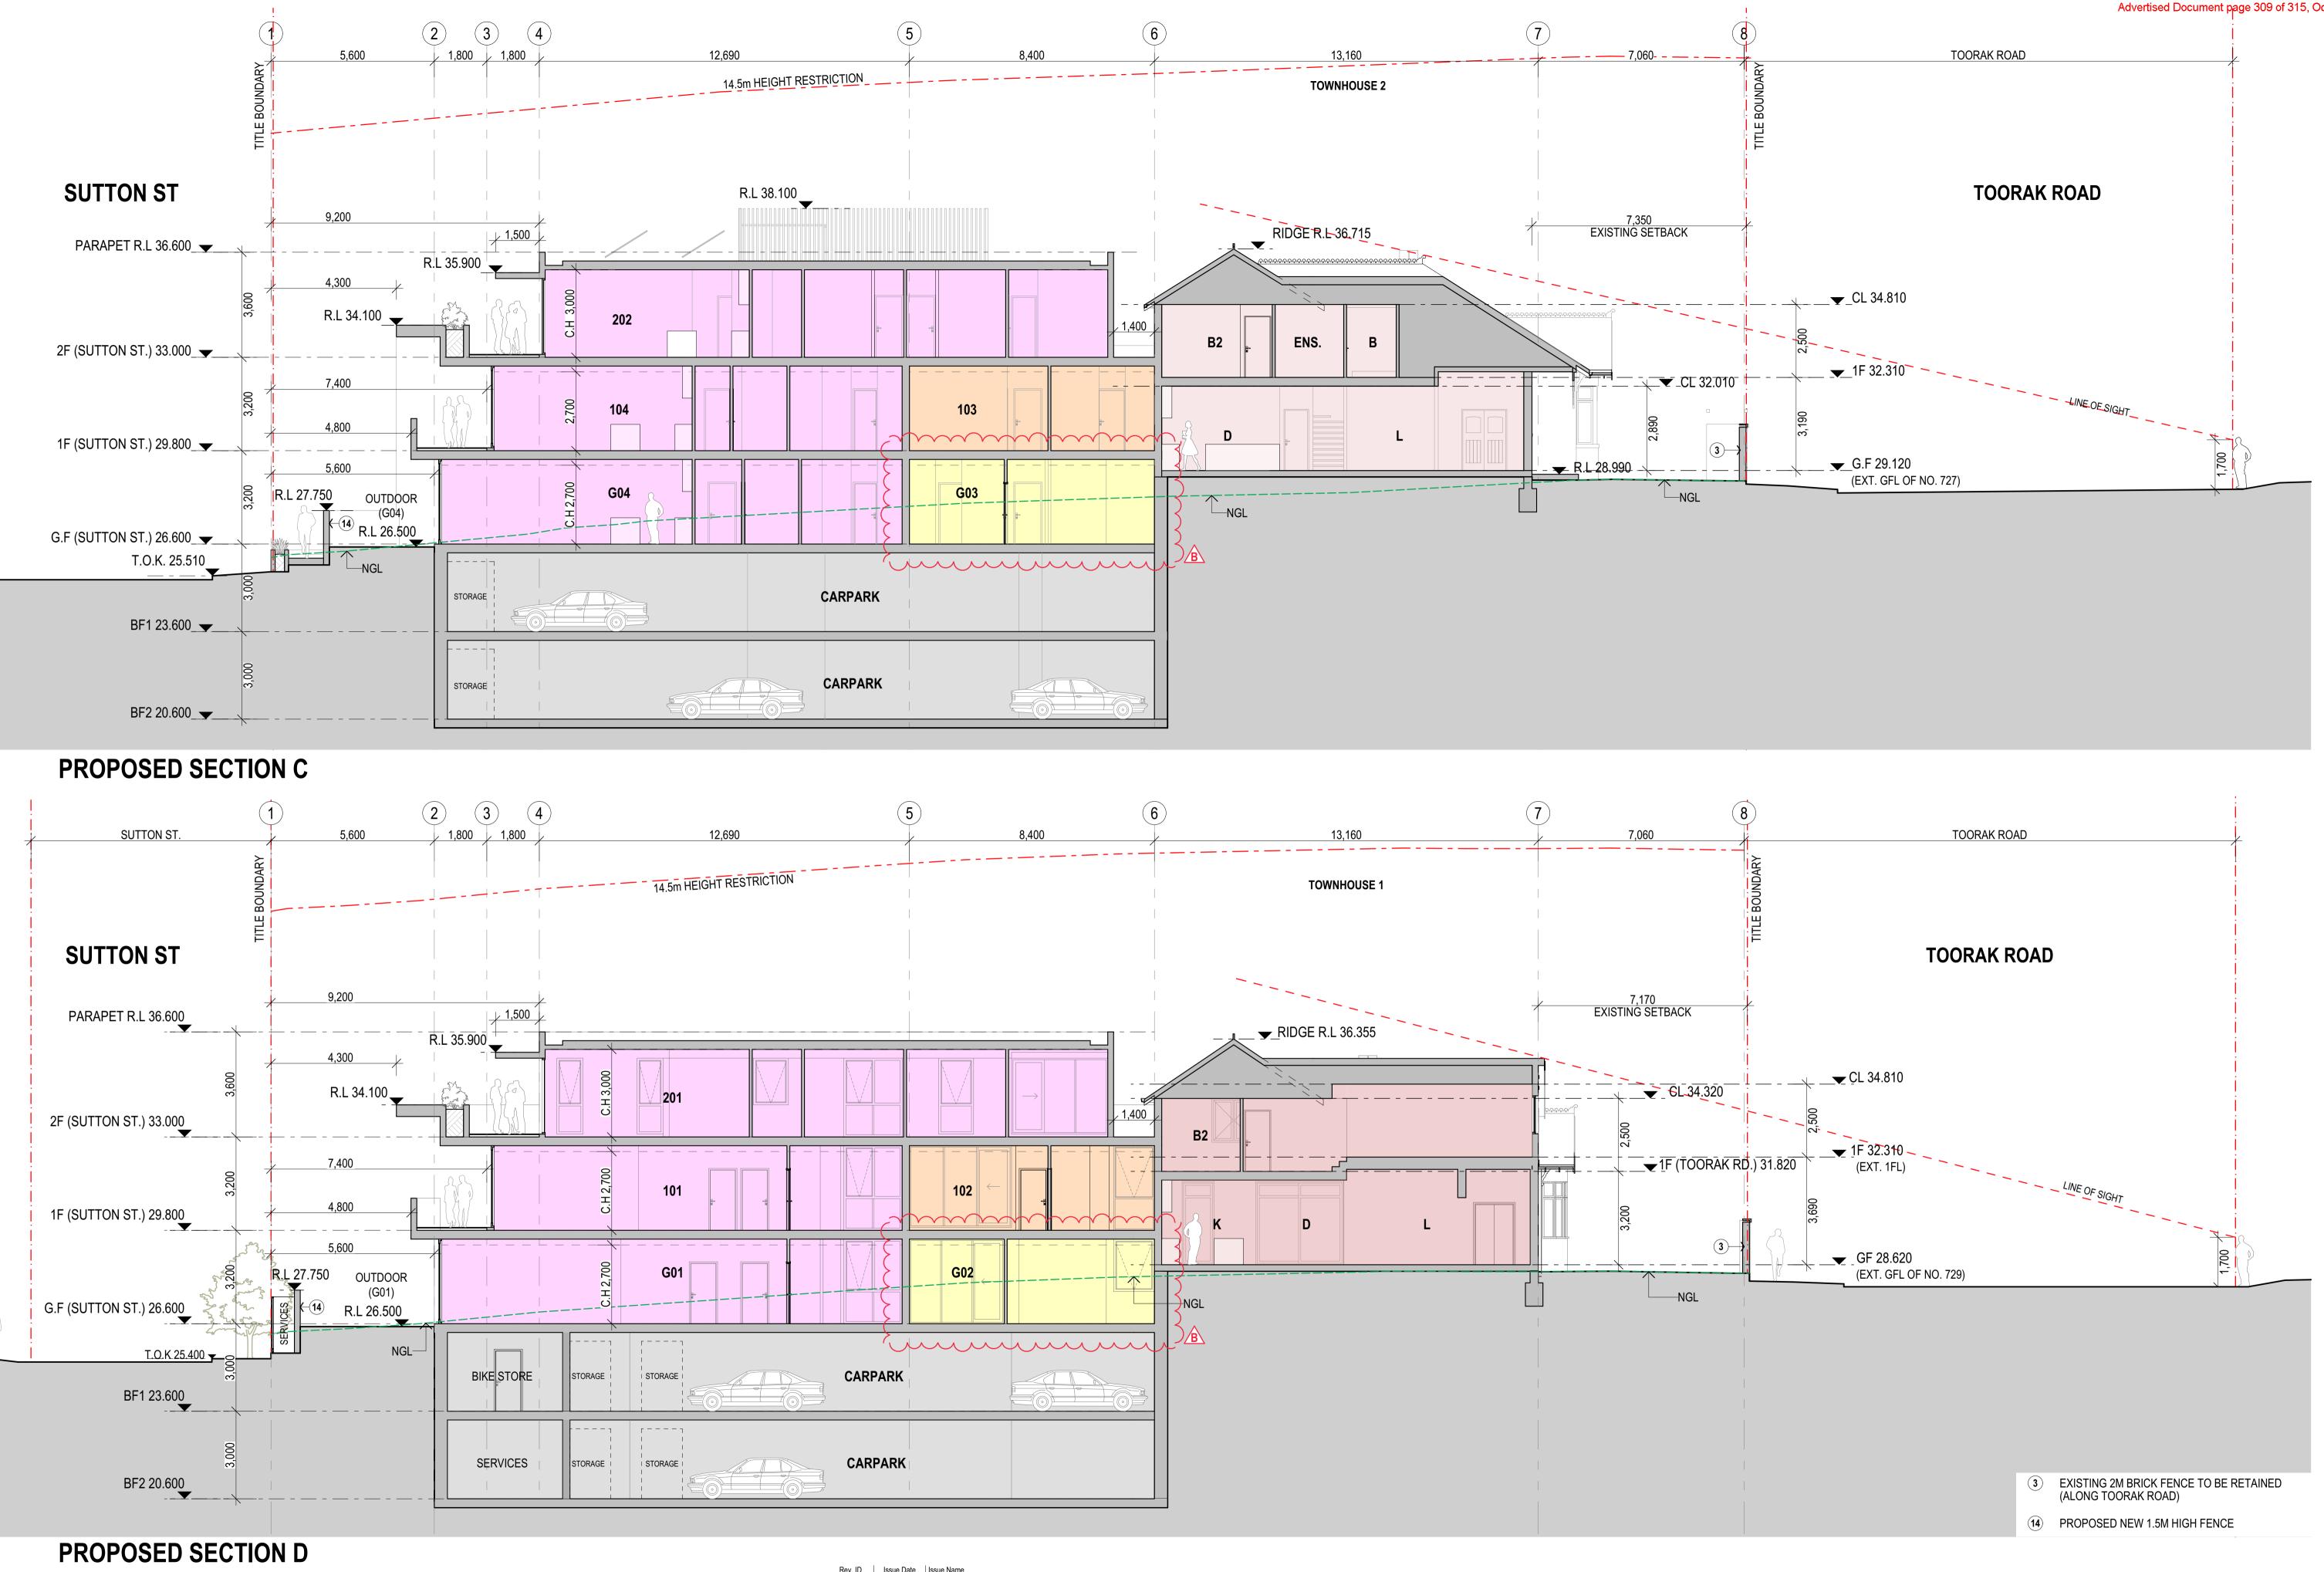
2:14 PM


Rev. ID	Issue Date	Issue Name
-	21/04/2020	TOWN PLANNING
А	24/08/2020	TOWN PLANNING RFI
В	7/10/2020	TOWN PLANNING RFI 2nd
	1	1

PROJECT MULTI - RESIDENTIAL DEVELOPMENT 727-729 TOORAK ROAD, KOOYONG, VIC

SECTIONS


SCALE	1:100@A1 1:200@A3	DATE JOB NO.	OCT. 2020 19017
DRAWN	NZ	DWG NO.	TP7.02
CHECKED	RF	REV.	B (7/10/2020)

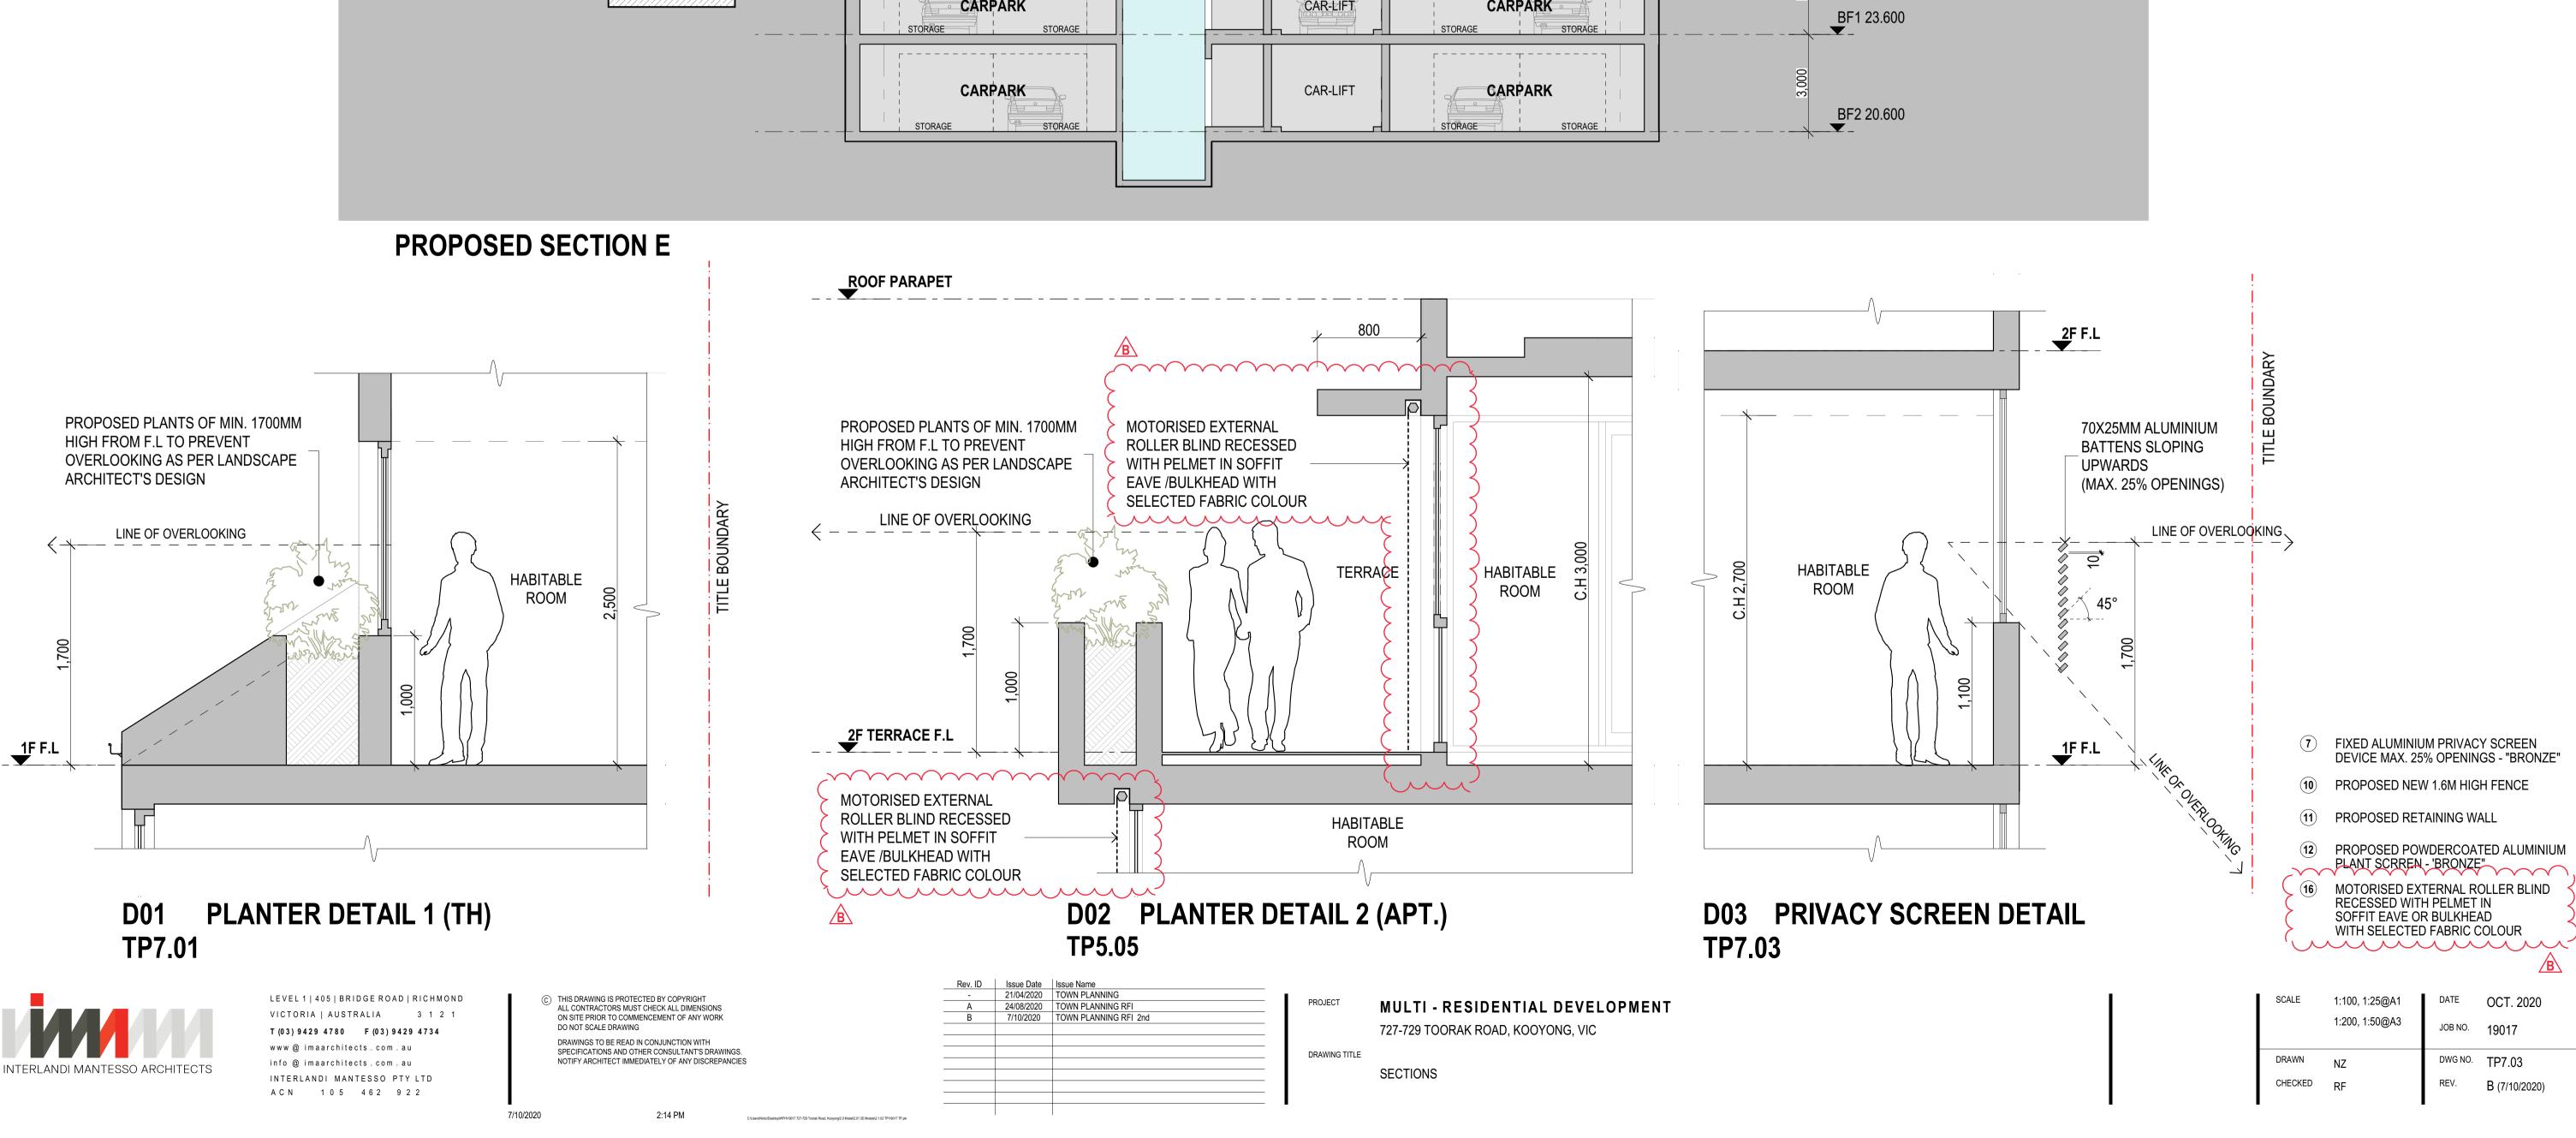

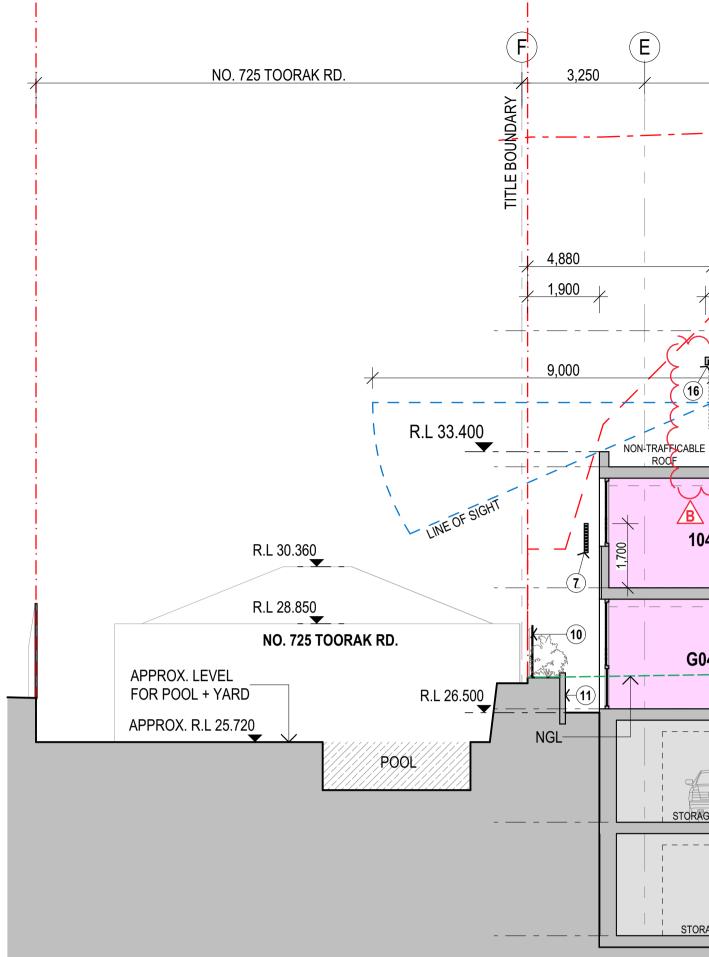


104

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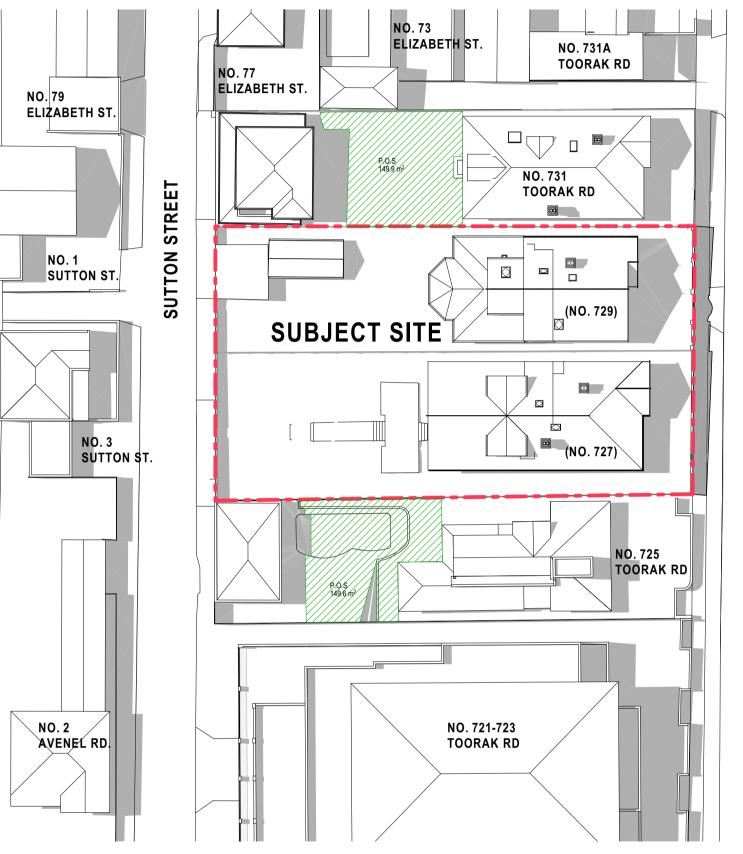
# Advertised Document page 310 of 315, Oct 2020
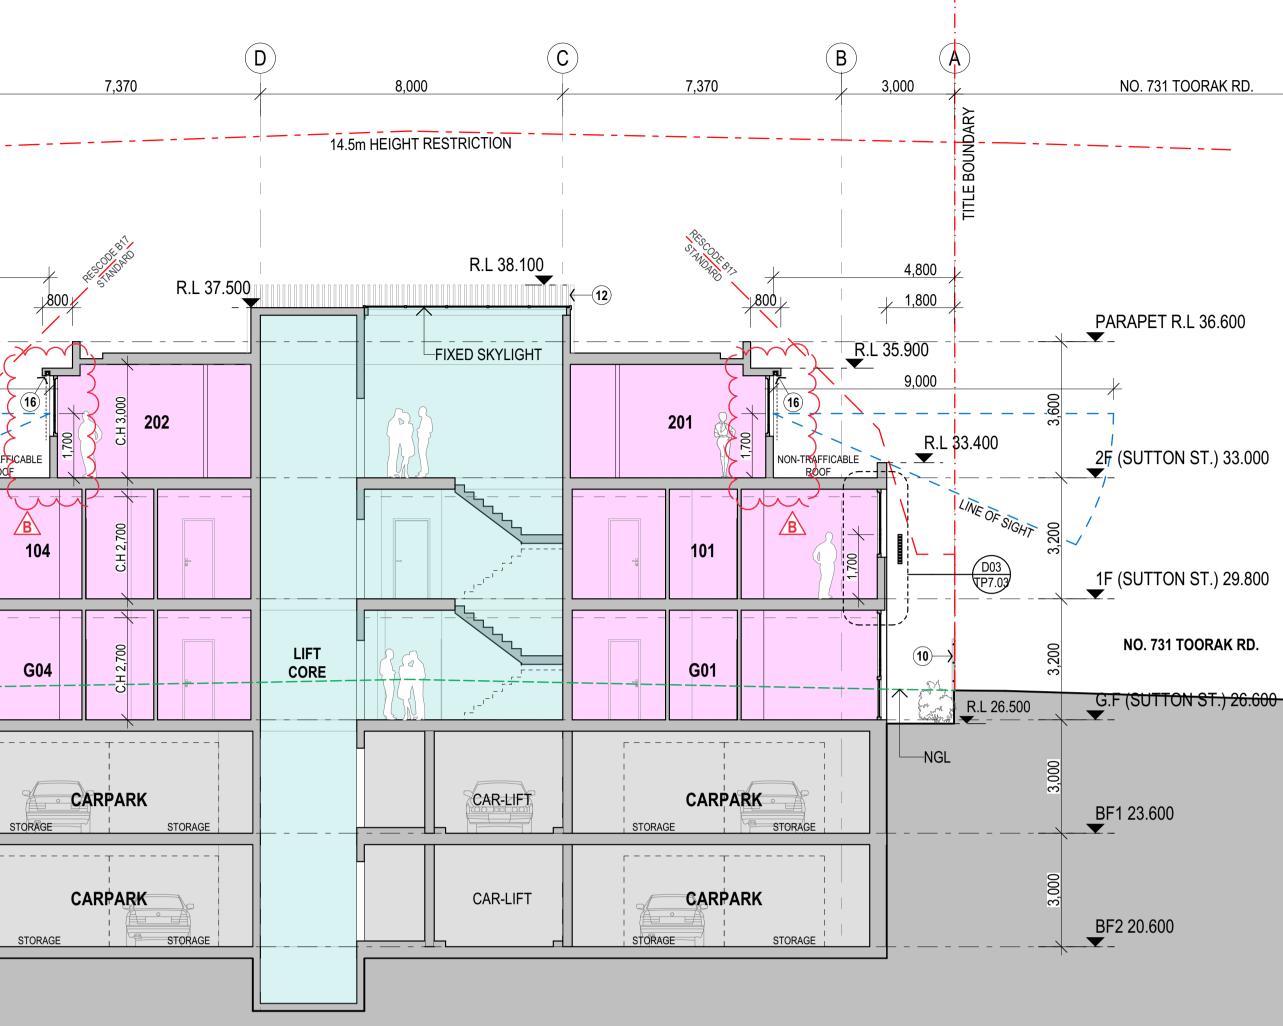
# **SHADOW DIAGRAMS - EXISTING**



# **FOORAK ROAD**

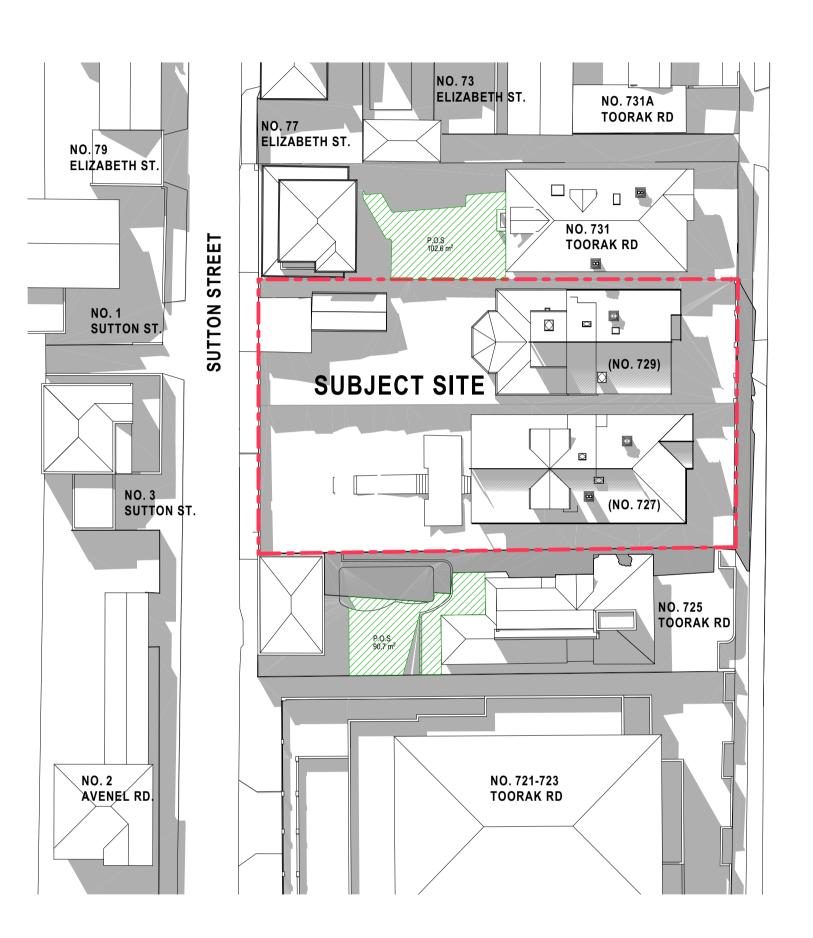



# SHADOW DIAGRAM - EXISTING

9AM (22nd SEPTEMBER)

OVERSHADOWING BY EXISTING BUILDING: 171m<sup>2</sup>

FREE AREA OF PRIVATE OPEN SPACE:

- NO. 725 TOORAK RD. : 91m<sup>2</sup>
- NO. 731 TOORAK RD. : 103m<sup>2</sup>



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12/08/2020

11:01 AM

# **SHADOW DIAGRAM - EXISTING** 12PM (22nd SEPTEMBER)

OVERSHADOWING BY EXISTING BUILDING: 49m<sup>2</sup> FREE AREA OF PRIVATE OPEN SPACE: - NO. 725 TOORAK RD. : 149m<sup>2</sup> - NO. 731 TOORAK RD. : 150m<sup>2</sup> 

> Rev. ID
>  Issue Date
>  Issue Name
>
>
>  21/04/2020
>  TOWN PLANNING
>
>
>  A
>  12/08/2020
>  TOWN PLANNING RFI

PROJECT

DRAWING TITLE

MULTI - RESIDENTIAL DEVELOPMENT 727-729 TOORAK ROAD, KOOYONG, VIC

ROAD


**FOORAK** 

SHADOW DIAGRAMS - EXISTING

NO. 79 ELIZABETH ST. STREET SUTTON NO. 1 SUTTON ST NO. 3 SUTTON ST NO. 2 AVENEL RD.

# **SHADOW DIAGRAM - EXISTING** 3PM (22nd SEPTEMBER)

OVERSHADOWING BY EXISTING BUILDING: 119m<sup>2</sup> FREE AREA OF PRIVATE O - NO. 725 TOORAK RD. :97m - NO. 731 TOORAK RD. :134  $\mathbf{A}$ 

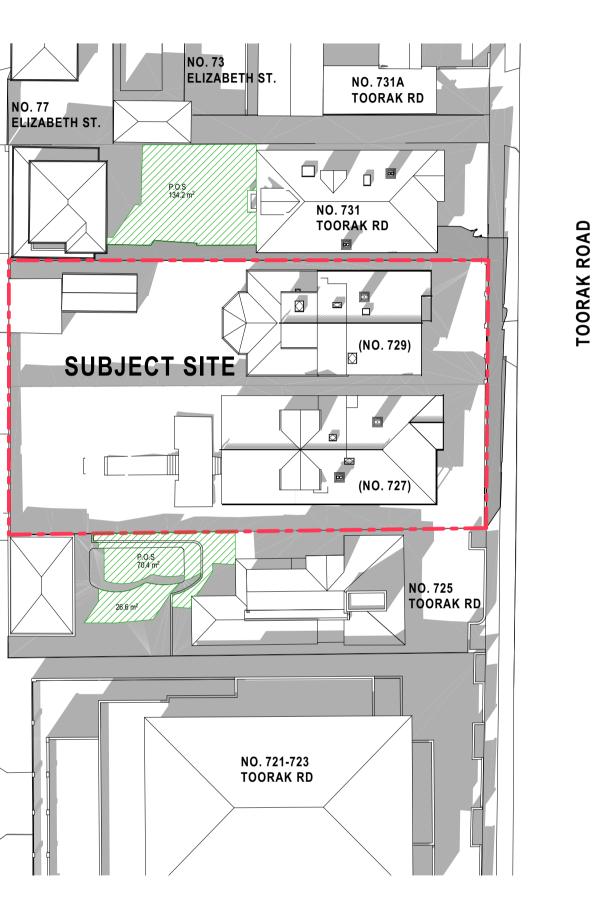


······,	
FREE AREA OF PRIVATE OPEN SPACE:	
- NO. 725 TOORAK RD. :97m <sup>2</sup>	
- NO. 731 TOORAK RD. :134m <sup>2</sup>	
· · · · · · · · · · · · · · · · · · ·	L

## LEGEND



	SCALE	1:400@A1	DATE	AUG. 2020
		1:800@A3	JOB NO.	19017
)	DRAWN	NZ	DWG NO.	TP3.13
	CHECKED	RF	REV.	A (12/08/2020)

# **SHADOW DIAGRAMS - PROPOSED**

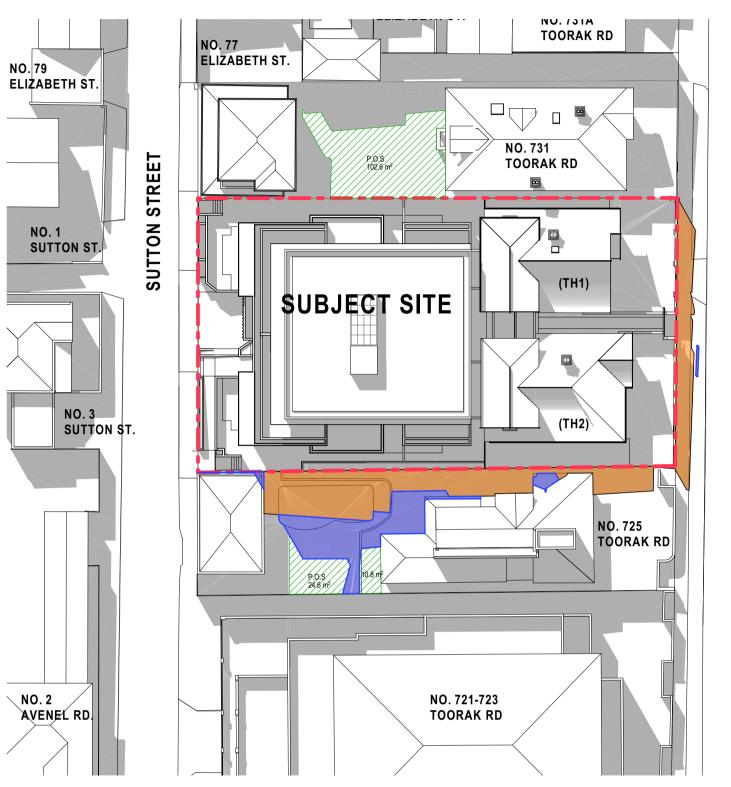



# **SHADOW DIAGRAM - PROPOSED** 9AM (22nd SEPTEMBER)

EXTENT OVERSHADOWING BY PROPOSAL:

FREE AREA OF PRIVATE OPEN SPACE: - NO. 725 TOORAK RD. : 36m<sup>2</sup> - NO. 731 TOORAK RD. : 103m<sup>2</sup> 

 $\sim\sim\sim$ 83m<sup>2</sup>  ROAD **FOORAK** 

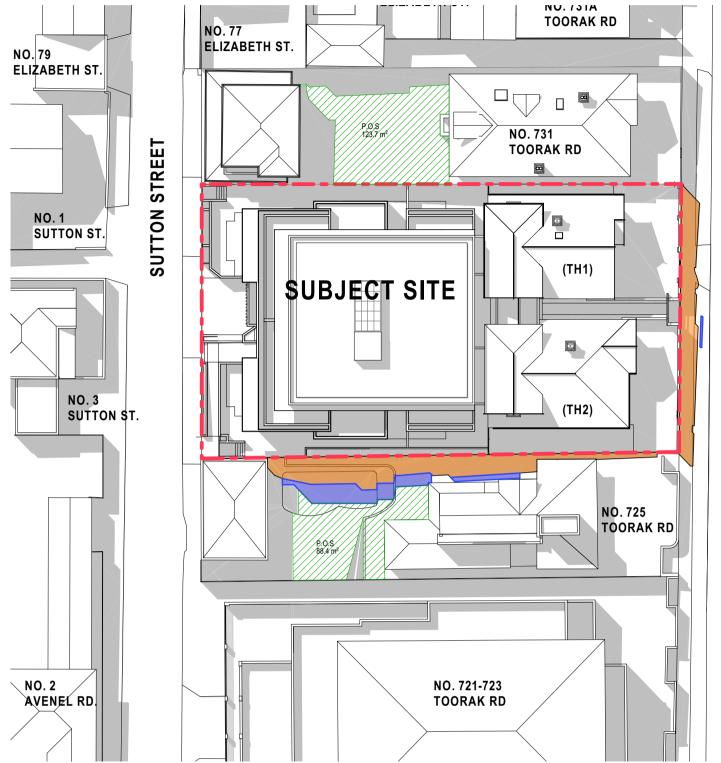

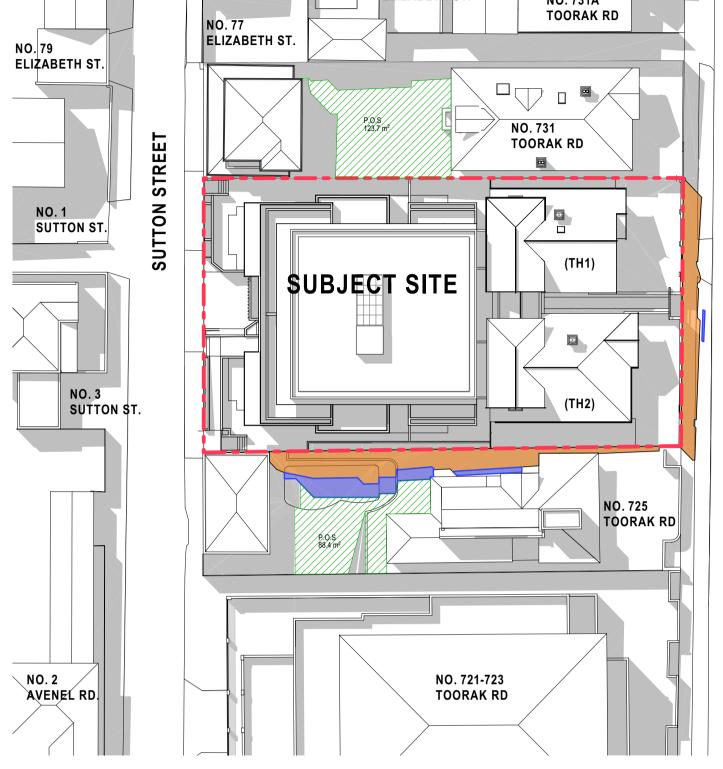

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- 3	NO.	72
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12/08/2020

11:01 AM

# SHADOW DIAGRAM - PROPOSED


10AM (22nd SEPTEMBER)

T OVERSHADOWING BY PROPOSAL: 

AREA OF PRIVATE OPEN SPACE: 25 TOORAK RD. : 88m<sup>2</sup> 31 TOORAK RD. : 124m<sup>2</sup> 



ROAD TOORAK

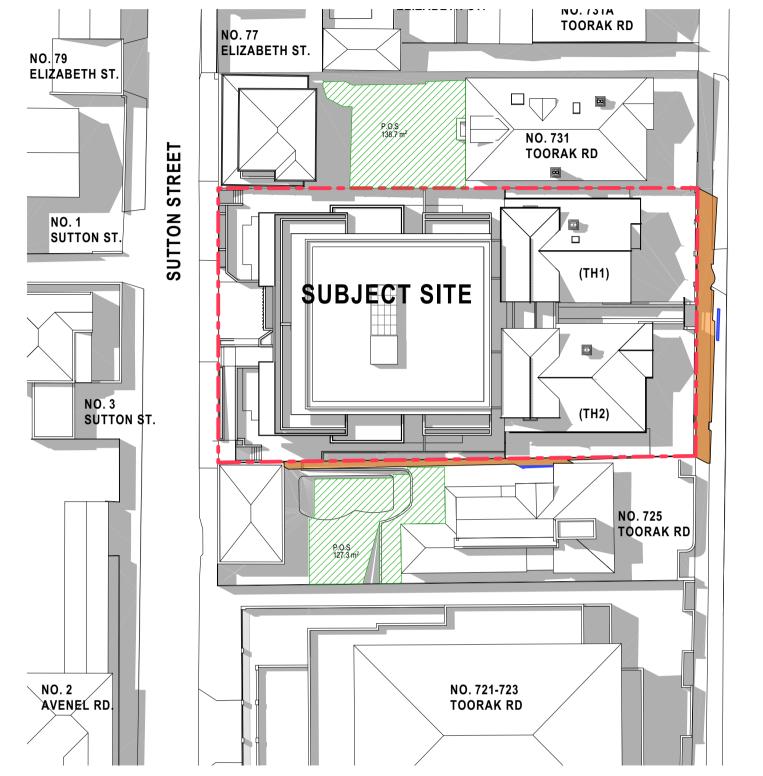

# **SHADOW DIAGRAM - PROPOSED** 11AM (22nd SEPTEMBER)

## EXTENT OVERSHADOWING BY PROPOSAL: FREE AREA OF PRIVATE OPEN SPACE: - NO. 725 TOORAK RD. : 127m<sup>2</sup> - NO. 731 TOORAK RD. : 139m<sup>2</sup>

(

Issue Date	Issue Name
21/04/2020	TOWN PLANNING
12/08/2020	TOWN PLANNING RFI
	21/04/2020


PROJECT

DRAWING TITLE

MULTI - RESIDENTIAL DEVELOPMENT 727-729 TOORAK ROAD, KOOYONG, VIC

SHADOW DIAGRAMS - PROPOSED

SCALE	1:400@A1 1:800@A3	DATE JOB NO.	AUG. 2020 19017
DRAWN	NZ	DWG NO.	TP3.14
CHECKED	RF	REV.	A (12/08/2020)

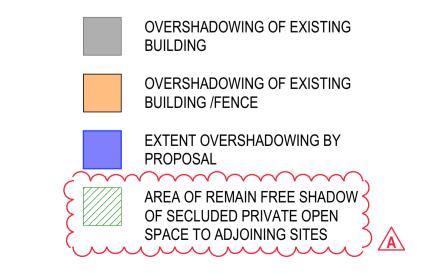

## LEGEND

 $\sim\sim\sim$ 

2m<sup>2</sup>



**TOORAK ROAD** 

# **SHADOW DIAGRAMS - PROPOSED**

TOORAK RD

/ 🛛 🖻

NO. 731

TOORAK RD


(TH1)

(TH2)

NO. 725

12/08/2020

TOORAK RD

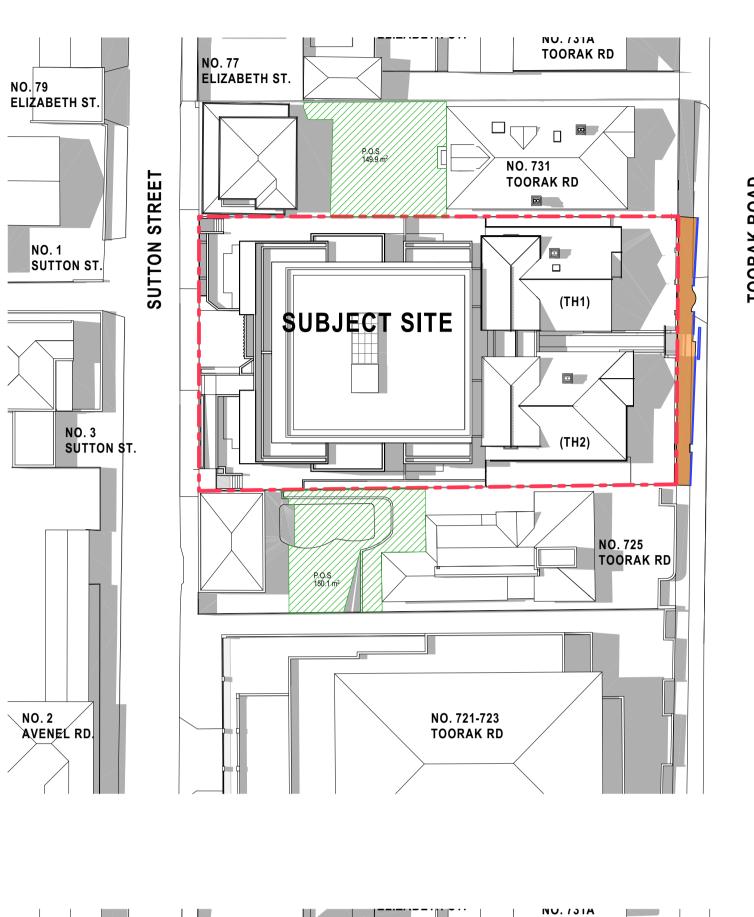


# **SHADOW DIAGRAM - PROPOSED** 12PM (22nd SEPTEMBER)

)	EXTENT OVERSHADOWING BY P

FREE AREA OF PRIVATE OPEN SPACE: - NO. 725 TOORAK RD. : 149m<sup>2</sup> 8 - NO. 731 TOORAK RD. : 150m<sup>2</sup> 



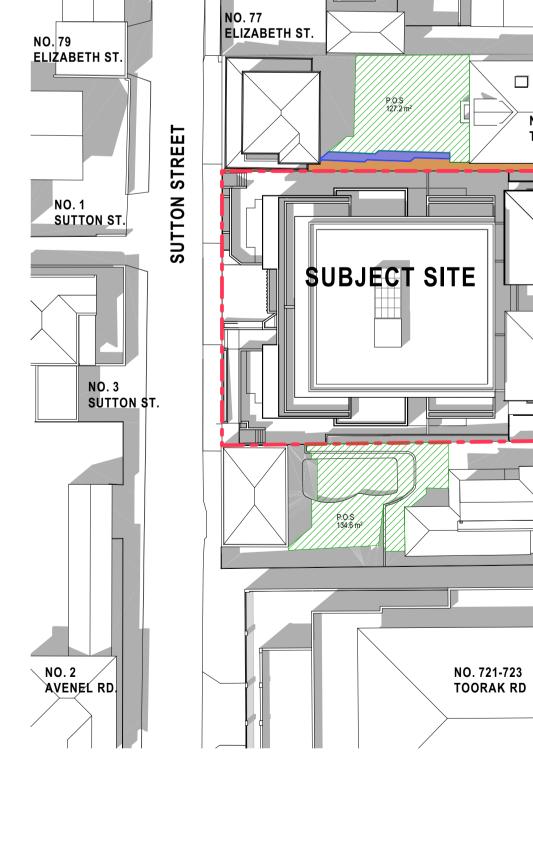


INTERLANDI MANTESSO ARCHITECTS





11:02 AM

PROPOSAL:

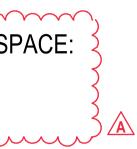


3m<sup>2</sup>

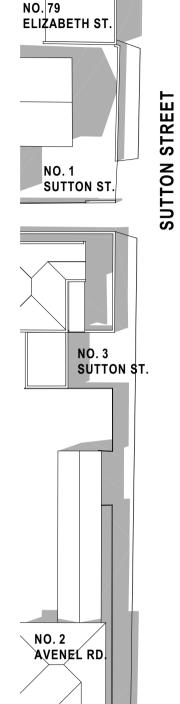

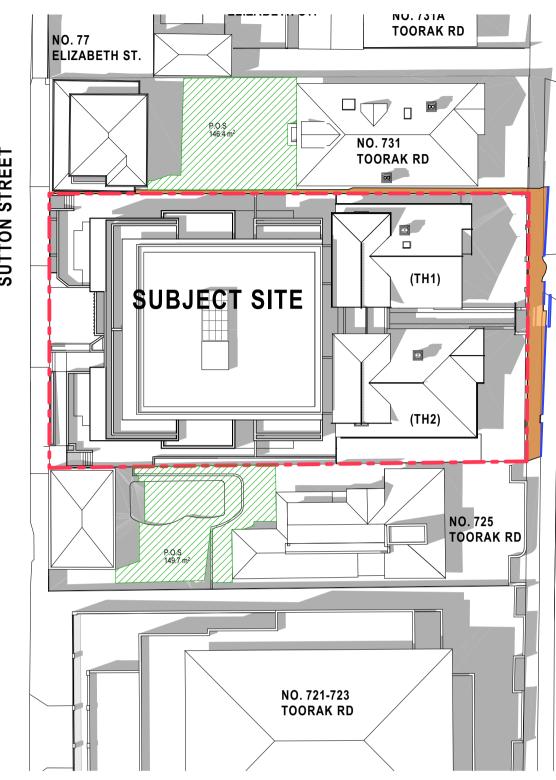

# **SHADOW DIAGRAM - PROPOSED**

 $\sim$ 11m<sup>2</sup> 

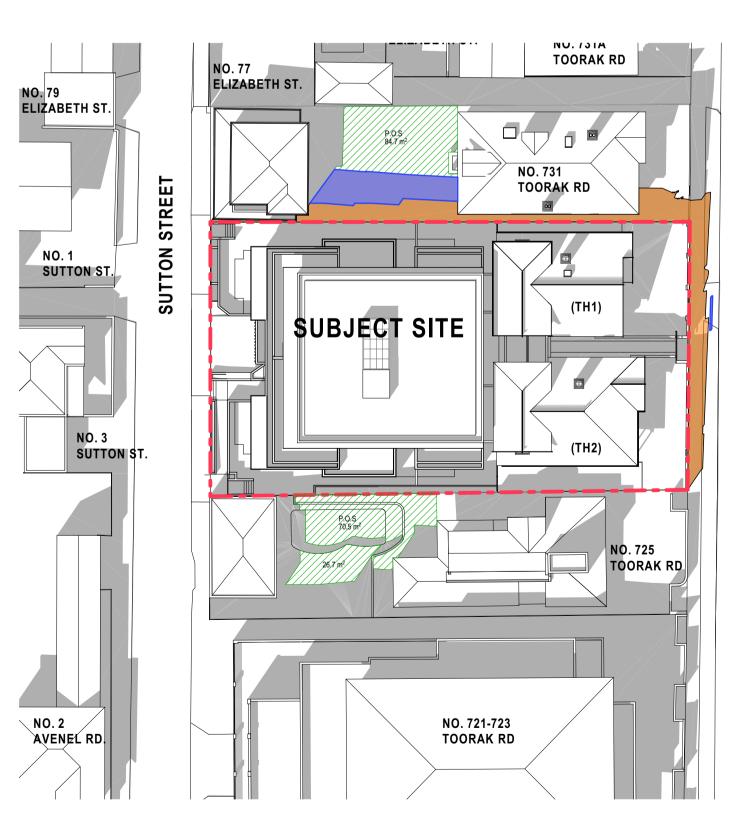

Rev. ID	Issue Date	Issue Name
-	21/04/2020	TOWN PLANNING
Α	12/08/2020	TOWN PLANNING RFI

PROJECT **MULTI - RESIDENTIAL DEVELOPMENT** 727-729 TOORAK ROAD, KOOYONG, VIC

SHADOW DIAGRAMS - PROPOSED

DRAWING TITLE

# **SHADOW DIAGRAM - PROPOSED** 1PM (22nd SEPTEMBER)

**EXTENT OVERSHADOWING BY PROPOSAL:** 

5m<sup>2</sup>

FREE AREA OF PRIVATE OPEN SPACE: - NO. 725 TOORAK RD. : 149m<sup>2</sup> 00 - NO. 731 TOORAK RD. : 147m<sup>2</sup> 

ROA

Δ ROA

00

# **SHADOW DIAGRAM - PROPOSED**

3PM (22nd SEPTEMBER)


EXTENT OVERSHADOWING BY PROPOSAL:



FREE AREA OF PRIVATE OPEN SPACE: - NO. 725 TOORAK RD. : 97m<sup>2</sup> - NO. 731 TOORAK RD. : 85m<sup>2</sup> ······



SCALE	1:400@A1	DATE	AUG. 2020
	1:800@A3	JOB NO.	19017
DRAWN	NZ	DWG NO.	TP3.15
CHECKED	RF	REV.	A (12/08/2020)

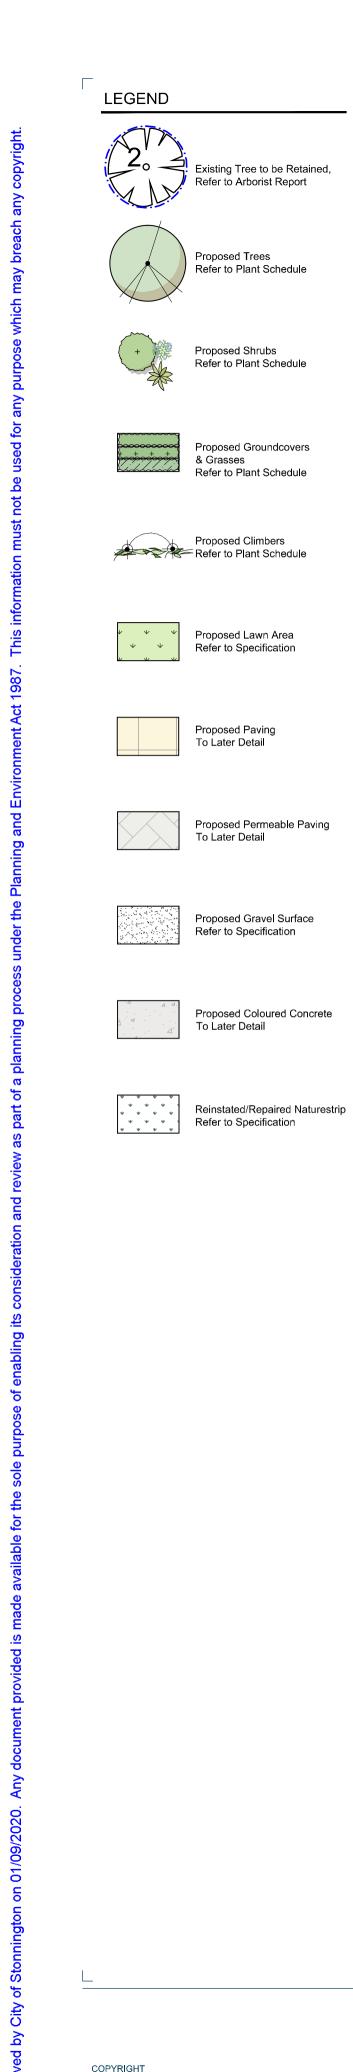



### PLANT SCHEDULE- GROUND FLOOR

SYM	BOTANICAL NAME	COMMONNAME	D/E N/Ex	HEIGHT X WIDTH AT MATURITY	SUPPLY SIZE	QTY
TREES						
Er	Elaeocarpus reticulatus	Blueberry Ash	E/N	8 x 4m	2m	2
Pc C	Pyrus calleryana 'Capital'	Capital Pear	D/Ex	11 x 3m	2m	7
Qp	Quercus palustris	Pin Oak	D/Ex	14 x 7-8m	2m	2
					TOTAL	11
SHRUBS						
Ct	Choisya ternata	Mexican Orange Blossom	E/Ex	2 x 1m	200mm Pots	
Mp	Murraya paniculata	Orange Jessamine	E/Ex	3 x 1m	200mm Pots	
SaP	Syzygium australe 'Pinnacle'	Pinnacle Lilly-pilly	E/N	4 x 1m (Clipped)	200mm Pots	
					TOTAL	
GROUNDCO	OV ERS					=
Ac	Arthropodium cirratum	Renga Lily	E/Ex	0.7 x 0.7m	140mm Pots	ta
DtT	Dianella tasmanica 'Tasred'	Tasred Flax Lily	E/N	0.4 x 0.4m	140mm Pots	De
LmS	Liriope muscari 'Samantha'	Samantha Pink Turf-Lily	E/Ex	0.4 x 0.4m	140mm Pots	-
Rh	Ruscus hypoglossum	Butcher's Broom	E/Ex	0.5 x 1m	140mm Pots	te
Та	Trachelospermum asiaticum	Yellow Star Jasmine	E/Ex	0.2 x Spreading	140mm Pots	La
					TOTAL	0
CLIMBERS						Ĕ
Fp	Ficus pumila	Climbing Fig	E/Ex	Climber	140mm Pots	
Ph	Parthenocissus henryana	Silver Vein Creeper	D/Ex	Climber	140mm Pots	
					TOTAL	
	D/E = Deciduous/Evergreen	N/Ex = Na				

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#### SPECIFICATION NOTES

Soil Preparation Crushed rock, concrete spillage and any other material restrictive to plant growth (e.g. large rocks) shall pot in all directions. Semi-advanced tree planting holes are to be the same depth as the rootball and Raised planter construction is to include, but not necessarily be limited to, the supply and installation of be removed from the site of any planting beds and semi-advanced trees. All trees to be removed shall 2-3 times its diameter, with the top of the rootball being at grade. A 75mm high berm is to be agricultural drains, drainage cells at base, filter fabric, planting medium, mulch and irrigation. Planter be stump ground and all rubbish/vegetative spoil is to be removed from site. Existing top soil in planting constructed at edge of root-ball to hold water. All plants are to be thoroughly watered after planting and boxes must be effectively tanked and lined with coreflute to prevent leaking. areas is to be preserved so that it does not receive additional compaction from site machinery and so slow release fertiliser added at the quantities specified by the manufacturer. that no rubble or building supplies are stored in these areas.

No imported top soil is to be used within the root zones of trees to be protected. Any preparation of Mulch is to be supplied to all garden beds and is to be an organic type laid to a minimum depth of towards it. Provide a root anchor if trees are to be planted in a windy location. existing soil for planting within these areas is to be done by hand only. Holes (e.g. as the result of plant 75mm, consisting of fine dark coloured chipped or shredded pine bark or hardwood with not more than removal) and uneven soil levels may be patched using topsoil as specified below.

Any imported topsoil is to be free of weeds, rubble and other materials damaging to plant growth and is free of damaging matter such as soil, weeds and sticks and is to be stockpiled and thoroughly layers. Avoid differential subsidence and excess compaction and produce a finished surface that is to be of a medium texture (sandy loam) with a pH of 6.0-7.0. Top soil is to be laid over a prepared weathered prior to delivery. Mulch is to be kept back 100mm from the stems of all plants to prevent graded evenly and ready for planting. Allow for 50mm layer of specified mulch to top of beds and a sub-base which has had any materials damaging to plant growth (e.g. rubble and large rocks) removed, collar rot. spread to the appropriate depth and cultivated into the existing site soil to a minimum depth of 150mm.

100mm on lawn areas and 300mm on excavated planting beds.

#### Weed Removal

All weeds shall be thoroughly removed. All vegetative material, including roots and rhizomes of Timber Edges vegetative material shall be appropriately disposed of off site in a manner which will not allow their be provided at joins in the plinth. re-establishment elsewhere. Any chemical controls are to be used in accordance with manufacturer's instructions and standard occupational health and safety procedures.

also implies that any herbicides used are suitable for use around the vegetation to be retained.

### Planting

Planting shall be carried out using accepted horticultural practices with all plants conforming to the species, size and quantities indicated on the Landscape Plan and Plant Schedule. Plants shall be Lawn - Turf thoroughly soaked through immersion in water prior to planting and if the planting soil is very dry then 'Sapphire' Soft Leaf Buffalo turf (or similar) is to be supplied to lawn areas as shown. Turf is to be fertilising, weeding, pruning, pest and disease control, cultivation, re-staking and replacement of any the planting hole is also to be filled with water and allowed to drain completely.

All plants shall be appropriately hardened off in the nursery. Use plants with the following laying. All lawn areas are to be thoroughly watered following planting and fertilised with an appropriate characteristics: Large healthy root systems with no evidence of root curl or pot bound restriction or lawn starter at the quantities recommended by the manufacturer. damage, vigorous, well established, free from disease and pests and of good form, consistent with the species or variety.



REVISION JOHN PATRICK LANDSCAPE ARCHITECTS PTY LTD 324 Victoria Street. Richmond, VIC 3121 +61 3 9429 4855

F +61 3 9429 8211 admin@johnpatrick.com.au

www.johnpatrick.com.au

Planting holes for shrubs and groundcovers are to be of minimum size 75mm larger than the planting Raised Planter Boxes

5% fines content by volume (preferably zero fines). The average size of the woodchip must be approximately 10mm x 20mm x 5mm and the maximum length is not to exceed 30mm. Mulch shall be Supply and spread evenly a special lightweight planter mix. (to be advised) Compact evenly in 100mm

Aggregate Gravel Surface Imported top soil is to be lightly and uniformly compacted in 150mm layers to a minimum depth of Aggregate gravel is to be installed where shown comprising of a 50mm layer of gravel (7-14mm granite Repair/Restoration of damaged Nature-strips screenings or similar, no fines) over a base course of 75mm deep gently compacted Fine Crushed Nature strips are to be restored to current grades with any depressions filled with topsoil to Rock. The subgrade is to be appropriately compacted. specifications above and lightly compacted in 150mm layers. Areas are then to be re-seeded

using an appropriate and matching turf type and the area fenced off to allow the re-establishment of non-woody perennials and woody suckering weeds, is to be removed or appropriately controlled using Provide 75 x 25mm treated pine edges to all borders between gravel mulch paths and garden beds lawn. Re-seeded areas are to be well irrigated and the area supplied with a slow release fertiliser at chemical means. The stumps of non-suckering woody perennials are to be stump ground. All using 75x25x300mm long treated pine stakes at 1200mm maximum centres. An additional stake is to the quantities recommended by the manufacturer.

Mulch

An approved drip irrigation system is to be supplied to all landscape areas. An approved pop-up spray Care must be taken to ensure that all trees to be retained are not damaged during weed removal. This system is to be supplied to all lawn areas. It is the responsibility of the contractor to ensure that all Plant Establishment Period irrigation meets manufacturers specifications. The system is to be connected to mains supply and There shall be a 13 weeks Plant Establishment Period following the approval of Practical Completion include a rain-shut off device. All dripline is to be buried with approx. 50mm of topsoil cover and shall by the responsible authority. During this period the landscape contractor shall make good all defects in be anchored at regular intervals to ensure the tubing cannot be dislodged.

Α

supplied by a specialist grower and is not to be allowed to dry out between cutting and laying. Turf plants that fail with plants of the same species and size. should be laid in a stretcher pattern so that joints are staggered and is to be lightly tamped following

DATE BY As per Council RFI requirements 24/07/20 ML As per Council RFI requirements 20/08/20 ML

Drainage cells are to be provided at the base of the planter and are to be covered with a layer of filter fabric. A drainage outlet is to be installed in the base of the planter with the floor of the planter sloped

finished level 25-50mm below the planter rim. Drip irrigation as specified is to be installed beneath the mulch laver.

Any areas of lawn which have failed to germinate (achieve an evenly green 95% covering of a consistent height) are to be re-seeded within one month of original sowing date.

his/her scope of works. Maintenance and Establishment means the care and maintenance of the contract area by accepted horticultural practices, as well as rectifying any defects that become apparent in the work under normal use. This shall include, but shall not be limited to watering,

CLIENT Eddie Liu (on behalf of) **Alpine Group** PROJECT


Proposed Residential Development

727-729 Toorak Road Kooyong

DRAWING Landscape Plan - Ground Floor for Town Planning



SCALE 1:100 @A1 DATE AUG 20 DRAWN CHECKED KD JOB NO 20-37 D₩G NO TP01 CAD FILE 20-371 TPL 240720.dwg

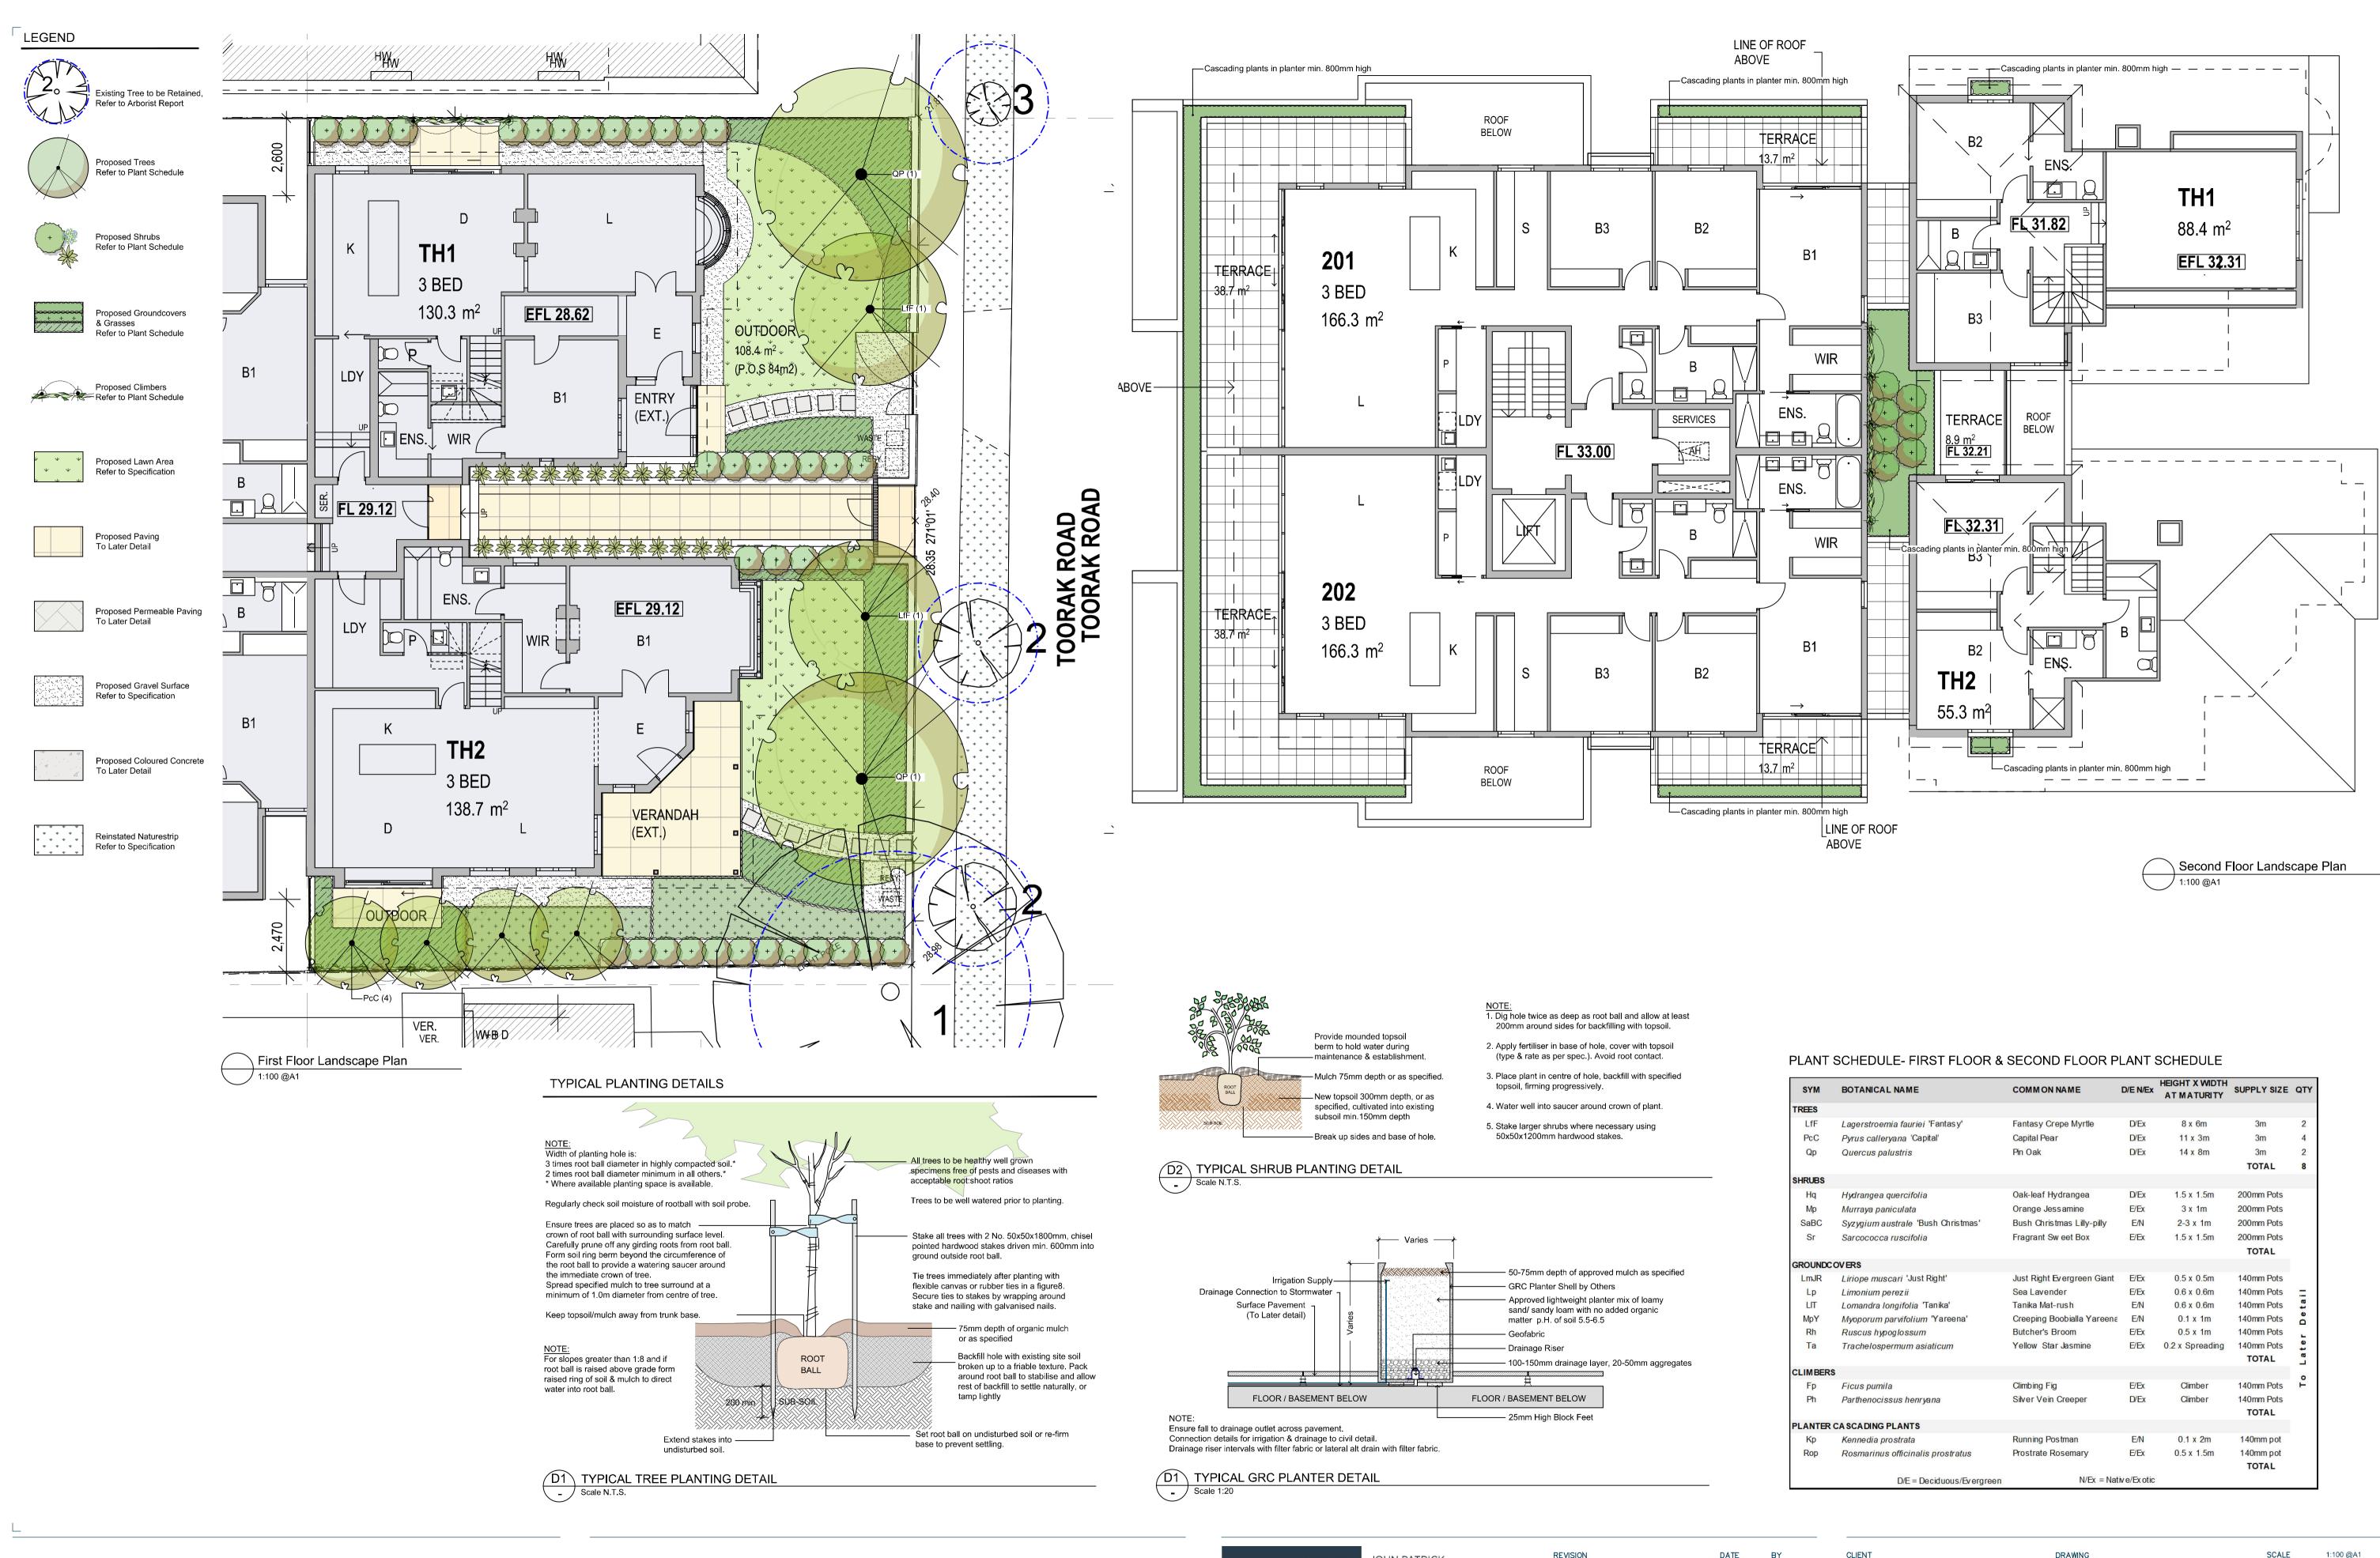

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REVISION DATE JOHN PATRICK As per Council RFI requirements 24/07/20 ML LANDSCAPE ARCHITECTS PTY LTD Α As per Council RFI requirements 20/08/20 ML 324 Victoria Street, Richmond, VIC 3121 T +61 3 9429 4855 F +61 3 9429 8211 admin@johnpatrick.com.au www.johnpatrick.com.au

			HEIGHT X WIDTH		
BOTANICAL NAME	COMMONNAME	D/E N/Ex	ATMATURITY	SUPPLY SIZE	QTY
Lagerstroemia fauriei 'Fantasy'	Fantasy Crepe Myrtle	D/Ex	8 x 6m	3m	2
Pyrus calleryana 'Capital'	Capital Pear	D/Ex	11 x 3m	3m	4
Quercus palustris	Pin Oak	D/Ex	14 x 8m	3m	2
				TOTAL	8
Hydrangea quercifolia	Oak-leaf Hydrangea	D/Ex	1.5 x 1.5m	200mm Pots	
Murraya paniculata	Orange Jessamine	E/Ex	3 x 1m	200mm Pots	
Syzygium australe 'Bush Christmas'	Bush Christmas Lilly-pilly	E/N	2-3 x 1m	200mm Pots	
Sarcococca ruscifolia	Fragrant Sw eet Box	E/Ex	1.5 x 1.5m	200mm Pots	
				TOTAL	
VERS					
Liriope muscari 'Just Right'	Just Right Evergreen Giant	E/Ex	0.5 x 0.5m	140mm Pots	
Limonium perezii	Sea Lavender	E/Ex	0.6 x 0.6m	140mm Pots	Ξ
Lomandra longifolia 'Tanika'	Tanika Mat-rush	E/N	0.6 x 0.6m	140mm Pots	eta
Myoporum parvifolium 'Yareena'	Creeping Boobialla Yareena	E/N	0.1 x 1m	140mm Pots	De
Ruscus hypoglossum	Butcher's Broom	E/Ex	0.5 x 1m	140mm Pots	-
Trachelospermum asiaticum	Yellow Star Jasmine	E/Ex	0.2 x Spreading	140mm Pots	te
				TOTAL	La
					0
Ficus pumila	Climbing Fig	E/Ex	Climber	140mm Pots	F
Parthenocissus henryana	Silver Vein Creeper	D/Ex	Climber	140mm Pots	
				TOTAL	
A SCADING PLANTS					
Kennedia prostrata	Running Postman	E/N	0.1 x 2m	140mm pot	
Rosmarinus officinalis prostratus	Prostrate Rosemary	E/Ex	0.5 x 1.5m	140mm pot	
				TOTAL	
D/E = Deciduous/Evergreen	N/Ex = Nat				

#### CLIENT Eddie Liu (on behalf of) **Alpine Group**

PROJECT **Proposed Residential** 

Development 727-729 Toorak Road Kooyong

DRA₩ING Landscape Plan - First & Second Floor for Town Planning

SCALE DATE DRA₩N CHECKED JOB NO DWG NO

1:100 @A1 AUG 20 ML KD 20-371 **TP01** CAD FILE 20-371 TPL 240720.dwg