


BASEMENT FLOOR PLAN, LANDSCAPE NOTES 1:100 1:100 1-100 1:100 DETAILED SITE ANALYSIS - NEIGHBOURHOOD AND 1:200

1:200

DETAILED SHADOW ANALYSIS - 9.00AM, 12 NOON 1.200

DETAILED SHADOW ANALYSIS - 2,00PM AND

1:100

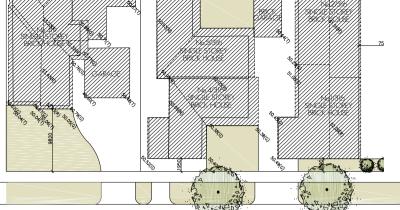

am



SUBJECT SITE

VINCENT STREET

115.7M² 110.2M² 87.1M² 34.3M² 347.3M2 (37.4SQ)

97.9M² 103.5M² 100.5M² 35.8M²

OVERALL 337.7M2 (36.3SQ) COURTYARD 45.6M² 36.9M² 22.8M² FRONT GARDEN (INCL. PORCH) SERVICE YARD 105 3 M² OVERALL

OVERALL BUILDING AREA BUILDING/SITE COVERAGE


IMPERVIOUS PAVING AREA 27.9M2 IMPERVIOUS PAVING/SITE 4.5% COVERAGE

PERMEABLE SITE COVERAGE 50.9%

322.2m² 50.6%

(I.E. PERMEABLE TO RAIN) GARDEN AREA **LEGEND** RETRACTABLE CLOTHESLINE

38 ANDERSON STREET, MALVERN EAS ANDERSON STREET

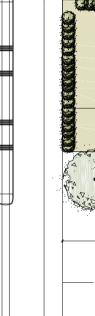

LIST OF CHANGES

- GROUND FLOOR LEVEL

- GROUND FLOOR EAST SETBACK INCREASED FOR BOTH DWELLINGS TO ENABLE 1000MM SEPARATION BETWEEN LIGHT WELLS AND EASTERN BOUNDARY. FIRST FLOOR LEVEL
- 4. FIRST FLOOR EASTERN SETBACK SLIGHTLY INCREASED FOR BOTH DWELLINGS ELEVATIONS

- FIRST FLOOR, FLOOR TO CEILING HEIGHT REDUCED FROM JODOMM TO 2700MM FOR BOTH DWELLINGS.
 COLOURS, MATERIALS AND FINISHES SCHEDULE ALTERED.
 IDELLING 1 FRONT FENCE CHANGED TO BRICK PIERS WITH STEEL INSERTS.
 PORCH AMMINGS REDUCED IN DEPTH.

TLETREE

PLANNING APPLICATION FOR PROPOSED 2NO.DWELLINGS 38 ANDERSON STREET, MALVERN EAST DRAWING TITLE SITE PLAN, AREA ANALYSIS

TPA01 - 1 OF 10 DATE: 25TH AUGUST 2022 JOB No: 19-12 SCALE: 1:200

DRAWN BY: ANDREW K. FOR DISCUSSION

AUSTRALIAN HEIGHT DATUM



R.CONC PAVING

LEVEL 1 / 173 UPPER HEIDELBERG ROAD IVANHOE 3079

PH: (03) 9 499 8826 EMAIL: office@petridisarchitects.com.au

LANDSCAPING NOTES

THIS LANDSCAPE PLAN IS BASED ON THE ARCHITECT'S TOWNPLANNING AND IS TO BE USED FOR OWNPLANNING PURPOSES ONLY.

3. SPRAY ALL AREAS SHOWN ON THE DRAWNIGS AS GARDEN BED AND LAWN WITH AN APPROVED NON-RESIDUAL CONTACT HERBIDOZE (GLYPHOSATE) FOLLOWING MANUFACTURER'S SPECIFICATIONS. THE HERBIGICUS SHALL BE DUTCH BETO ID DENTIFY EXPOSOR DAEAS, LEAVE SPRAYED AREAS FOR A PEGICO OF 10 DAYS PROOR TO BEING WORKED, RESPRAY ANY WEDGS STILL AUTE, ATTENT 10 DAYS.

4. DETERMINE pH OF SOIL USING pH KIT AVAILABLE AT MOST NURSERIES. pH SHOULD BE SUGHTLY ACDIC TO NEUTRAL pH.5. TO 7.0. IF pH IS OUTSIDE OF THIS RANGE CONTACT YOUR LOCAL NURSERY TO GBTAIN ADVICE ON HOW TO ADJUST THE pH LEVEL. SOME PLANTS TOLERATE HIGH AND LOW pH LEVELS.

IF SOIL IS MAINLY DAY BASED ADD GYPSUM TO AID IN BREAKING UP THE SOIL AT THE RATE OF 1.5KG/M2 TO LAWN AREAS AND 2KG/M2 FOR GARDEN BED AREAS.

INSTALL SUB-SURFACE DRAINAGE WHICH DISCHARGES TO STORMWATER OR SOAKAGE PITS IN AREAS WITH POOR DRAINAGE

CULTIVATE SOIL FOR GARDEN BED AREAS TO 300MM DEPTH AND LAWN AREAS TO 100MM DEPTH, DEEP RIP IN TO 400MM DEPTH AREAS OF HARD—PANNING OR COMPACTION.


USE ON-SITE TOPSOIL WHERE POSSIBLE AND IMPROVE WITH ORGANIC MATERIAL AS REQUIRED, IMPORTED TOPSOIL SHALL. BEF FERRIE, FRABLE SOILS CONTAINING ORGANIC MATTER AND FREE FROM PERENNIAL WEEDS AND THEIR ROOTS, STONE OR RUBBLE, CLODS OF TOPSOILS AND OTHER EXTRARGOUS MATERIAL.

APPLY FERTILISER SPECIFIC TO INDIVIDUAL PLANTS REQUIREMENTS. TREES SHOULD BE STAKED FOR THE FIRST ONE TO TWO YEARS (AS PER DETAIL).

ALL CUMBERS WILL REQUIRE A WIRE OR TRELLIS CLIMBING FRAME TO BE ATTACHED TO ADJACENT SURFACE.

14. INSTALL TIMBER EDGING BETWEEN ALL LAWN AREAS AND GARDEN BEDS

16. GARDEN BEDS ARE TO BE WATERED, WEEDED, FERTISED, PRUNED AND MULCHED ON A RECULAR BASS BY A LANGSCAPE CONTRACTOR OR THE OWNER TO DISSURE PLANTS SURVIVE AND HIRWEY. THIS S TO TAKE PLACE FOR A PERGOD OS SYM MONITHS AFTER COMMETION OF REPLACED WITH THE SAME SPECIES AS USETED IN THE PLANT SCHEDULE.

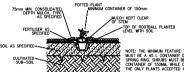


TUBE/POT PLANTING

NOT TO SCALE




TIMBER EDGE - PLAN NOT TO SCALE

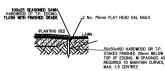

TIMBER EDGE - SECTION

NOT TO SCALE

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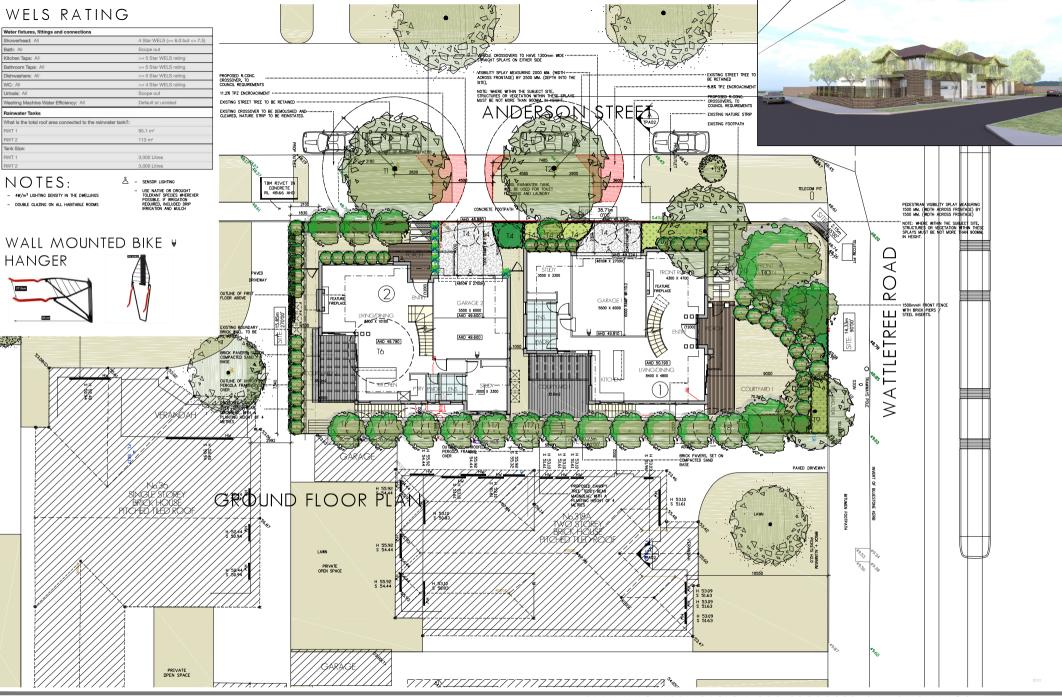


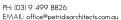ANDERSON STREET, MALVERN EAST

BASEMENT FLOOR PLAN, LANDSCAPE NOTES
TPA 02 - 2 OF 10 DATE: 25TH AUGUST 2022 DRAWN BY: ANDREW K. JOB No: 19-12 SCALE: 1:100

ALL LEVELS ARE TO FOR DISCUSSION AUSTRALIAN HEIGHT DATUM





LEVEL 1 / 173 UPPER HEIDELBERG ROAD IVANHOE 3079

PH: (03) 9 499 8826 EMAIL: office@petridisarchitects.com.au PLANNING APPLICATION FOR PROPOSED 2NO.DWELLINGS

38 ANDERSON STREET, MALVERN EAST

DRAWING TITLE

GROUND FLOOR PLAN

GROUND FLOOR PLAN

TPA03 - 3 OF 10 DATE: 25TH AUGUST 2022

JOB No: 19-12 SCALE: 1:100

DRAWN BY: ANDREW K. FOR DISCUSSION













SOUTH ELEVATION COLOURS, MATERIALS AND FINISHES SCHEDULE

WALLS:

RENDER-

WINDOWS

FRONT DOOR:







SELECT CEMENT RENDER



NOTES:

- 4W/m2 LIGHTING DENSITY IN THE DWELLINGS
- DOUBLE GLAZING ON ALL HABITABLE ROOMS

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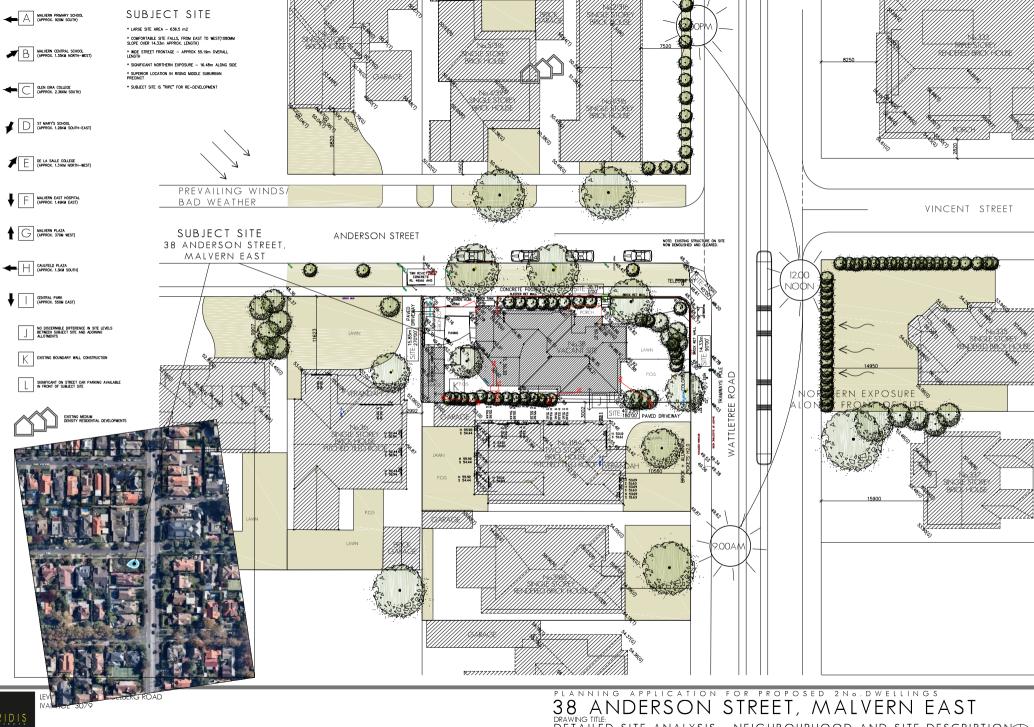
38 ANDERSON STREET, MALVERN EAST DRAWING TILLE. ELEVATIONS, COLOURS, MATERIALS AND FINISHES SCHEDULE

LOUVRE SCREEN DETAIL

TPA 05 - 5 OF 10 JOB No: 19-12

DATE: 25TH AUGUST 2022 DRAWN BY: ANDREW K. SCALE: 1:100 FOR DISCUSSION






PH: (03) 9 499 8826 EMAIL: office@petridisarchitects.com.au DETAILED SITE ANALYSIS - NEIGHBOURHOOD AND SITE DESCRIPTION TPA 06- 6 OF 10 DATE: 25TH AUGUST 2022 DRAWN BY: ANDREW K. ALL LEVELS ARE TO JOB No: 19-12 SCALE: 1: 200

FOR DISCUSSION

AUSTRALIAN HEIGHT DATUM

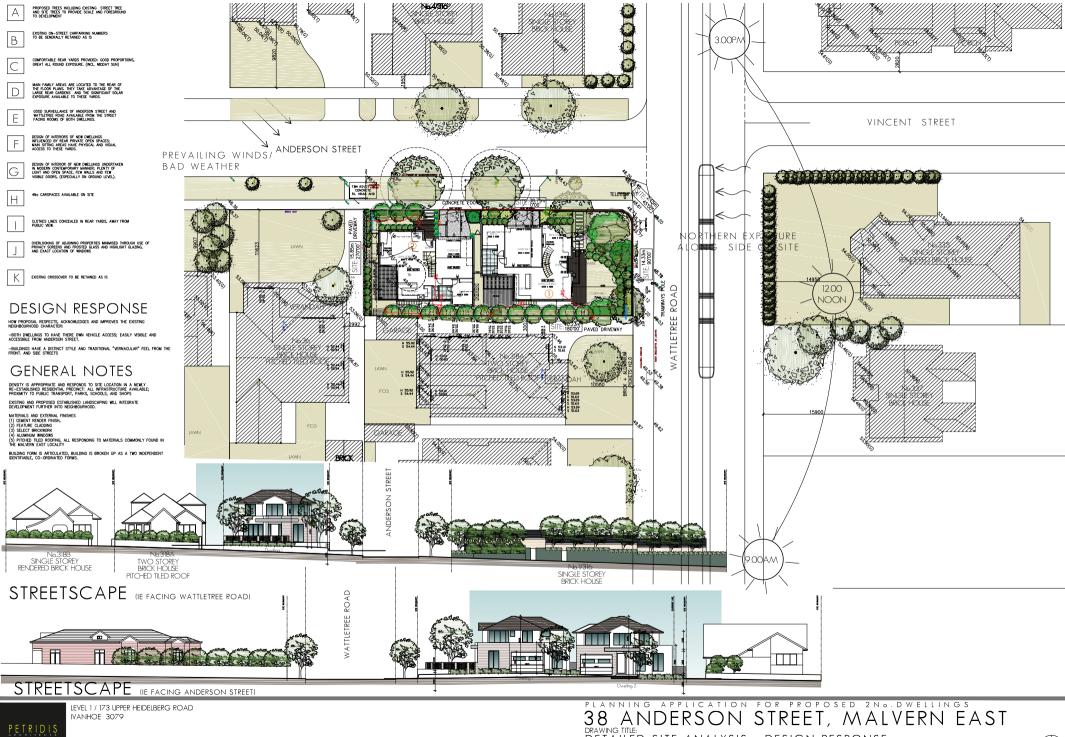

TPA 07 - 7 OF 10

JOB No: 19-12

IVANHOE 3079


PH: (03) 9 499 8826 EMAIL: office@petridisarchitects.com.au

DETAILED SITE ANALYSIS - DESIGN RESPONSE

DATE: 25TH AUGUST 2022 DRAWN BY: ANDREW K. SCALE: 1:200 FOR DISCUSSION





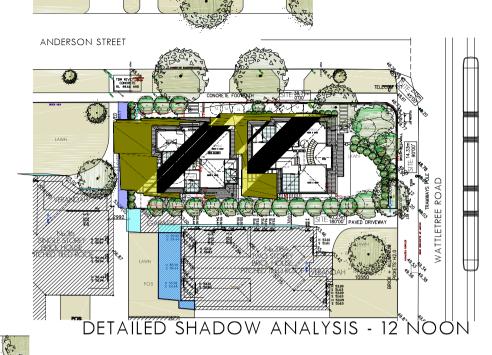










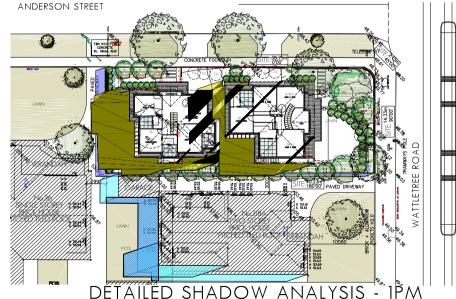

LEVEL 1 / 173 UPPER HEIDELBERG ROAD IVANHOE 3079

PH: (03) 9 499 8826 EMAIL: office@petridisarchitects.com.au

38 ANDERSON STREET, MALVERN EAST DETAILED SHADOW ANALYSIS-9.00 AM, 12 NOON, 1.00 PM SEPTEMBER 22

TPA08 - 08OF 10 JOB No: 19-12

DATE: 25TH AUGUST 2022 DRAWN BY: ANDREW K. ALL LEVELS ARE TO SCALE: 1:200 FOR DISCUSSION AUSTRALIAN HEIGHT DATUM









EXISTING SHADOWS, DUE TO ADJOINING RESIDENCES



EXISTING SHADOWS, DUE TO FENCES



LEVEL 1 / 173 UPPER HEIDELBERG ROAD IVANHOE 3079



GARDEN AREA ANALYSIS DEFINITION UNDER CLAUSE 72


STONNINGTON PLANNING SCHEME AN UNCOVERED OUTDOOR AREA OF A DIVELLING OF RESIDENTIAL BUILDING NORMALLY ASSOCIATED WITH A GARDEN, — IT INCLUDES OFTEN ENTERTAINED, AREAS, ECEKS, LAWNS, GARDEN BEDS, SWMAMNG POUS, TENHIS COURTS AND THE LIKE.

IT DOES NOT NOLUZE A DIREVAY, ANY AREA EST ASDE FOR CAR PARKING, ANY BUILDING OR ROOTED AREA AND ANY AREA THAT HAS A DIMENSION OF LESS THAN I SHERT.

SITE AREA


636.5m2 GARDEN AREA 50.6% (322.2m2)



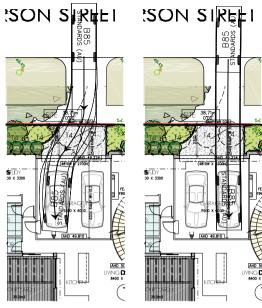


SWEPT PATH DIAGRAM DWELLING 1

SWEPT PATH DIAGRAM DWELLING 1

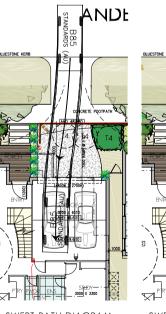

SWEPT PATH DIAGRAM DWELLING 2

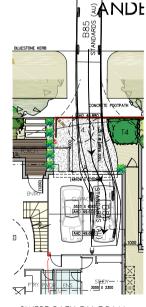

SWEPT PATH DIAGRAM DWELLING 2

LEVEL 1 / 173 UPPER HEIDELBERG ROAD IVANHOE 3079

PH: (03) 9 499 8826 EMAIL: office@petridisarchitects.com.au 38 ANDERSON STREET, MALVERN EAST GARDEN AREA ANALYSIS, SWEPT PATH DIAGRAMS

TPA10 - 10 OF 10 DATE: 25TH AUGUST 2022 DRAWN BY: ANDREW K. JOB No: 19-12 SCALE: 1:100

FOR DISCUSSION



Existing Vegetation Summary

Extracted from vegetation audit and report prepared by Bluegum. (13/12/201)		
TREE NO.	BOTANICAL NAME	HXW(m
1.	Fraxinus angustifolia CV	5×6
2.	Fraxinus angustifolia CV	7 x 8
3.	Fraxinus angustifolia CV	6 x 2
4.	Pyrus calleryana	5.5 x 1.5
5.	Fagus sylvatica	6.5 x 8
6.	Jacaranda mimosifolia	5.5 x 8
7.	Olea europaea	5 x 3
8.	Lagerstroemia indica CV	4 x 3
9.	Pittosporum undufatum	4.5 x 8
10.	Magnolia grandiflora	3 x 1
11.	Betula pendula CV	5.5 x 6

Specifications

Subgrade properation

Size proposition to See Interest Conscionate with text front Coulting product any of order subble See proposition to be control organized and seed to the interesticate. These controlled product and seed to extract the controlled product and seed to extract the controlled product many drawings and structures or profile as not acceptable. Sub-grade to all laws and primed series in the college and the controlled profiled are set in the college and the controlled profits of the set in the college and the controlled profits of the college and the college and

Soil Proposation. Toposi is to be operad in maximum 150mm layers, lightly compacted by use of a 150 - 200kg roller, or by throughly walking until it accords with finished kind levels or to within 75mm below edging levels to accommodate much in-special purpose granted and and lightly compacted toposi for gardes beds in 5 bits medicine this time general purpose granted and and lightly compacted to minimum 35mm exhibit to granter backs. Soil is to comply with a 2.a. 2023-3978, with of follows:

free from perennial weeds and their roots, bulbs and rhizomes free from building rubble and any other matter deleterious to plant growth ph to be 6.0 - 7.0 texture to be light to medium friable loam free from silt material

as a considered depth of Time.

Participa Procedure.

If all to planning holds as y'. If the what and allow to date completely. The motors are to be left and by prefer policy and the procedure of the procedure

Part Establishmen Privat

The Instructure is to be ameritared by applying best frustructural part of the promote healthy plant
part throw the virtual part of the private frustructural part of the part of the private frustructural part of the part of the private frustructural part of the part o

Irrigation
An in-ground automatic drip irrigation system to be installed to all garden areas and planter boxes (
if applicable) in accordance with current local watering regulations

urainage Landscape and / or building contractor(s) are responsible for civil and hydraulic computations fo landscape building works including, but not limited to surface and sub surface drainage for all landscape areas prior to commencement of works

scale from plan - contractor to verify all dimensions on site prior to commencing

Plants - Quality of Tires and Bhrubs

Tires and vibrubs and be healthy receively stock the from insects, classess and excels. The

Tires and vibrubs and be healthy receively stock the from insects, classess and excels. The

Illustration of the plants of the control of the control of the control of the responsible

surface of the resident of the control of the control of the control of the responsible

surface) in resident, and the control of the contro

All existing vegetation shown on the endorsed plan (subject site and neighbouring properties) to be retained must be suitably manifed before any development (including demollion) commences on the land and the vergotion must not be removed, destroyed or looped willout the written consent of the responsible authority, Before the commencement of works (including demollion) statt, the optotection benefits must be erected around trees (subject les and neighbouring properties) to from a defined tree protection zone using demollions and construction in accordance with the protection measures are part 64-070-2007 (Tier genetication in development).

Any pruning that is required must be carried out by a trained and competent arboirst with a thorough inoxietige of the physiology and pruning methods to carry out pruning to the Australian standard - AS 4372-2007 (Pruning of amenty tees). All these protection practices must be adhered to in accordance with the arboiroulbural report and to the satisfaction of the responsible authority.
















Proposed timber decking Proposed paver step-stones







Advanced Tree Planting

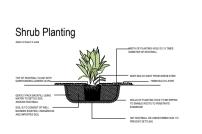

Surface Finishes Detail

Garden Beds



Topping / Pebble areas

I awn areas



 PROJECT
 PROPOSED DUAL OCCUPANCY

 ADDRESS
 38 ANDERSON STREET MALVERN EAST

 DATE
 16 08 2022
 PROJECT
 PROJECT NO. # L9387 SHEET SIZE AI REV #
DESIGNED BY: N.H./MA landscape Arch. UEL/UK DRAWN BY:

Plant Schedule

Figus hilli 'Emerald Standard Figus'

Pyrus calleryana 'Capital'

Acmena smithii var 'Minor'

GROUND COVERS & LOW SHRUBS

TUSSOCKS / GRASSES / EVERGREEN PERENNIALS

COMMON NAME

Dronning She-Oak

Emerald Standard Figure

Capital Pear

Compact Lilly Pilly

Coast Rosemany

Yellow Buttons

Native Violet

QTY SUPPLY SIZE

20cm not

20cm pot

14cm pot

14cm pot

14cm pot

10 20cm pot

13 14cm pot

40tr / min 1.8m high 5m x 2.5m 40tr / min 1.8m high

MATURE H x W

3m x 1.5m

1.2m x 1.5m

2m x 1m

.5m x .7m

.1m x 1.5m

2m x 1m

Prostrate X .2

CODE BOTANICAL NAME

SHRUBS

Keystone Alliance Pty Ltd 277 Plenty Road Preston VIC 3072 E: nina@keystonealliance.e T 03 9478 8991 M W: keystonealliance.com.au



Landscape Plan -