

The State of Victoria does not warrant the accuracy or completeness of information in this publication and any person using or relying upon such information does so on the basis that the State of Victoria shall bear no responsibility or liability whatsoever for any errors, faults, defects or omissions in the information.


No Guarantee or warranty is given as to the accuracy or completeness of the details shown on this map. The City of Stonnington shall not be liable in any way for loss of any kind including, damages, costs, interest, loss of profits arising from error, inaccuracy, incompleteness of this information.



1050/21 – 19-21 Lalbert Crescent, Prahran = objection

Date printed: 18/11/2022

Scale: 1:1097

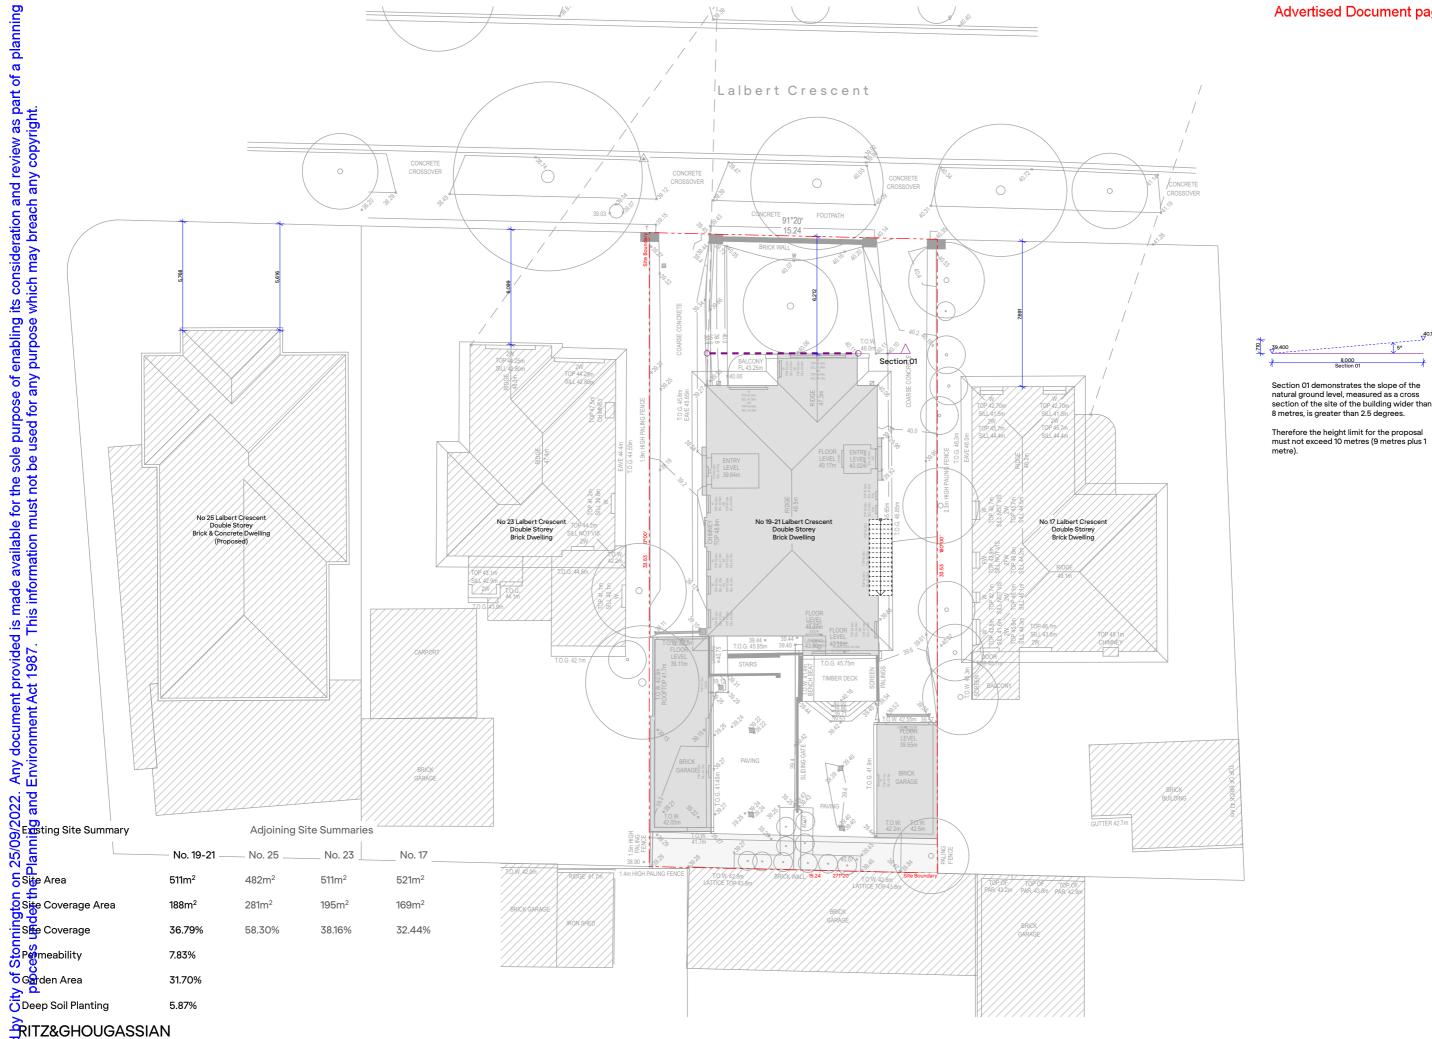

#RITZ&GHOUGASSIAN

ritzghougassian.com 2015—589 Malvern Road Toorak Victoria 3142 Australia

Client Laurelle & Gilad Ritz


Project 19-21 Lalbert Crescent

Site Plans - Existing

Drawing number Project number TP1010 210612

Date generated 25/9/2022 03

Revision

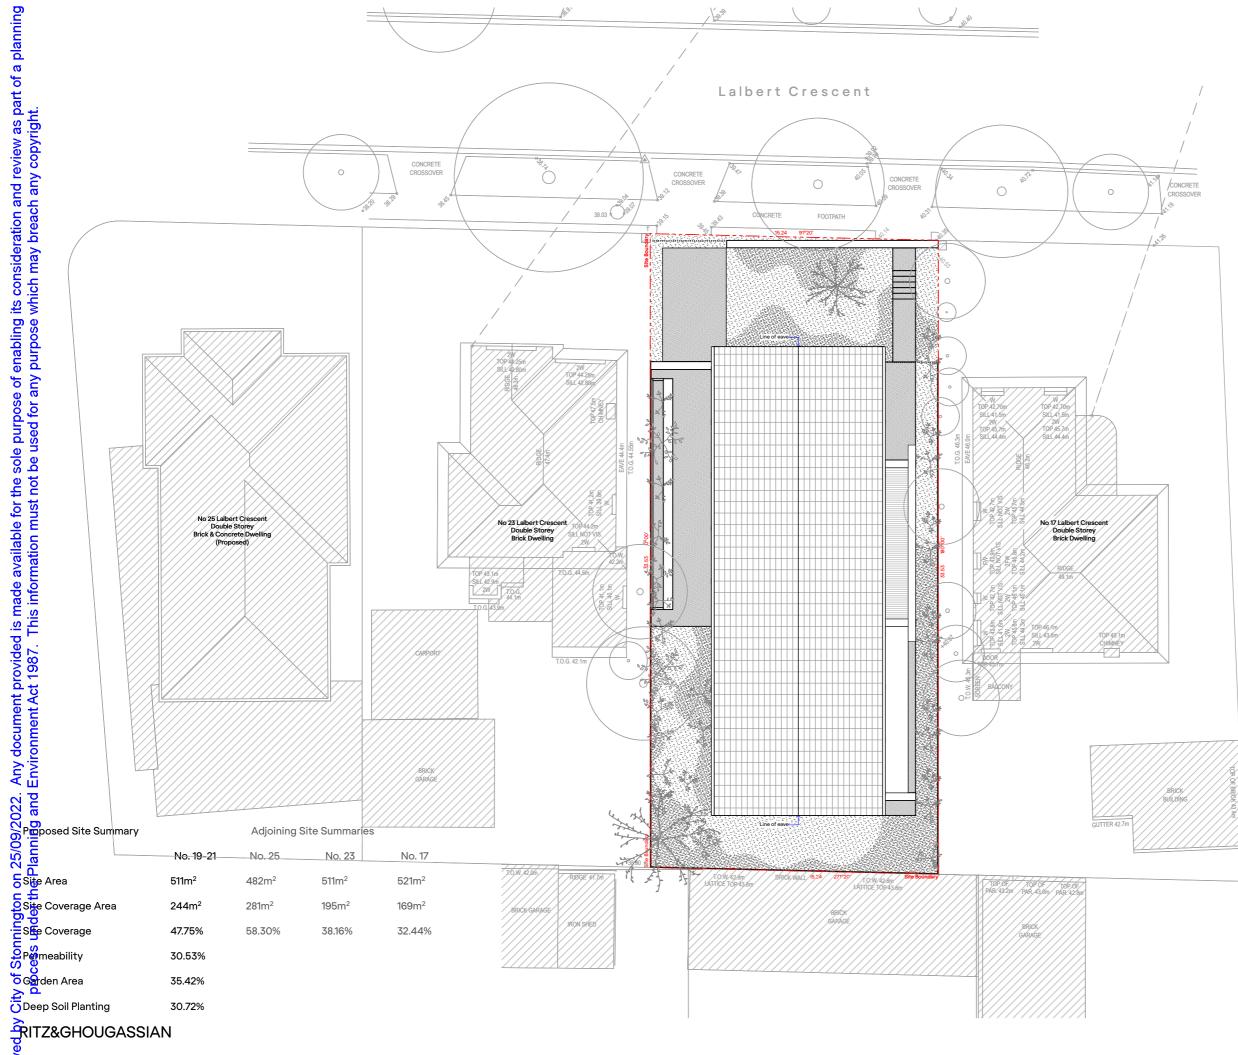

itzghougassian.com U5–589 Malvern Road Toorak Victoria 3142 Australia

Client Laurelle & Gilad Ritz

Project


19-21 Lalbert Crescent

Site Plans - Proposed

Drawing number Project number 210612 TP1020

Date generated 25/9/2022

Revision 03

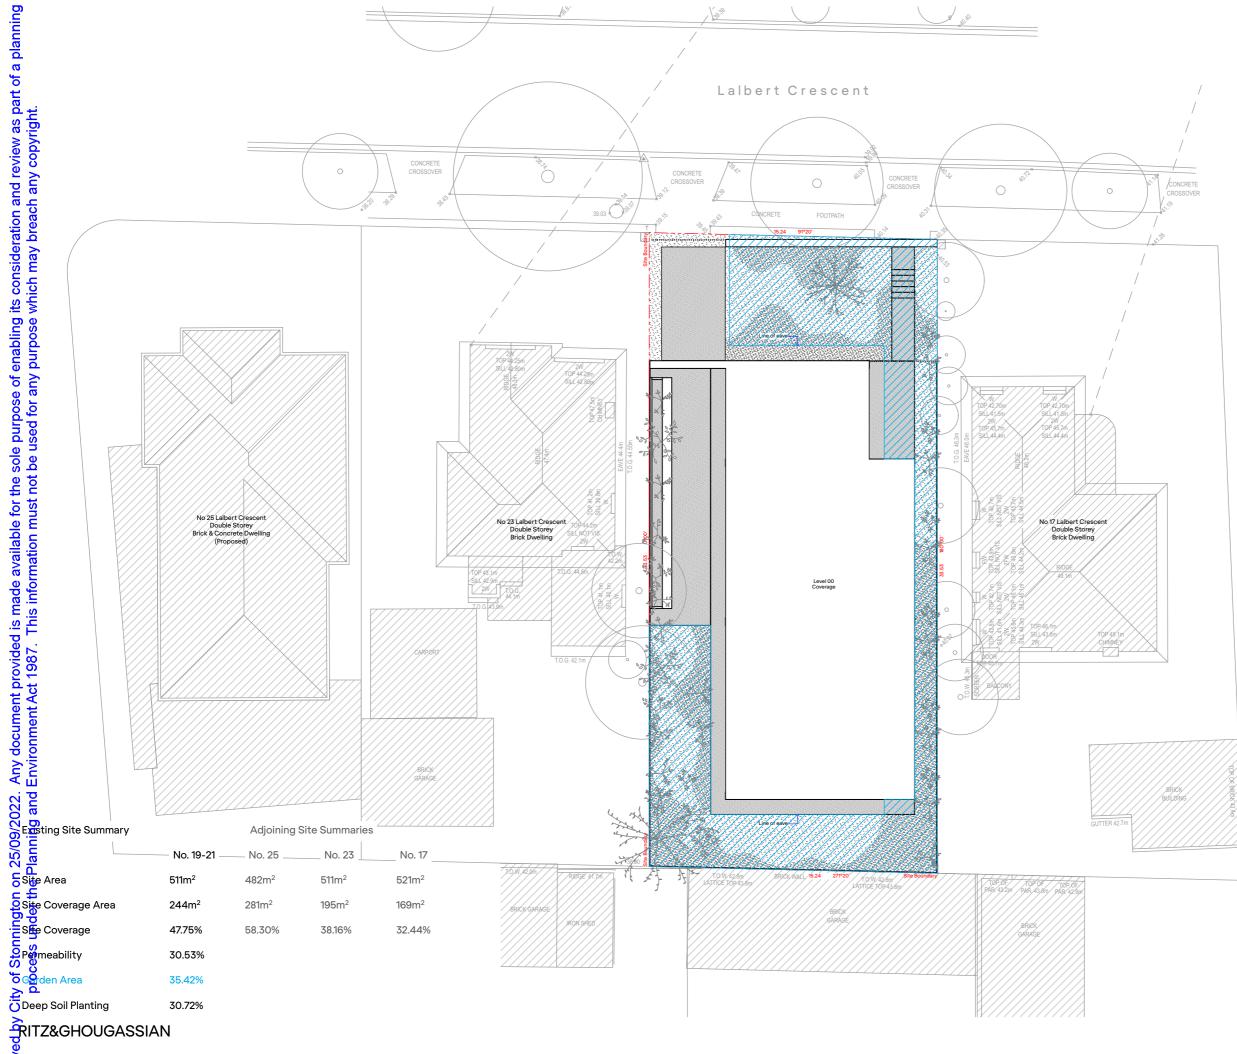

RITZ&GHOUGASSIAN

itzghougassian.com U5–589 Malvern Road Toorak Victoria 3142 Australia

Client Laurelle & Gilad Ritz

Project


19-21 Lalbert Crescent

Site Plans - Garden Area

Drawing number Project number 210612 TP1021

Date generated 25/9/2022

Revision 03

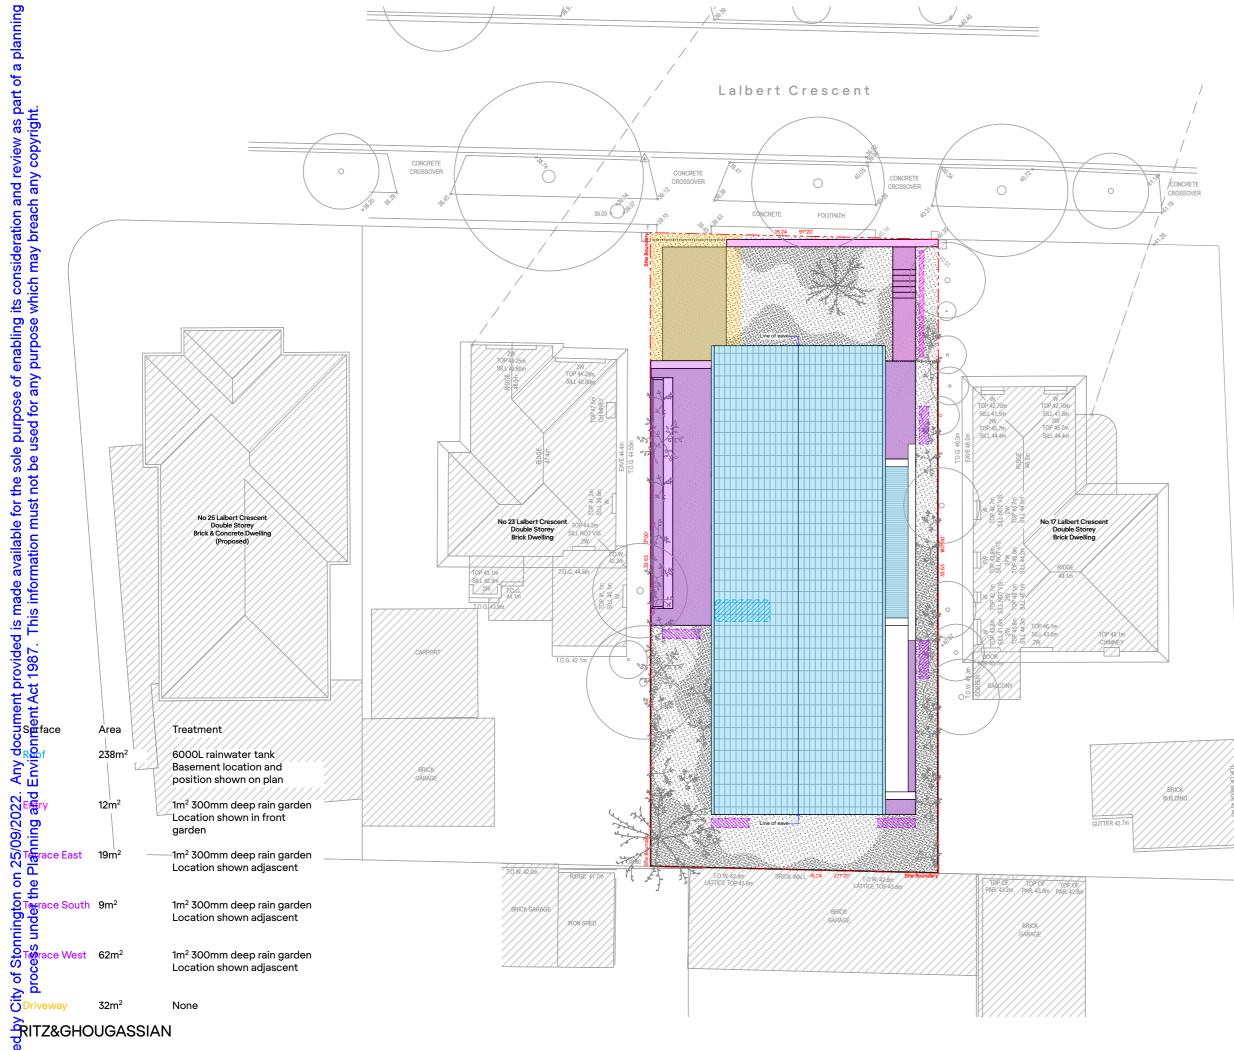

RITZ&GHOUGASSIAN

itzghougassian.com U5–589 Malvern Road Toorak Victoria 3142 Australia

Client Laurelle & Gilad Ritz

Project

19-21 Lalbert Crescent

Site Plans — Stormwater Management Plan

TP1030

Drawing number Project number 210612

Date generated 25/9/2022

Revision 03

Melbourne STORM Rating Report

1455506 TransactionID:

Municipality: STONNINGTON Rainfall Station: STONNINGTON 19-21 Lalbert Crescent Address:

Prahran

VIC 3181

Assessor:

Development Type: Residential - Dwelling

511.00 Allotment Site (m2): STORM Rating %: 101

Description	Impervious Area (m2)	Treatment Type	Treatment Area/Volume (m2 or L)	Occupants / Number Of Bedrooms	Treatment %	Tank Water Supply Reliability (%)
Roof	238.00	Rainwater Tank	6,000.00	4	103.90	99.10
Entry	12.00	Raingarden 300mm	1.00	0	133.10	0.00
Terrace East	19.00	Raingarden 300mm	1.00	0	133.10	0.00
Terrace South	9.00	Raingarden 300mm	1.00	0	134.00	0.00
Terrace West	62.00	Raingarden 100mm	1.00	0	124.05	0.00
Driveway	32.00	None	0.00	0	0.00	0.00

Date Generated: 25-Sep-2022 Program Version: 1.0.0

Storm Rating Report

50mm gravel mulch. 150mm sand/soil mix. 100mm sand. Agricultural drain.

Section - Rain Garden

TP1035

RITZ&GHOUGASSIAN

ritzghougassian.com U5–589 Malvern Road Toorak Victoria 3142 Australia

Client Laurelle & Gilad Ritz Project 19-21 Lalbert Crescent

Site Plans - Stormwater Management Details

Drawing number Project number 210612

Date generated 25/9/2022

Revision 03

Scale NTS @ A3



Pigmented concrete



Glazing both operable and fixed



Silver metal finish to various structural elements, surfaces and fencing




Terracotta roof tile





Fabric Awnings



Landscape

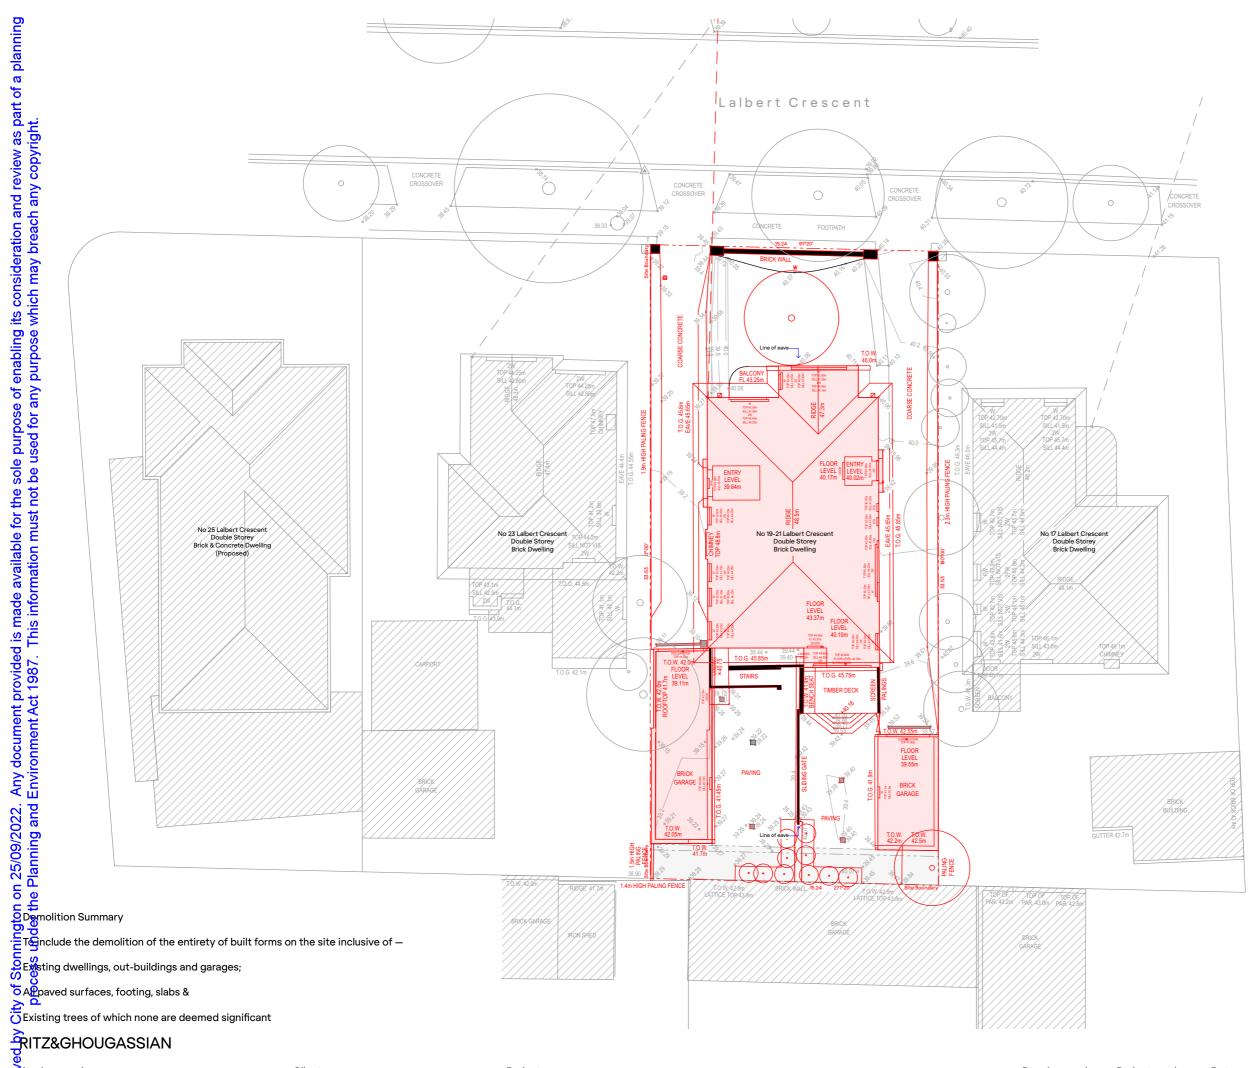

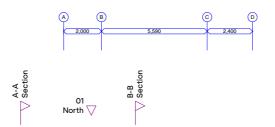

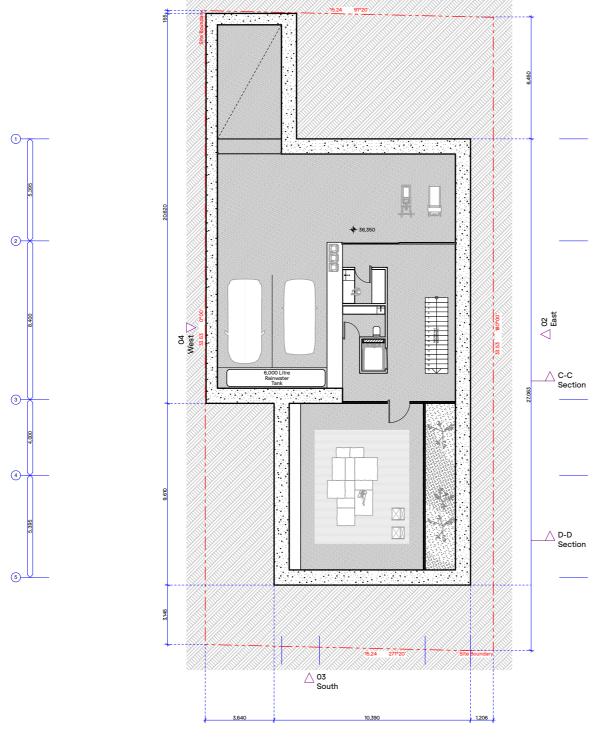

O Basement level does not project above NGL by more than 1.2 metres where it sits below levels 00 and 01 Therefore the proposal adheres to a two storey limit

RITZ&GHOUGASSIAN

Floor Plans - Level B1

TP2200

itzghougassian.com U5–589 Malvern Road Toorak Victoria 3142 Australia

Client Laurelle & Gilad Ritz

Project


19-21 Lalbert Crescent

Floor Plans - Level 00

Drawing number Project number 210612 TP2201

Date generated 25/9/2022

Revision 03

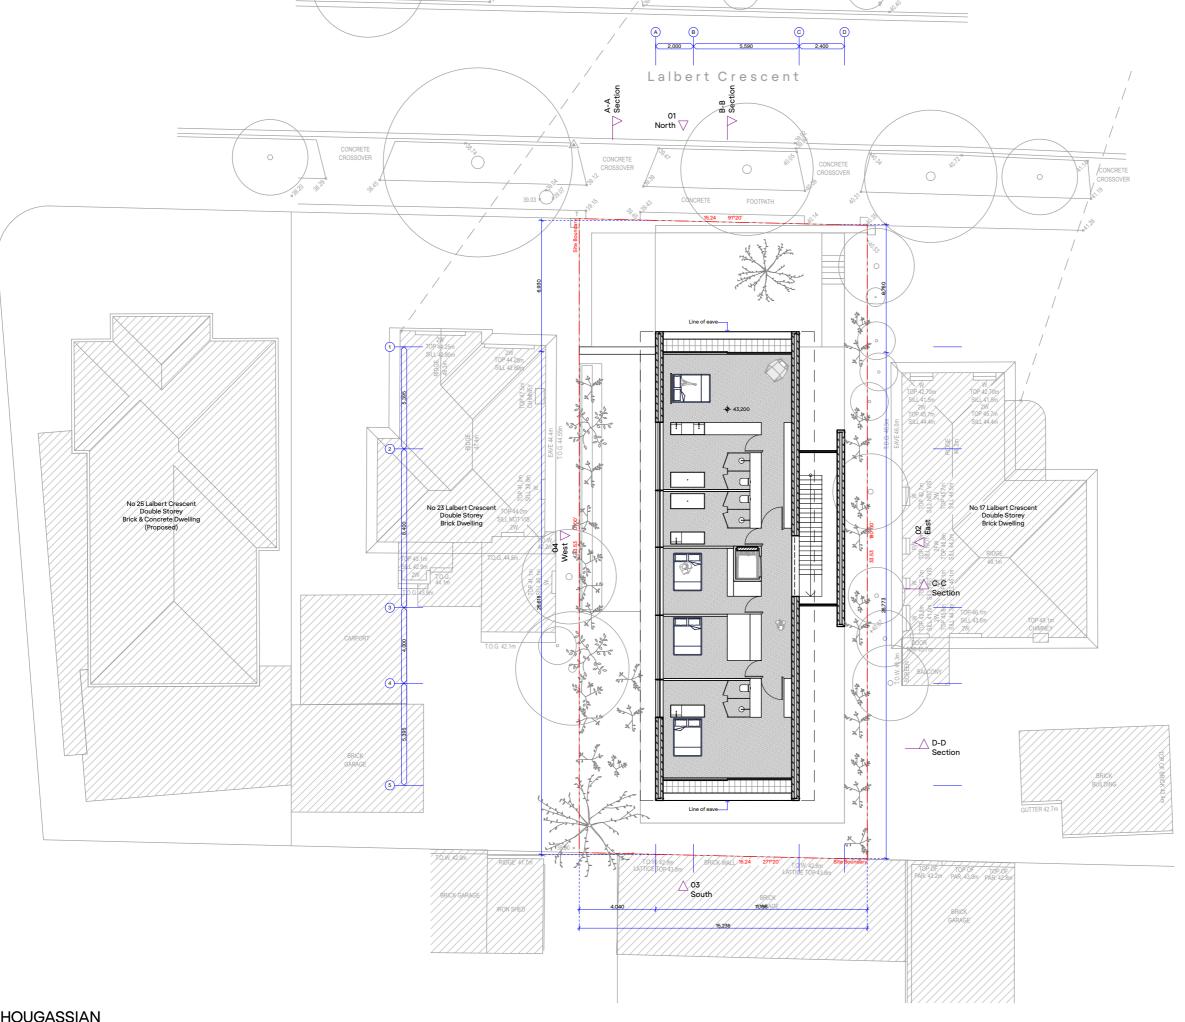

RITZ&GHOUGASSIAN

ritzghougassian.com U5–589 Malvern Road Toorak Victoria 3142 Australia

Client Laurelle & Gilad Ritz

Project 19-21 Lalbert Crescent

Floor Plans - Level 01

Drawing number Project number TP2202 210612

Date generated 25/9/2022 03

Revision Scale 1:200 @ A3

ritzghougassian.com U5–589 Malvern Road Toorak Victoria 3142 Australia

Client Laurelle & Gilad Ritz

Project


19-21 Lalbert Crescent


Floor Plans - Roof


Drawing number Project number TP2203 Project number 210612


Date generated 25/9/2022


Revision 03

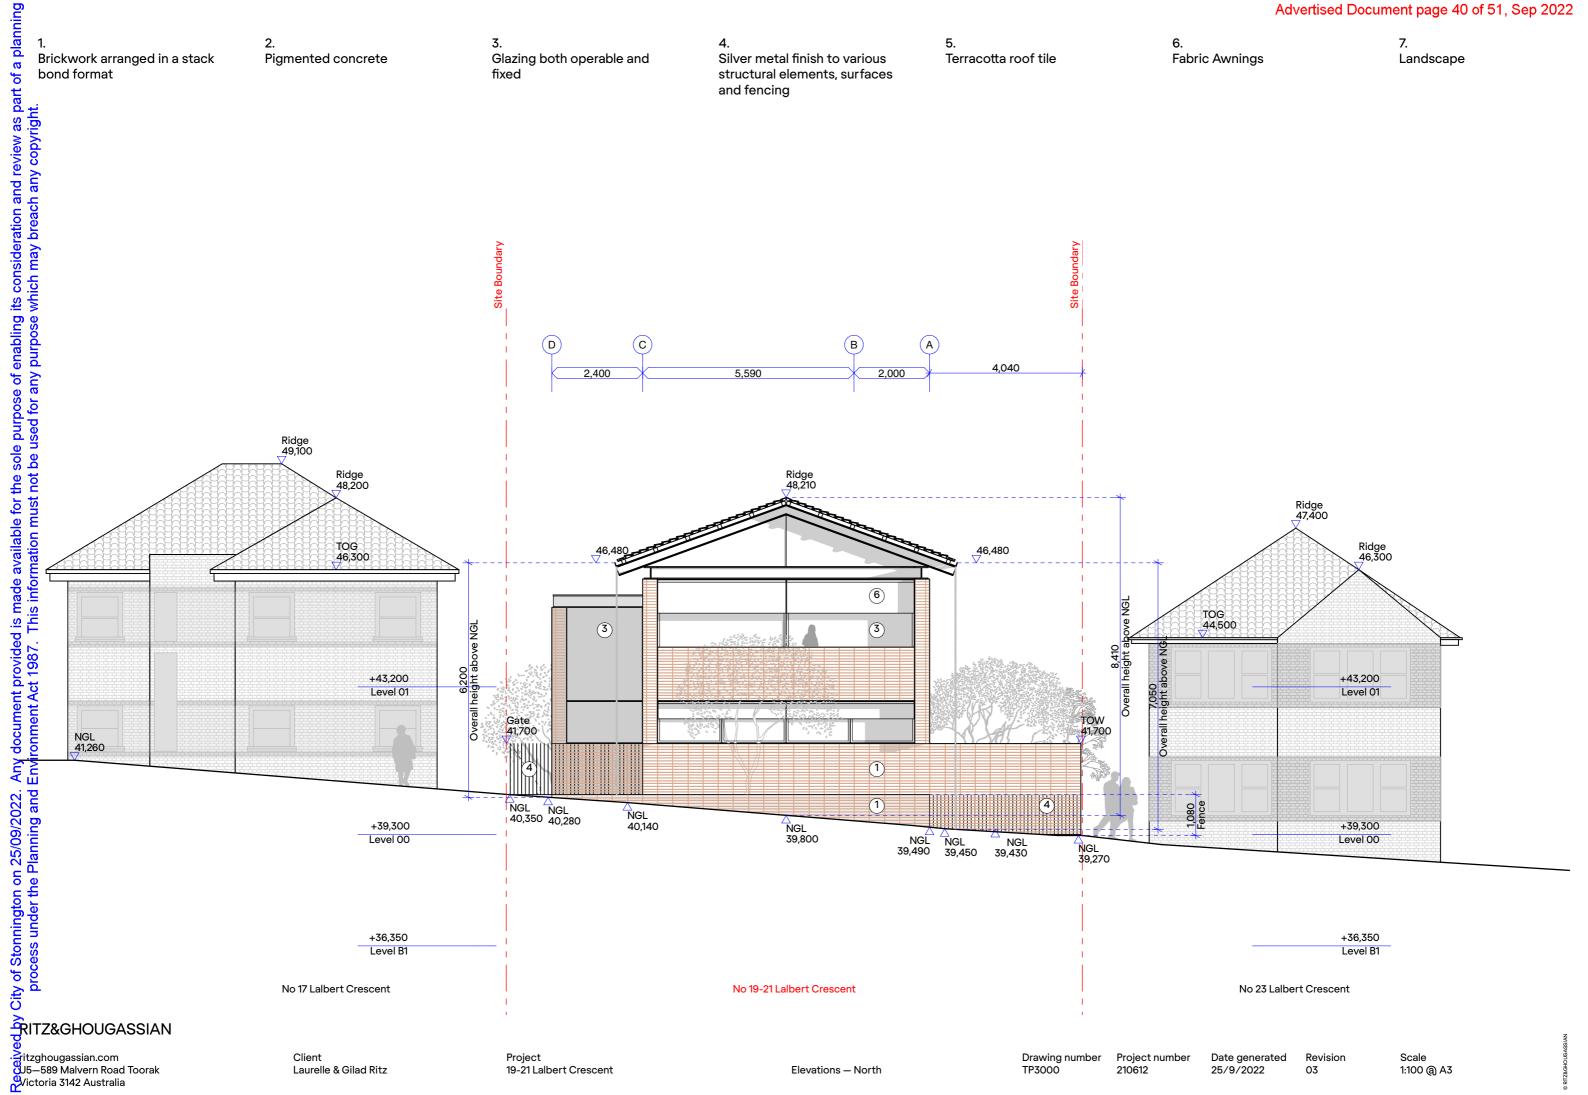


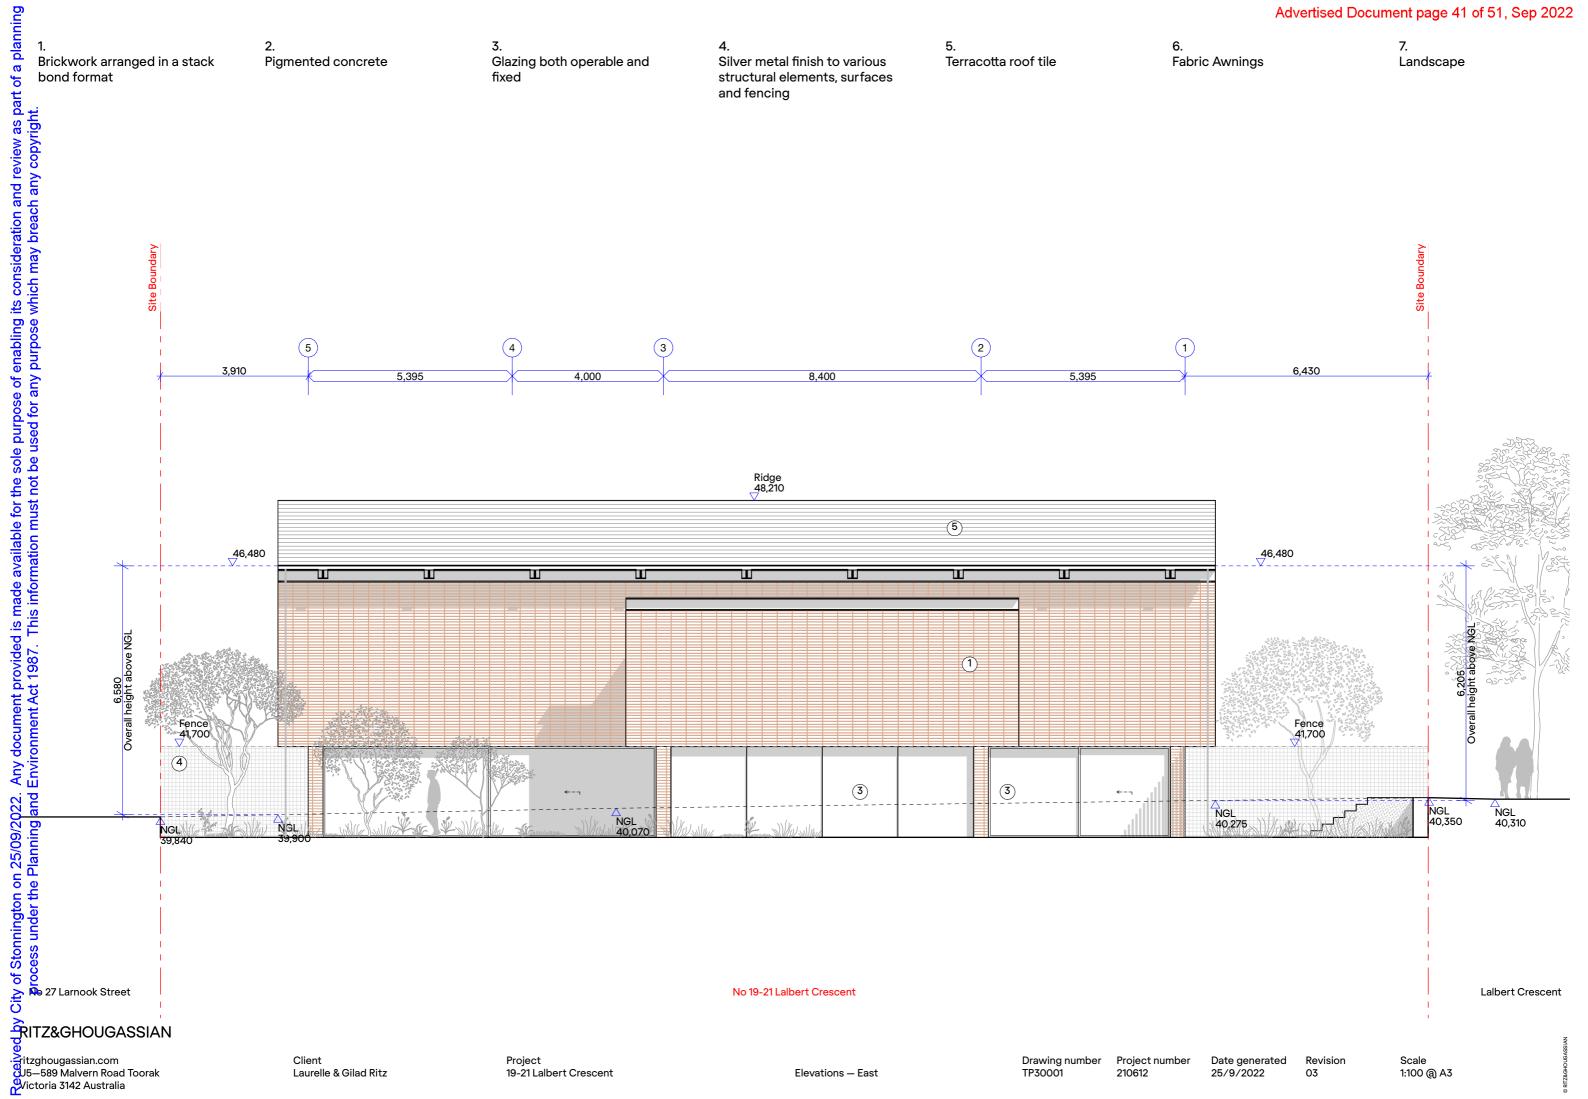


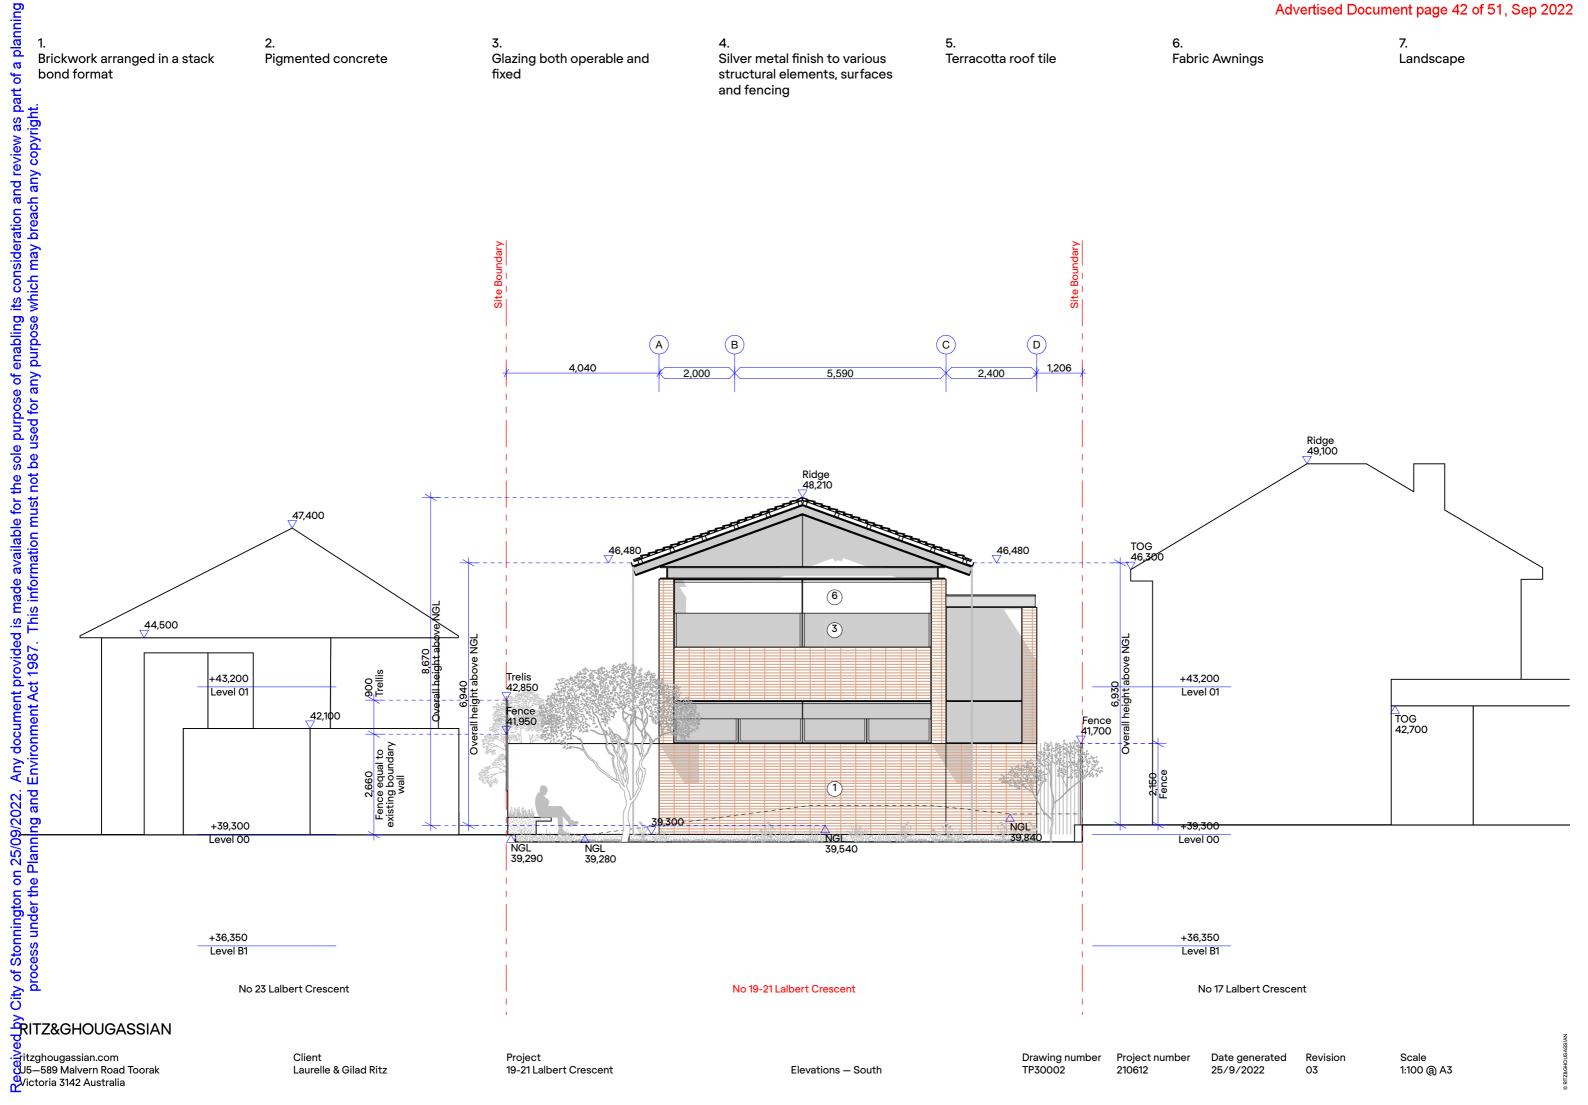


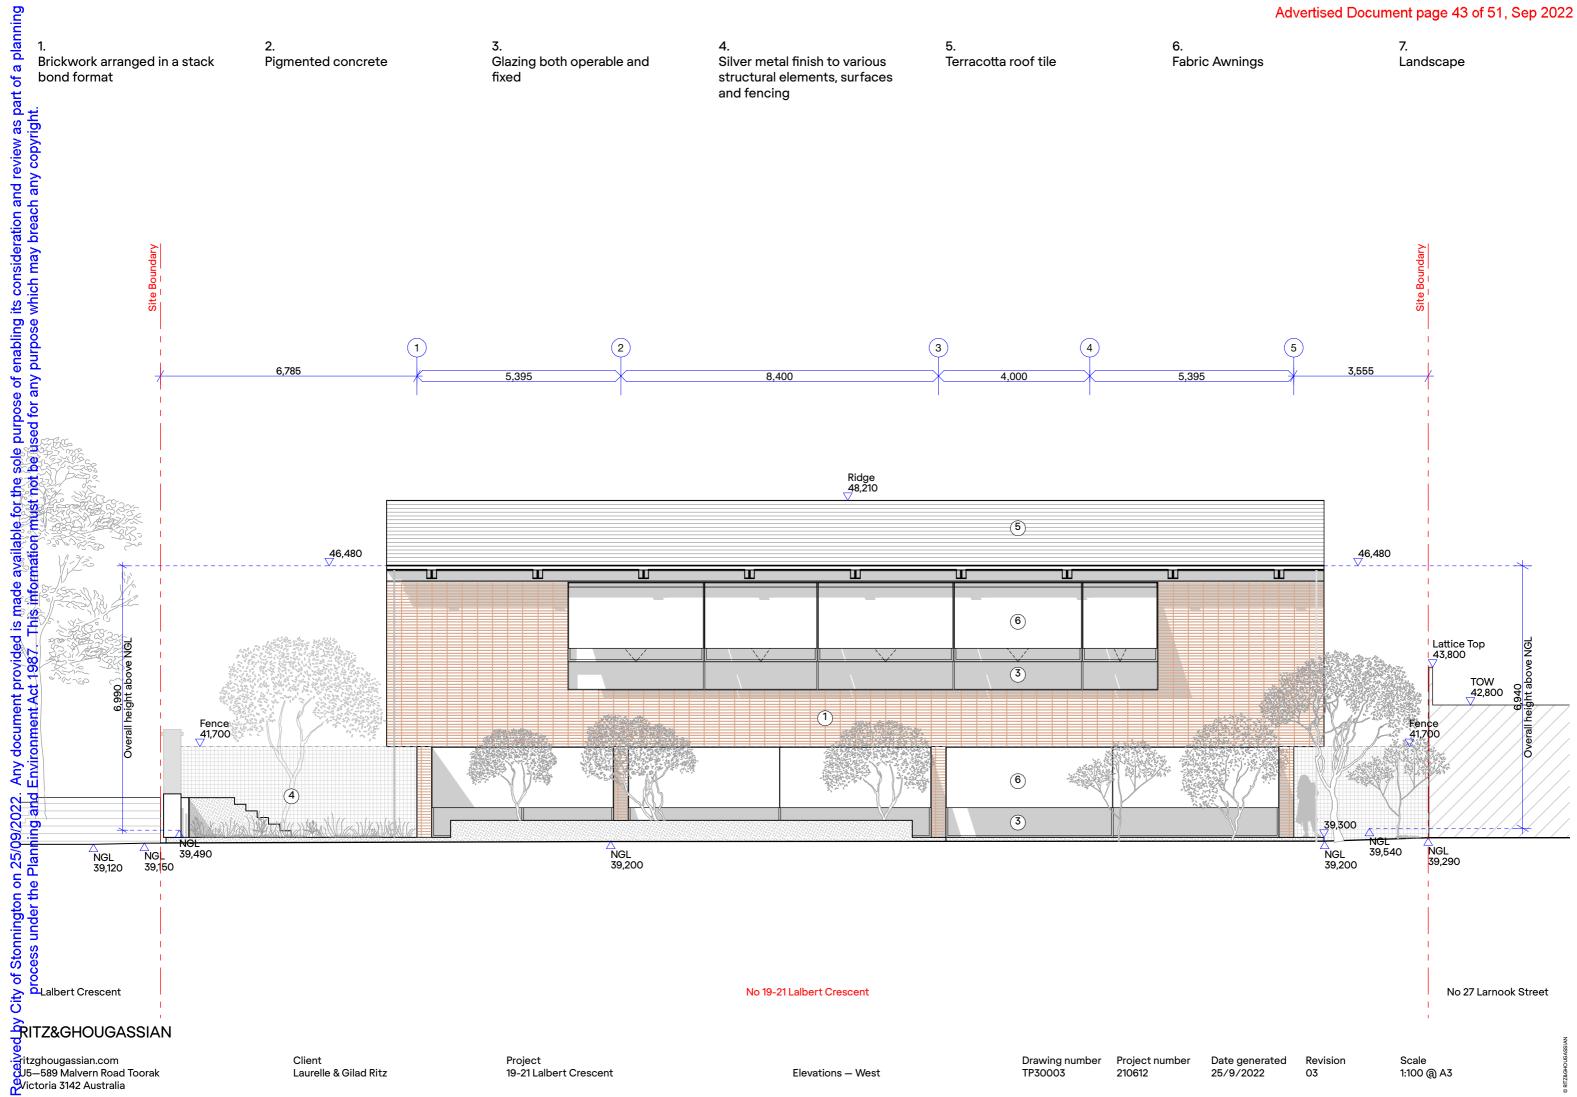

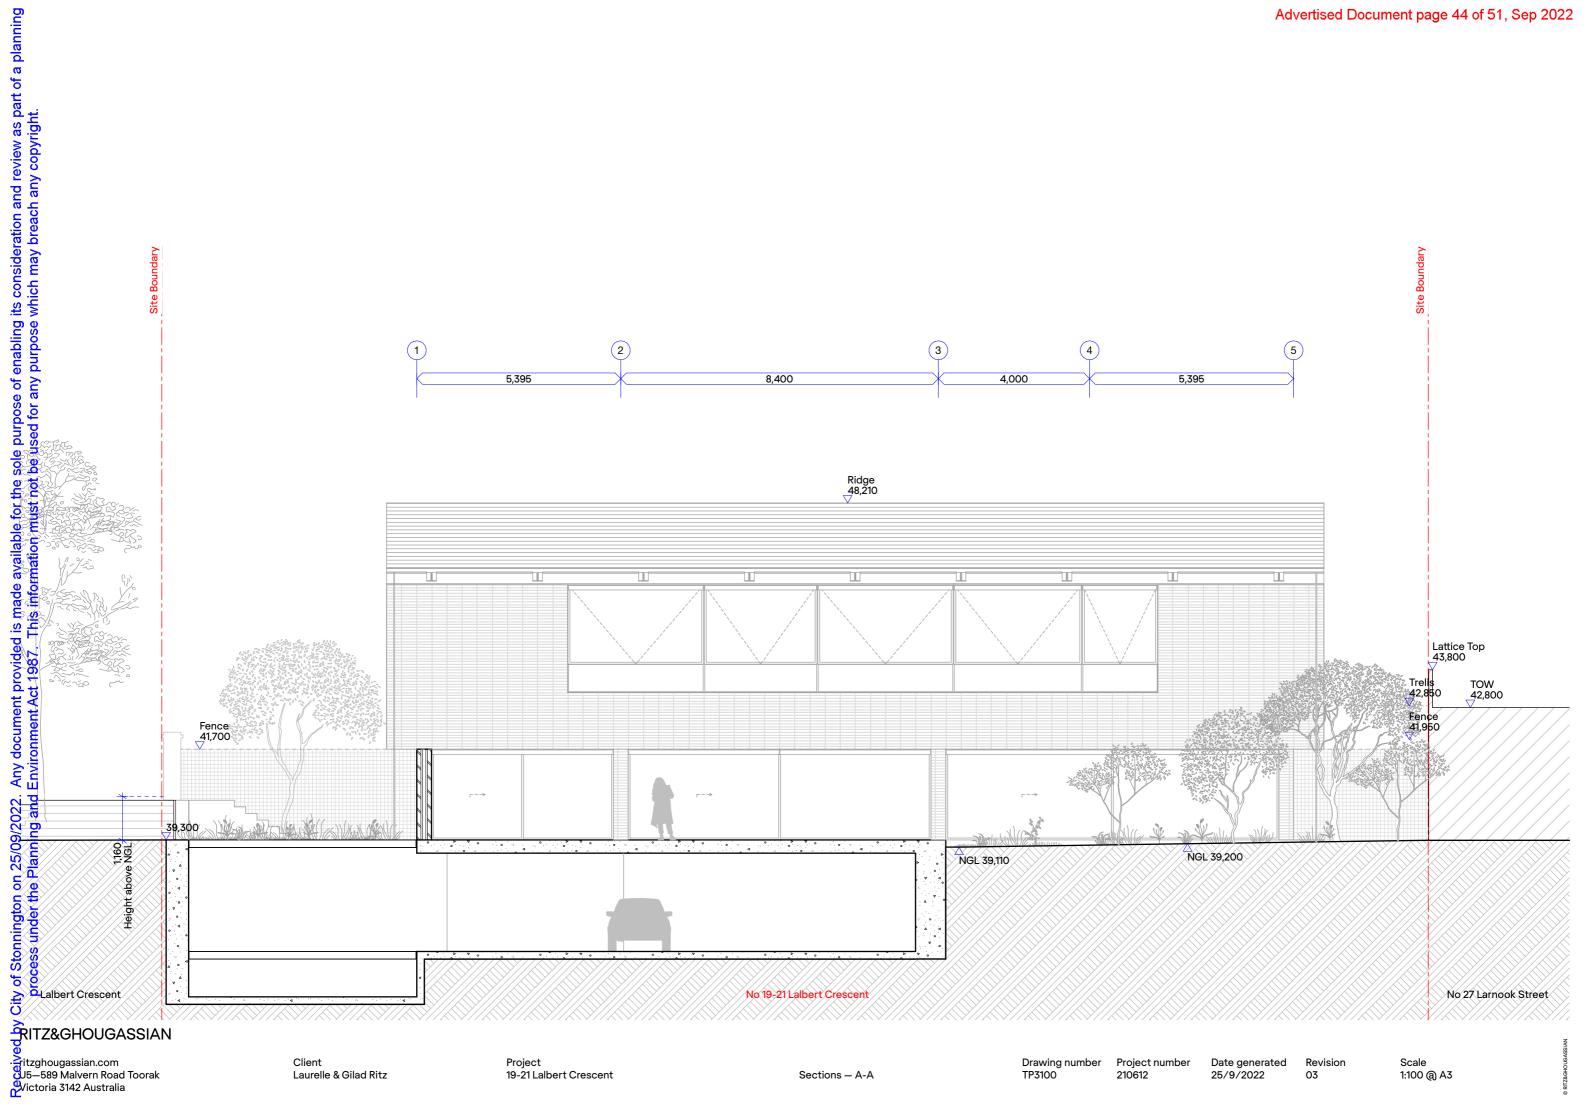

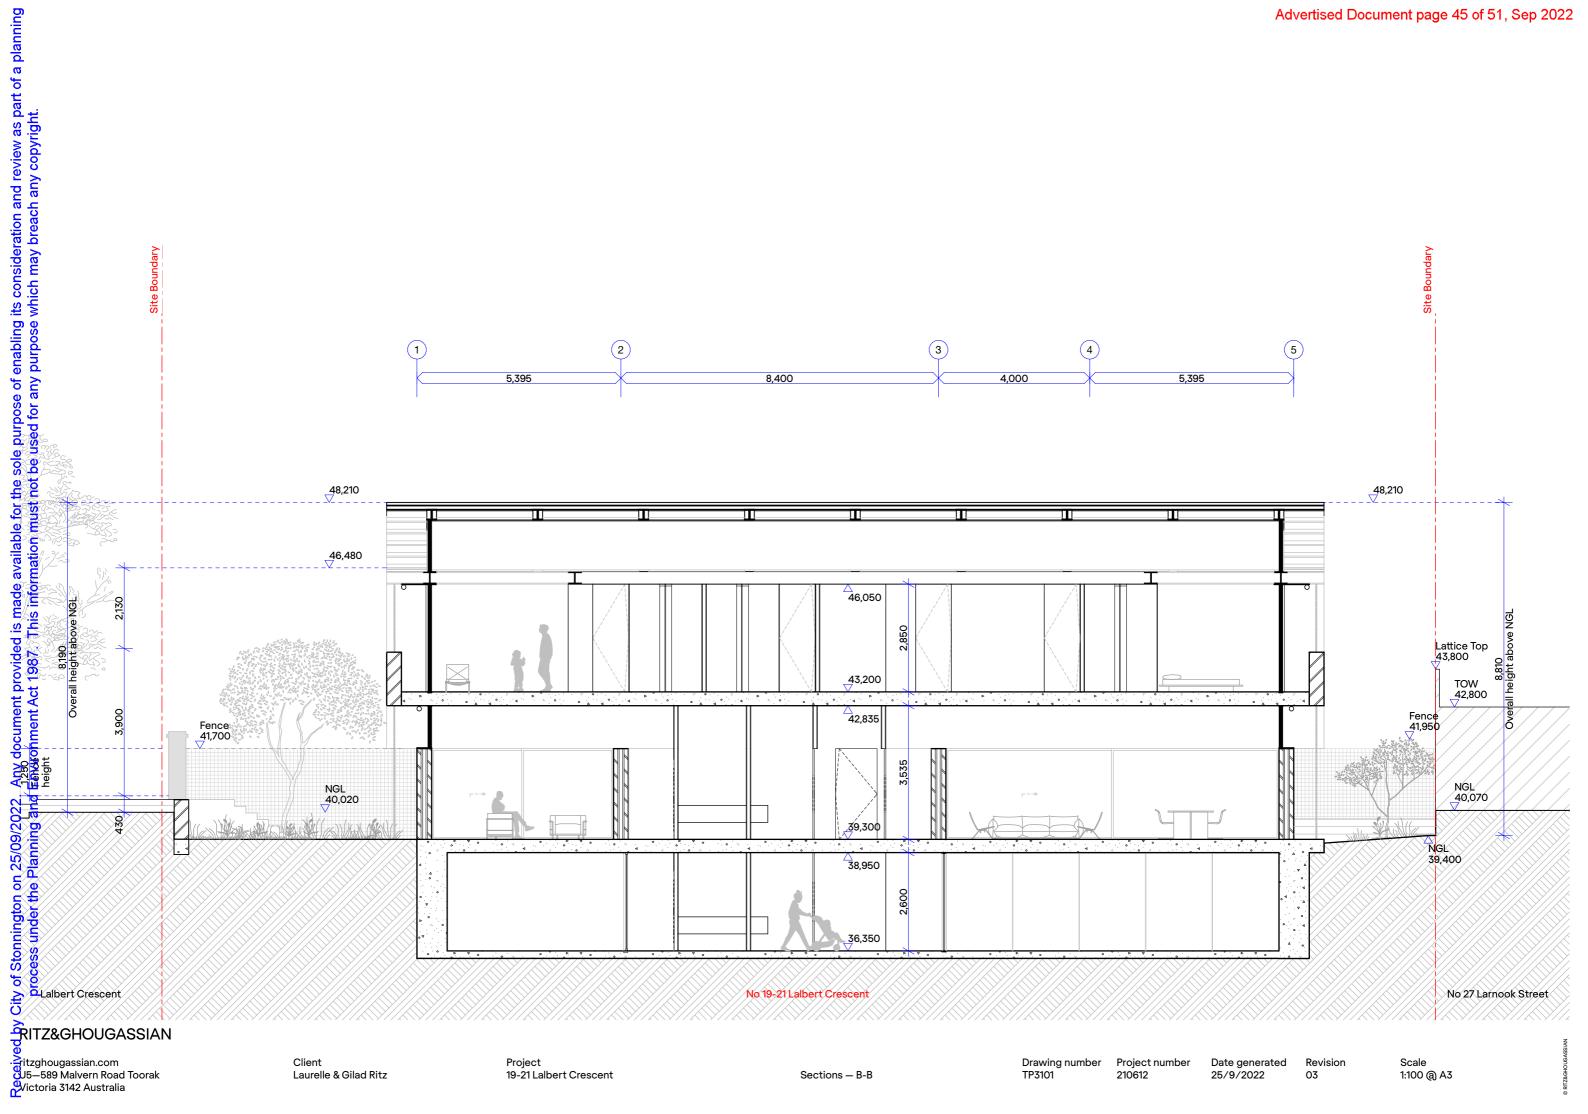

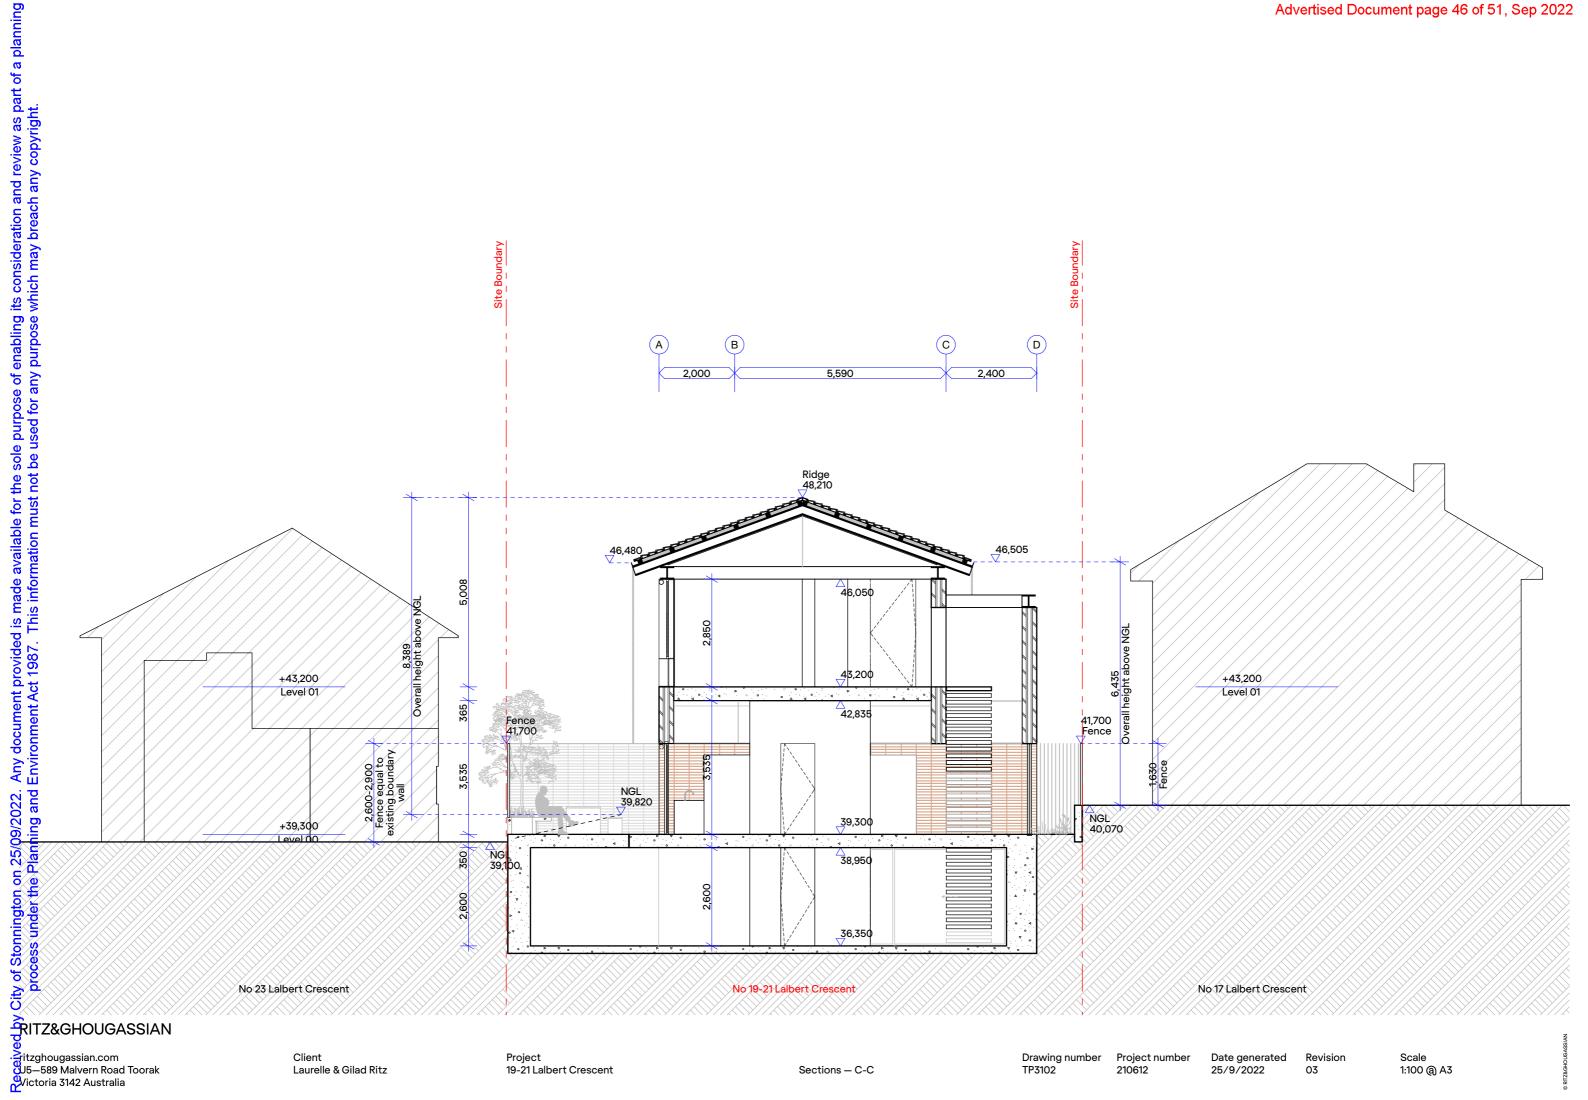

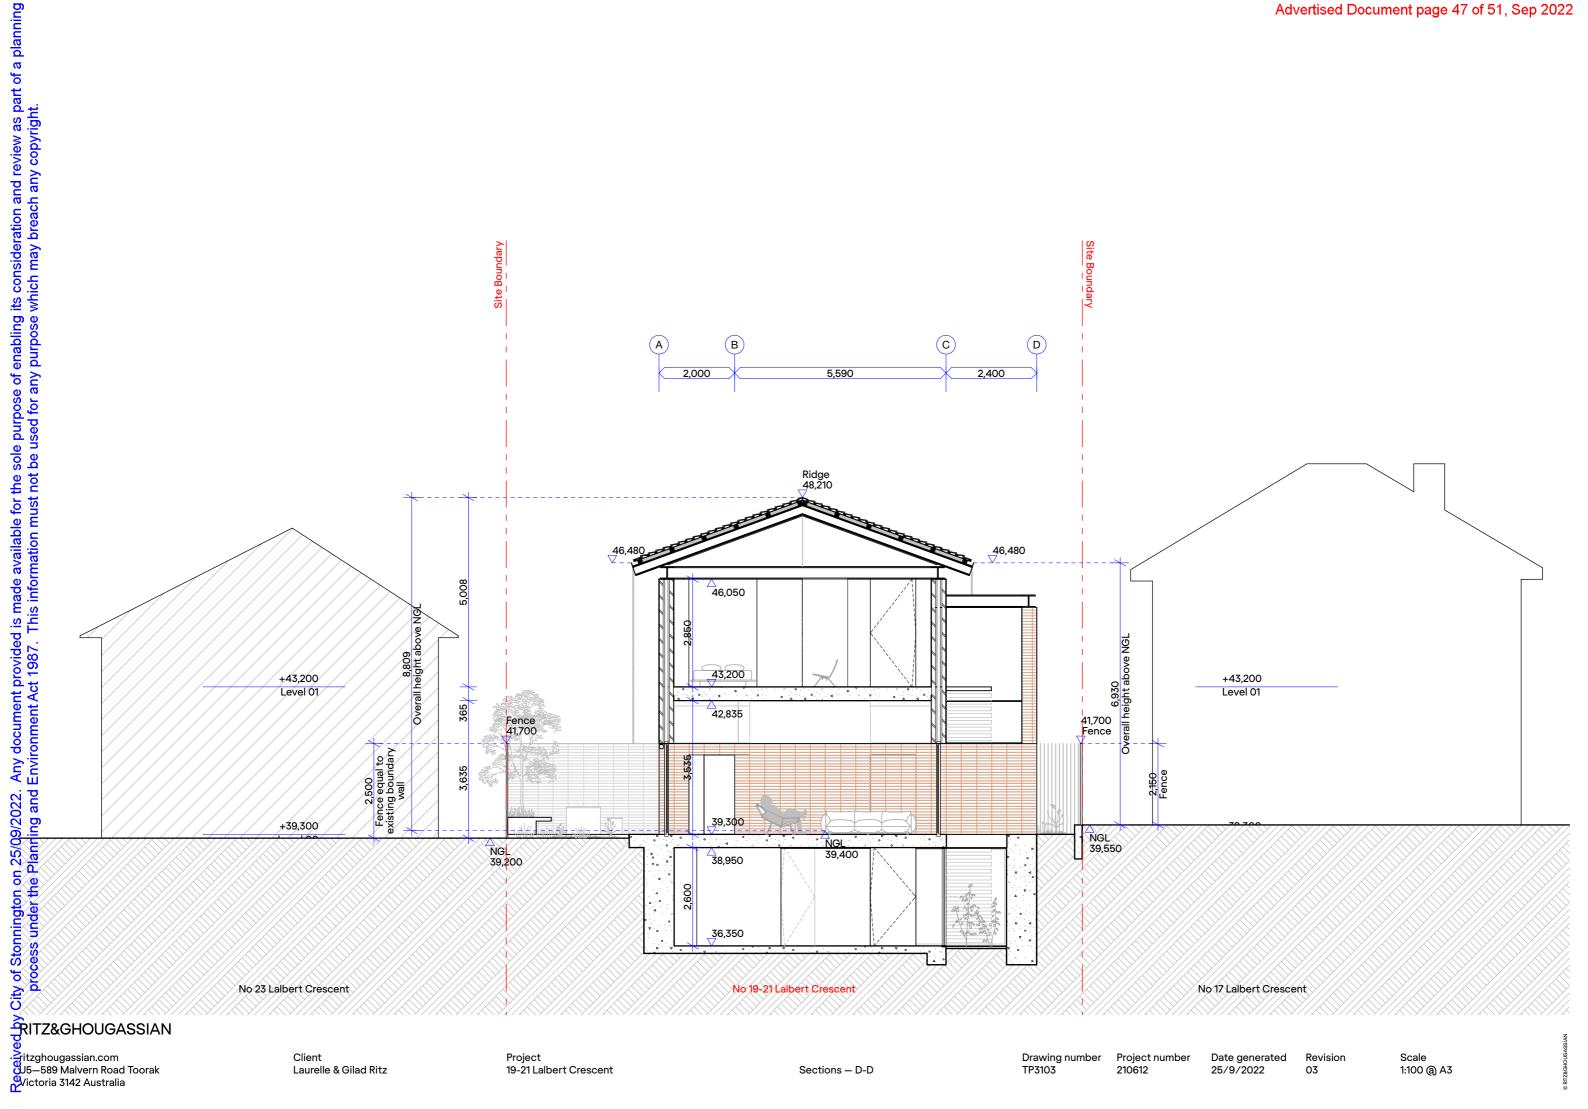

Paving Surfaces



CE

Concrete Paving Slab Pigment complementary to masonry walls



GR

Crushed Rock Permeable Paved Surface

Trees



EU01

Eucalyptus Pauciflora Snow Gum

Native/Evergreen 4×8m Growth 2.0m Planted



EU02

Eucalyptus Pauciflora Little Snowman

Native/Evergreen 4×4m Growth 1.2m Planted

Shrubs



Banksia Robur Swamp Banksia

Native/Evergreen 2×2m Growth 140mm Pot Planted



Correa Alba White Correa

Native/Evergreen 2×2m Growth 200mm Pot Planted

Ground Cover



Poa Labillardieri Eskdale Tussock Grass

Native/Evergreen 0.6×0.55m Growth 140mm Pot Planted

Landscape - Proposed Material Selection



Viola Hederacea Native Violet

Native/Evergreen Spreading Growth 120mm Pot Planted



Scleranthus Biflorus **Cushion Grass**

Native/Evergreen Spreading Growth 140mm Pot Planted

₹RITZ&GHOUGASSIAN

Laurelle & Gilad Ritz

Crushed rock, concrete spillage and any other material restrictive to plant growth (e.g. large rocks) shall be

stump ground and all rubbish/vegetative spoil is to be removed from site. Existing top soil in planting areas

No imported top soil is to be used within the root zones of trees to be protected. Any preparation of existing

is to be preserved so that it does not receive additional compaction from site machinery and so that no

soil for planting within these areas is to be done by hand only. Holes (e.g. as the result of plant removal)

Any imported topsoil is to be free of weeds, rubble and other materials damaging to plant growth and is to

which has had any materials damaging to plant growth (e.g. rubble and large rocks) removed, spread to the

Imported top soil is to be lightly and uniformly compacted in 150mm layers to a minimum depth of 100mm on

All weeds shall be thoroughly removed. All vegetative material, including roots and rhizomes of non-woody

means. The stumps of non-suckering woody perennials are to be stump ground. All vegetative material shall

perennials and woody suckering weeds, is to be removed or appropriately controlled using chemical

be appropriately disposed of off site in a manner which will not allow their re-establishment elsewhere.

Care must be taken to ensure that all trees to be retained are not damaged during weed removal. This also

Planting shall be carried out using accepted horticultural practices with all plants conforming to the species,

soaked through immersion in water prior to planting and if the planting soil is very dry then the planting hole

All plants shall be appropriately hardened off in the nursery. Use plants with the following characteristics:

Large healthy root systems with no evidence of root curl or pot bound restriction or damage, vigorous, well

Planting holes for shrubs and ground covers are to be of minimum size 75mm larger than the planting pot in all directions. Semi-advanced tree planting holes are to be the same depth as the rootball and 2-3 times its diameter, with the top of the rootball being at grade. A 75mm high berm is to be constructed at edge of root-ball to hold water. All plants are to be thoroughly watered after planting and slow release fertiliser

size and quantities indicated on the Landscape Plan and Plant Schedule. Plants shall be thoroughly

established, free from disease and pests and of good form, consistent with the species or variety.

Any chemical controls are to be used in accordance with manufacturer's instructions and standard

implies that any herbicides used are suitable for use around the vegetation to be retained.

be of a medium texture (sandy loam) with a pH of 6.0-7.0. Top soil is to be laid over a prepared sub-base

appropriate depth and cultivated into the existing site soil to a minimum depth of 150mm.

rubble or building supplies are stored in these areas.

lawn areas and 300mm on excavated planting beds.

occupational health and safety procedures.

is also to be filled with water and allowed to drain completely.

added at the quantities specified by the manufacturer

and uneven soil levels may be patched using topsoil as specified below

removed from the site of any planting beds and semi-advanced trees. All trees to be removed shall be

Proiect

19-21 Lalbert Crescent

Drawing number TP8010

Project number Date generated

Revision 03

Scale

Mulch is to be supplied to all garden beds and is to be an organic type laid to a minimum depth of 75mm, consisting of fine dark coloured chipped or shredded pine bark or hardwood with not more than 5% fines content by volume (preferably zero fines). The average size of the wood chip must be approximately 10mm x 20mm x 5mm and the maximum length is not to exceed 30mm. Mulch shall be free of damaging matter such as soil, weeds and sticks and is to be stockpiled and thoroughly weathered prior to delivery. Mulch is to be kept back 100mm from the stems of all plants to prevent collar rot.

Aggregate Gravel Surface

Aggregate gravel is to be installed where shown comprising of a 50mm layer of gravel (7-14mm granite screenings or similar, no fines) over a base course of 75mm deep gently compacted Fine Crushed Rock. The sub-grade is to be appropriately compacted.

Irrigation

Mulch


An approved drip irrigation system is to be supplied to all planter boxes & garden beds. It is the responsibility of the contractor to ensure that all irrigation meets manufacturers specifications. The system is to be connected to mains supply and include a rain-shut off device. All drip line is to be buried with approx. 50mm of topsoil cover and shall be anchored at regular intervals to ensure the tubing cannot be dislodged. Repair/Restoration of damaged Nature-strips

Nature strips are to be restored to current grades with any depressions filled with topsoil to specifications above and lightly compacted in 150mm layers. Areas are then to be re-seeded using an appropriate and matching turf type and the area fenced off to allow the re-establishment of lawn. Re-seeded areas are to be well irrigated and the area supplied with a slow release fertiliser at the quantities recommended by the manufacturer.

Any areas of lawn which have failed to germinate (achieve an evenly green 95% covering of a consistent height) are to be re-seeded within one month of original sowing date.

Plant Establishment

There shall be a 13 weeks Plant Establishment Period following the approval of Practical Completion by the responsible authority. During this period the landscape contractor shall make good all defects in his/her scope of works. Maintenance and Establishment means the care and maintenance of the contract area by accepted horticultural practices, as well as rectifying any defects that become apparent in the work under normal use. This shall include, but shall not be limited to watering, fertilising, weeding, pruning, pest and disease control, cultivation, re-staking and replacement of any plants that fail with plants of the same species and size.

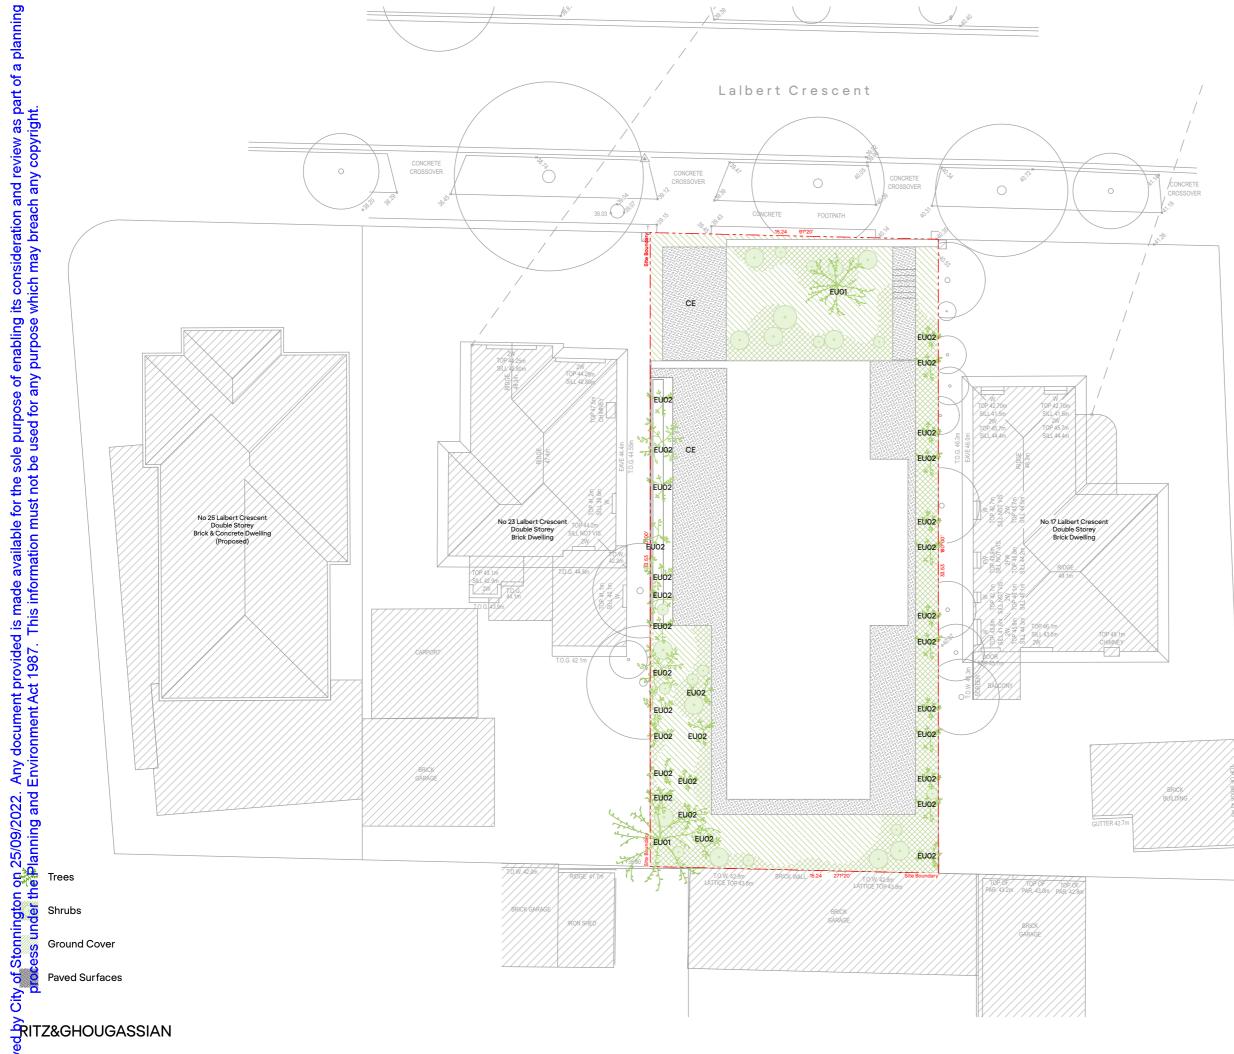

itzghougassian.com U5–589 Malvern Road Toorak Victoria 3142 Australia

Client Laurelle & Gilad Ritz

Project


19-21 Lalbert Crescent

Landscape — Level 00

Drawing number Project number 210612 TP8020

Date generated 25/9/2022 03

Revision Scale 1:200 @ A3

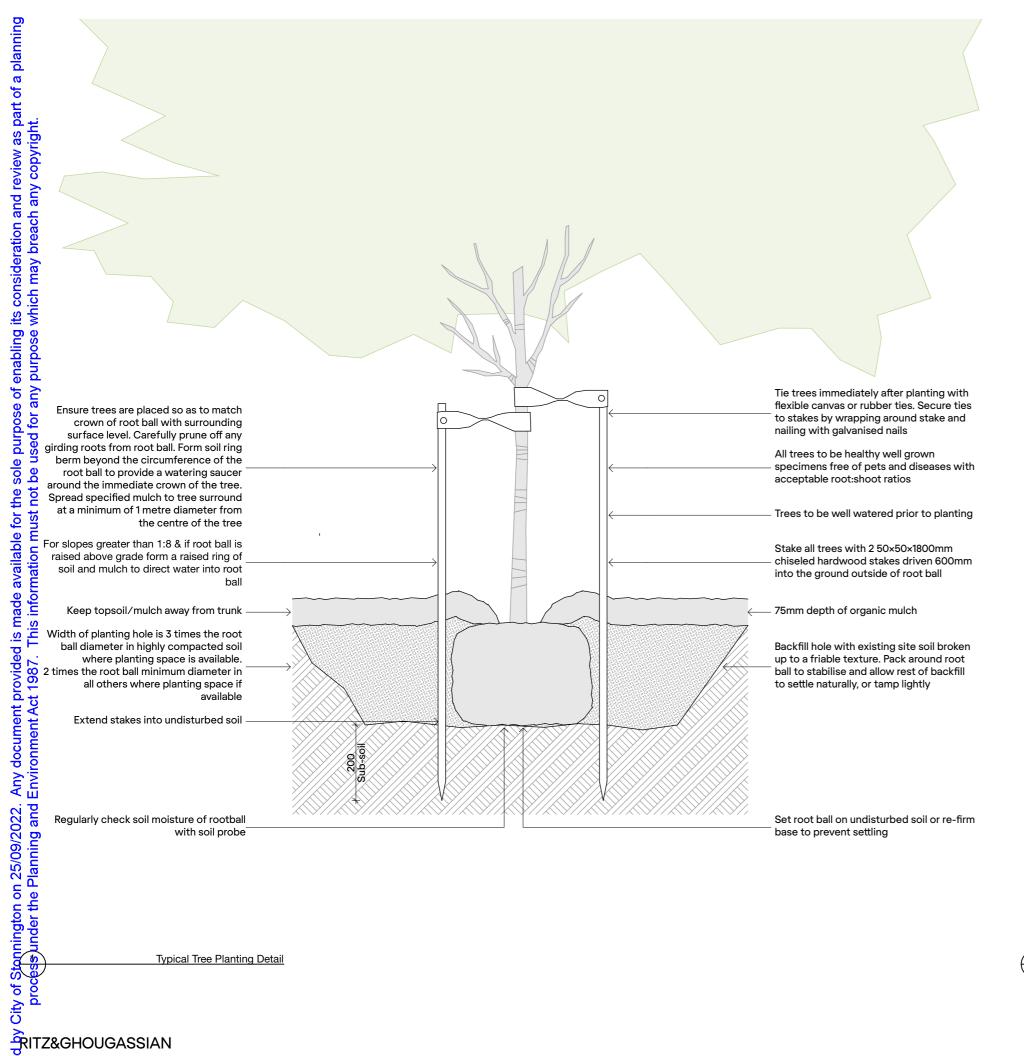

Provide mounded topsoil berm to hold water during maintenance and establishment Mulch to be 75mm in depth of a specified Break up sides and base of hole New topsoil 300mm depth or as specified cultivated into exisitng subsoil min 150mm in depth Dig hole twice as deep as root ball and allow at least 200mm around sides for backfilling with topsoil Apply fertiliser in base of hole, cover with topsoil and avoid root contact Water well into saucer around crown of Place plant at centre of hole. Backfill with specified topsoil. Firming progressively Stake larger shrubs where necessary using 50×50×1200mm hardwood stakes

Typical Shrub Planting Detail

RITZ&GHOUGASSIAN

Typical Tree Planting Detail

ritzghougassian.com J5–589 Malvern Road Toorak Victoria 3142 Australia

TP8050